


# 9820 SE 35TH PLACE MERCER ISLAND, WA. 98040

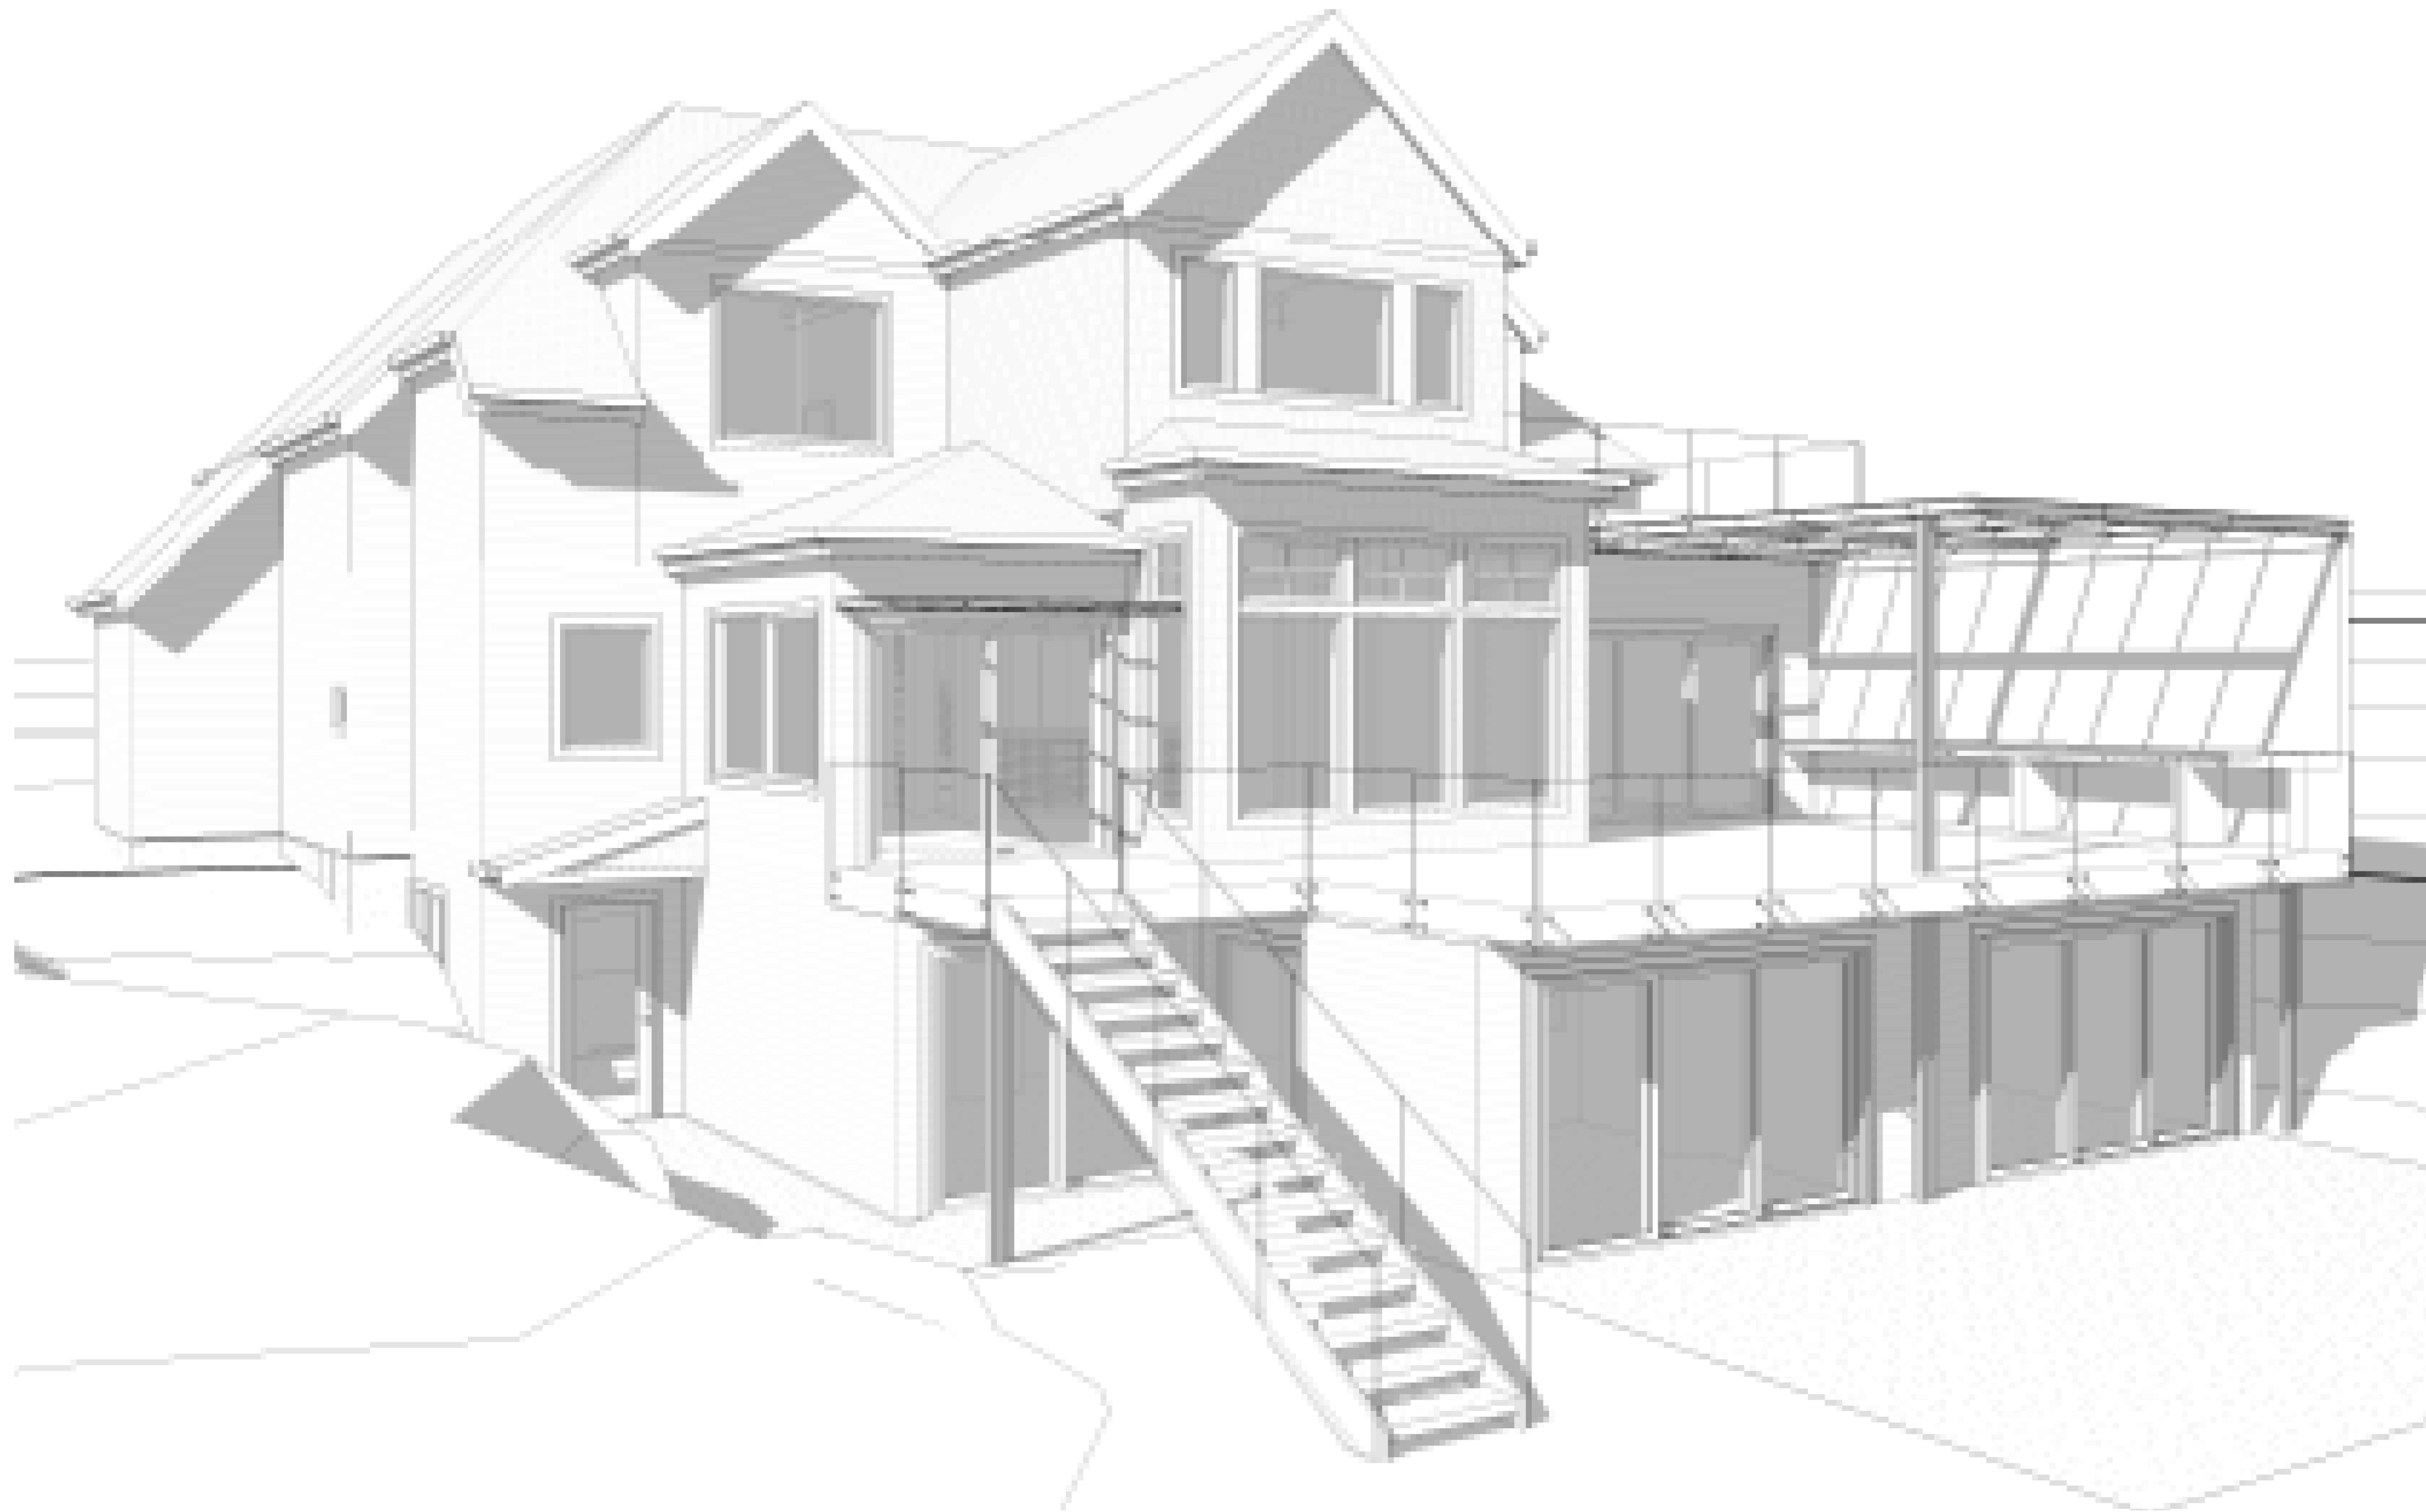

NOTE: 3D RENDERINGS ARE FOR ILLUSTRATIVE PURPOSES ONLY. NOT TO BE USED FOR CONSTRUCTION.

NO EXCAVATION BEYOND FOUNDATIONS CALL 48 HOURS BEFORE YOU DIG 811 OR 1-800-424-5555

## R9.6 BUILDING ZONE REQUIREMENTS

LOT COVERAGE: ALLOWED - 40%  
 HARDSCAPE COVERAGE: ALLOWED 9% + BORROWED AREA  
 GROSS FLOOR AREA: ALLOWED 8,000 SQ. FT.  
 A.B.E. AND MAX HEIGHT: NEW ADDITION AREA  
 A.B.E. AND MAX HEIGHT: NEW DETACHED GARAGE  
 ALLOWED STRUCTURAL DISTURBANCE: 40%

SEE SHEET A0.1  
 SEE SHEET A0.1  
 SEE SHEET A0.1  
 SEE SHEET A0.2  
 SEE SHEET A0.2  
 SEE SHEET A0.2

## CODE INFORMATION

ALL MATERIALS, WORKMANSHIP, DESIGN AND CONSTRUCTION SHALL CONFORM TO THE DRAWINGS, SPECIFICATIONS, AND THE FOLLOWING APPLICABLE CODES USED IN THIS DESIGN FOR CITY OF MERCER ISLAND  
 2015 INTERNATIONAL BUILDING CODE (IBC)  
 2015 INTERNATIONAL RESIDENTIAL CODE (IRC)  
 2015 INTERNATIONAL MECHANICAL CODE (IMC)  
 2015 INTERNATIONAL FUEL GAS CODE (IFGC)  
 2015 INTERNATIONAL FIRE CODE (IFC)  
 WASHINGTON STATE ENERGY CODE, WAC 51-11 (WSEC)  
 2015 UNIFORM PLUMBING CODE (UPC)  
 2014 NATIONAL ELECTRIC CODE (NEC)  
 2015 NATIONAL FUEL GAS CODE (NFGC) NFPA 54, WAC

## BUILDING CLASSIFICATION

A. OCCUPANCY CLASSIFICATION: SINGLE FAMILY RESIDENCE  
 B. TYPE OF CONSTRUCTION:  
 1. AUTOMATIC SPRINKLERS PROVIDED YES X NO  
 SPRINKLER SYSTEM TO BE A FLOW THRU SYSTEM

THIS HOUSE HAS A FIRE ALARM SYSTEM INSTALLED.

## ENERGY CODE COMPLIANCE

GENERAL PRESCRIPTIVE METHOD:  
 SEE SHEETS A0.2, A0.3 & A5.0  
 ENERGY CREDITS PER TABLE 406.2.1:  
 ADDITION TO EXISTING BUILDING GREATER THAN 500sf<1500sf  
 OPTION 5c EFFICIENT WATER HEATING - GAS WATER HEATER, MIN. EF 0.91 1.5 CREDITS  
 TOTAL CREDITS REQUIRED SMALL DU: 1.5 CREDITS  
 TOTAL CREDITS PROPOSED: 1.5 CREDITS

## ZONING & CODE INFORMATION

JURISDICTION: CITY OF MERCER ISLAND  
 ZONING: R9.6  
 PARCEL ASSESSOR'S #: 082405-9027

## LEGAL DESCRIPTION:

LOT 1 TGW SH LIDS ADJ MERCER ISLAND SHORT PLAT NO 82-11-26 REC NO 8303109004 - LESS POR THOF LY NLY AND WLY OF FOLG DESC LN -- COMM AT NW COR OF SD LOT 1 TH S 88-49-28 E ALG NOTRH LAN THOF A DIST OF 82.40 FT TO TPOB OF HEREIN DESC LN TH S 01-10-32 W 4.54 FT TH S 64-49-53 W 9.36 FT TH N 88-49-28 W 21.64 FT TH S 64-21-02 W 8.31 FT TH S 51-11-48 W 14.70 FT TH N 88-49-28 W 33.69 FT TO WEST LN OF SD LOT 1 AND THE TERMINUS OF HEREIN DESC LN AKA "LOT 1" OF MERCER ISLAND LOT LINE ADJUSTMENT NO SUB01-009 REC NO 20021125900027 LY IN STR 08-24-05

OCCUPANCY: SINGLE FAMILY

## SETBACKS AT REMODEL / ADDITION:

REMODEL CHANGES ARE LESS THAN 40% OF THE EXTERIOR (SEE CALCULATION SHT) REFER TO PREVIOUS PERMIT #9908-047 APPROVED SITE PLAN 9-10-99 PER PRE-APPLICATION PERMIT #PRE20-038 EXISTING SETBACKS ARE VESTED

## NEW CONSTRUCTION:

2 CAR DETACHED GARAGE- FRONT YARD: 20'-0" SIDE YARD: 10'-0"

## PARKING REQUIRED:

2.0 PER DWELLING UNIT

## PARKING PROVIDED:

2.0 IN ATTACHED GARAGE  
 2.0 IN NEW DETACHED GARAGE

## PROJECT DESCRIPTION:

ADDITION AND REMODEL TO SINGLE FAMILY RESIDENCE + DETACHED 2 CAR GARAGE

## PROJECT CONTACT INFORMATION

OWNER: MARY & ACHIH CHEN  
 9820 SE 35TH PLACE  
 MERCER ISLAND, WA. 98040  
 P: 706-726-3333  
 E: maryrchen@yahoo.com

## CONTRACTOR:

T.B.D.

## ARCHITECT:

MEDICI ARCHITECTS  
 EMILY BUCHWALTER, AIA  
 11711 SE 8TH ST., SUITE 100  
 BELLEVUE, WA 98005  
 P: 425-453-9298  
 E: priscilla@mediciarchitects.com

## STRUCTURAL ENGINEER:

FOSSATTI PAWLAK STRUCTURAL ENGINEERS  
 PETE PAWLAK  
 1735 WESTLAKE AVE N., SUITE 205  
 SEATTLE, WA 98109  
 P: 206-456-3071  
 E: ppawlak@fossatti.com

## CIVIL ENGINEER:

CIVIL ENGINEERING SOLUTIONS  
 ELLIS DUFFY, PE  
 102 NW CANAL STREET  
 SEATTLE, WA. 98107  
 P: 206-930-0342  
 E: duffy@cesolutions.us

## ARBORIST:

OLYMPIC NURSERY, INC.  
 TOM QUIGLEY  
 ISA CERTIFIED ARBORIST PN0655A  
 P: 206-850-2643  
 E: tqigley@msn.com

## SURVEYOR:

INFORMED LAND SURVEY  
 EVAN WAHLSTROM  
 P. O. BOX 5137  
 TACOMA, WA. 98415  
 P: 253-627-2070  
 E: ewahlstrom@landsurvey.com

## GEOTECHNICAL ENGINEER:

GEO GROUP NW  
 ADAM GASTON  
 13705 BEL-RED ROAD  
 BELLEVUE, WA. 98005  
 P: 425-649-8757  
 E: agaston@geogroupnw.com



## VICINITY MAP

NTS PROJECT LOCATION



## QT. SECT. MAP

NTS PROJECT LOCATION

## DRAWING SHEET INDEX

CITY OF MERCER ISLAND COVER SHEET	
A0.0	TITLE SHEET
A0.1.0	SITE PLAN
A0.2	SITE PLAN CALCULATIONS
A0.3	GENERAL NOTES
A0.4	SCHEDULES
D1.0-D1.3	DEMOLITION PLANS
A1.0	FOUNDATION PLAN
A1.1	BASEMENT PLAN
A2.0	1ST FLOOR CONSTRUCTION PLAN
A2.1	2ND FLOOR CONSTRUCTION PLAN
A3.0	ROOF PLAN
A4.0-A4.1	ELEVATIONS
A5.0	SECTIONS
A6.0	DETAILS
A7.0	DETACHED GARAGE FLOOR & ROOF PLAN
A7.1	DETACHED GARAGE ELEVATIONS

## STRUCTURAL SHEET INDEX


S2.1	FOUNDATION PLAN
S2.2	1ST FLOOR FRAMING PLAN
S2.3	2ND FLOOR FRAMING PLAN
S2.4	ROOF FRAMING PLAN
S3.1	CONCRETE DETAILS
S4.1	SECTIONS
S4.2	SECTIONS

## CIVIL SHEET INDEX

C1.0	EROSION CONTROL PLAN
	TREE RETENTION PLAN
C1.2	TESC & CITY NOTES
	TESC DETAILS
C2.0	DRAINAGE / CIVIL PLAN
C3.5	BMP DETAILS

## SURVEY:

TOPOGRAPHIC SURVEY INCLUDED

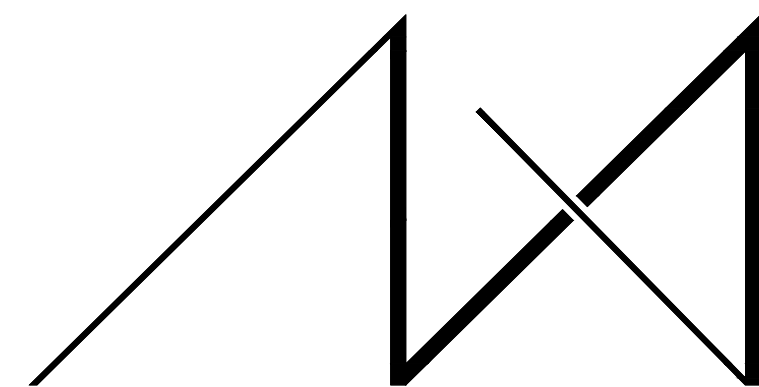

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## REGISTRATION:



## INTAKE: DATE:

## REVISIONS: DATE:

1.	
2.	
3.	
4.	
5.	

## PROJECT / CLIENT:

### 9820 SE 35TH PLACE

ACHIN & MARY CHEN  
 9820 SE 35TH PLACE  
 MERCER ISLAND, WA 98040

## JOB ADDRESS:

9820 SE 35TH PLACE  
 MERCER ISLAND, WA 98040  
**PARCEL # 082405-9027**

## DRAWING NAME:

## TITLE SHEET

Drawn By: JMG, RB  
 Checked By: EB  
 Owner Approval:

## PHASE:

## CONSTRUCTION DOCUMENTS

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## APPROVED FOR CONSTRUCTION:

## DEFERRED SUBMITTAL:

THE FOLLOWING ITEMS ARE CONSIDERED TO BE A DEFERRED SUBMITTAL UNDER SECTION 107.3.4.1 OF THE IBC AND MUST BE SUBMITTED TO THE ENGINEER FOR REVIEW. THESE ITEMS WILL THEN BE FORWARDED TO THE BUILDING OFFICIAL FOR APPROVAL. THE DEFERRED SUBMITTAL ITEMS SHALL NOT BE INSTALLED UNTIL THE DESIGN AND SUBMITTAL DOCUMENTS HAVE BEEN APPROVED BY THE BUILDING OFFICIAL. \*PRE-ENGINEERED INTERIOR STEEL STAIRS, HANDRAILS, BALCONY GUARDS, EXTERIOR STEEL STAIRS, STEEL FRAME CANOPY. ELECTRICAL, MECHANICAL AND PLUMBING.

## PROJECT No.: 2020 007

DATE: 12-22-2020

PLOT SCALE: 1:1

A0.0

# 9820 SE 35TH PLACE, MERCER ISLAND, WA. 98040

## TREE PROTECTION GUIDELINES

All remaining trees are to have a tree protection zone (TPZ) established before commencement of any construction or delivery activities. The following guidelines are to be observed and practiced during all construction activities.

- Access is to be restricted into TPZ's with readily visible temporary tree fencing along the LOD which completely surrounds the protected areas of retained trees. Fences shall be constructed of chain link and be at least 4 ft tall, constructed using pier block, and major roots should be avoided while staking.
- Highly visible signs spaced no further than 15 feet shall be placed along sides of the TPZ fencing.
- Construction materials or supplies, soil, debris, vehicles, and equipment are not to be parked or stored within TPZ.
- TPZ fences must be inspected prior to the beginning of any construction activities.
- Assess crew and contractor penalties, if necessary, to keep the TPZ's intact.
- Check the integrity of TPZ fences weekly, and repair or replace as needed.
- Wood chips should be used if possible to spread above root zones within the TPZ's to a depth of 6-8 inches for temporary protection.
- Cement trucks must not deposit waste or rinse out trucks in the TPZ.
- Avoid grade changes or trenching within or near the TPZ. If it is unavoidable, then follow the guidelines below.
- TPZ's may only be moved or accessed with permission from City Officials, and any work done within TPZ's must be done with a certified arborist present.
- If roots need to be pruned, they should be cut with pruning saws, made flush with the side of the trench.
- Trees should be watered twice a week if construction is to take place during hot summer months.

If excavation occurs within the driplines of trees scheduled for retention, the following procedures must be followed to protect them:

- The contractor shall verify the vertical and horizontal location of existing utilities to avoid conflicts and maintain minimum clearances; adjustment shall be made to the grade of the new utility as required.
- The inner root zone shall not be disturbed or cut (inner root zone = half the drip line radius).
- ISA Certified arborist must work with equipment operators during trenching/ excavation. The Arborist should have a shovel, hand pruners, loppers, handsaw, and a sawsall.
- If roots one inch or larger are damaged by equipment, the Arborist shall stop the equipment and have the dirt excavated by hand until the root can be cleanly cut. A clean straight cut shall be made to remove the damaged portion of root, and if possible the roots should be covered in moist burlap until recovered with dirt the same day.
- Boring or tunneling under roots of existing trees is a viable alternative to trenching through roots. It shall be performed under the supervision of an ISA Certified Arborist, and no roots 1 inch in diameter or larger shall be cut.
- The grade shall not be elevated or reduced within the critical root zone of trees to be preserved without the Planning Official's authorization based on recommendations from a qualified professional. The Planning Official may allow coverage of up to one half of the area of the tree's critical root zone with light soils (no clay) to the minimum depth necessary to carry out grading or landscaping plans, if it will not imperil the survival of the tree. Aeration devices may be required to ensure the tree's survival.

TREE RETENTION/ PROVISION CALCULATION					
EXISTING ON-SITE TREES		RETAIN	REMOVE	DBH	CREDIT
TREE #1	FLOWERING CHERRY	X		12"	2
TREE #2	Cedrus Atlantica, Atlas Cedar	X		29.5"	10
TREE #3	Quercus, Pin Oak	X		24.8"	8
TREE #4	Acer palmatum, Japanese Maple	X		12.5"	2
TREE #5	Acer palmatum, Japanese Maple		X	11.0"	1
TREE #6	Cedrus Atlantica, Atlas Cedar	X		26.0"	9
TREE #7	Acer Macrophyllum, Big Leaf Maple	X		17.4"	4
TREE #8	Fraxinus, Ash	X		21.0"	6
TREE #9	Fraxinus, Ash	X		14.0"	3
<b>NEW TREES TO REPLACE REMOVED</b>					
TREE #10	Amelanchier Alnifolia, Western Serviceberry	X (NEW REPLACEMENT)		2"	
TREE #11	Amelanchier Alnifolia, Western Serviceberry	X (NEW REPLACEMENT)		2"	
<b>EXISTING OFF-SITE TREES w/ OVERHANGING LIMBS</b>					
TREE # OS 1	Cupressocyparis Leylandii, Layland	X		est 18"	
TREE # OS 2	Cupressocyparis Leylandii, Layland	X		est 21"	
TREE # OS 3	Populus Nigra, Black Cottonwood	X		est 44"	
<b>TOTAL CREDITS PROPOSED</b>					45
<b>LOT SIZE</b>				0.50	ACRES
<b>TREES PER ACRE</b>	PER KZC 95.33			30.0	
<b>TOTAL CREDITS REQUIRED</b>					15.0
SUPPLEMENTAL TREES TO MEET MINIMUM SIZE WORTH ONE TREE CREDIT AS OUTLINED IN KZC 95.33(4)					



LOT COVERAGE		
LOT SIZE	21,700	SF
LOT COVERAGE ZONE % - RS 9.6 <15% SLOPE - 40%	8,680	SF
EXISTING LOT COVERAGE		
MAIN STRUCTURE ROOF AREA	2,374	SF
VEHICULAR USE	2,759	SF
TOTAL EXISTING LOT COVERAGE	5,133	SF
NEW LOT COVERAGE		
EXISTING LOT COVERAGE REMOVED	(539)	SF
MAIN STRUCTURE ROOF AREA	170	SF
ACCESSORY STRUCTURE ROOF AREA	608	SF
VEHICULAR USE	232	SF
COVERED PATIOS/DECKS	52	SF
NEW LOT COVERAGE	1,062	SF
TOTAL LOT COVERAGE AREA	6,734	SF
%	26.07%	
HARDSCAPE COVERAGE		
LOT SIZE	21,700	SF
BORROWED FROM LOT COVERAGE	3,024	SF
HARDSCAPE AREA ALLOWED = 9%+ BORROWED AREA	4,977	SF
% HARDSCAPE AREA ALLOWED	22.94%	
EXISTING HARDSCAPE COVERAGE		
UNCOVERED DECKS	468	SF
UNCOVERED PATIOS	1,007	SF
WALKWAYS	260	SF
STAIRS	451	SF
ROCKERIES/RETAINING WALLS	181	SF
HARDSCAPE COVERAGE	2,367	SF
HARDSCAPE AREAS REMOVED	728	SF
NEW HARDSCAPE COVERAGE		
UNCOVERED DECKS	-	SF
UNCOVERED PATIOS	32	SF
DOCK PATH	233	SF
STAIRS	49	SF
TOTAL NEW HARDSCAPE COVERAGE	314	
TOTAL HARDSCAPE AREA	1,953	SF
TOTAL HARDSCAPE %	9.00%	
GROSS LOT COVERAGE %	35.07%	
GROSS LOT COVERAGE CHANGE		
EXISTING LOT COVERAGE	5133	SF
EXISTING HARDSCAPE COVERAGE	2367	SF
TOTAL EXISTING GROSS COVERAGE	7500	SF
REMOVED EXIST. LOT COVERAGE	539	SF
REMOVED EXIST. HARDSCAPE	728	SF
TOTAL REMOVED COVERAGE	1267	SF
NEW LOT COVERAGE	1062	SF
NEW HARDSCAPE COVERAGE	314	SF
TOTAL NEW COVERAGE	1376	SF
NET GROSS COVERAGE CHANGED	109	SF

GROSS FLOOR AREA CALCULATION ZONE R9.6 (FROM OUTSIDE PERIMETER OF THE EXTERIOR WALLS)				
FLOOR	EXIST. AREA	REMOVED AREA	NEW/ADD AREA	TOTAL
UPPER FLOOR	1,430		100	1,530
MAIN FLOOR	1,677		67	1,744
GROSS BASEMENT AREA	1,290	681	380	989
GARAGE	505			505
STAIR CASE GFA MODIFIER			92	92
TOTAL BUILDING AREA	4,902	681	639	4,860
ACCESSORY BUILDING			576	576
<b>LOT AREA</b>	<b>ZONE</b>	<b>ALLOWED GROSS FLOOR AREA (SF)</b>	<b>ALLOWED GROSS FLOOR AREA (%)</b>	
21,700	R9.6	8,000	36.87%	
PROPOSED GROSS FLOOR AREA SQUARE FOOTAGE:				5,436
PROPOSED GROSS FLOOR AREA PERCENTAGE:				25.05%

FIRE AREA CALCULATION (FROM INSIDE PERIMETER OF THE EXTERIOR WALLS)		
AREA		SQ. FTG.
BASEMENT		1,623
1st FLOOR		1,663
2nd FLOOR		1,756
ATTACHED GRAGE		486
COVERED PORCH		64
COVERED DECKS		363
COVERED PATIO		126
TOTAL FIRE SF:		6,081

**SYMBOL LEGEND:**

- CG 386.0' FINISHED GRADE
- EG 386.0' EXISTING GRADE
- TOW 386.0' TOP OF WALL
- BOW 386.0' BOTTOM OF WALL
- ABE RECTANGLE
- ABE RECTANGLE MIDPOINT
- TREES
- TREE DRIPLINE
- TREE TO BE REMOVED
- POWER POLE WITH LIGHT
- CONCRETE
- BM BENCH MARK
- SSMH SANITARY SEWER MANHOLE
- BEARING

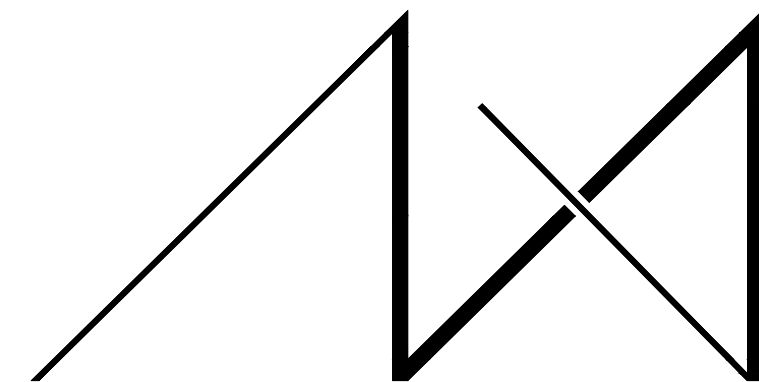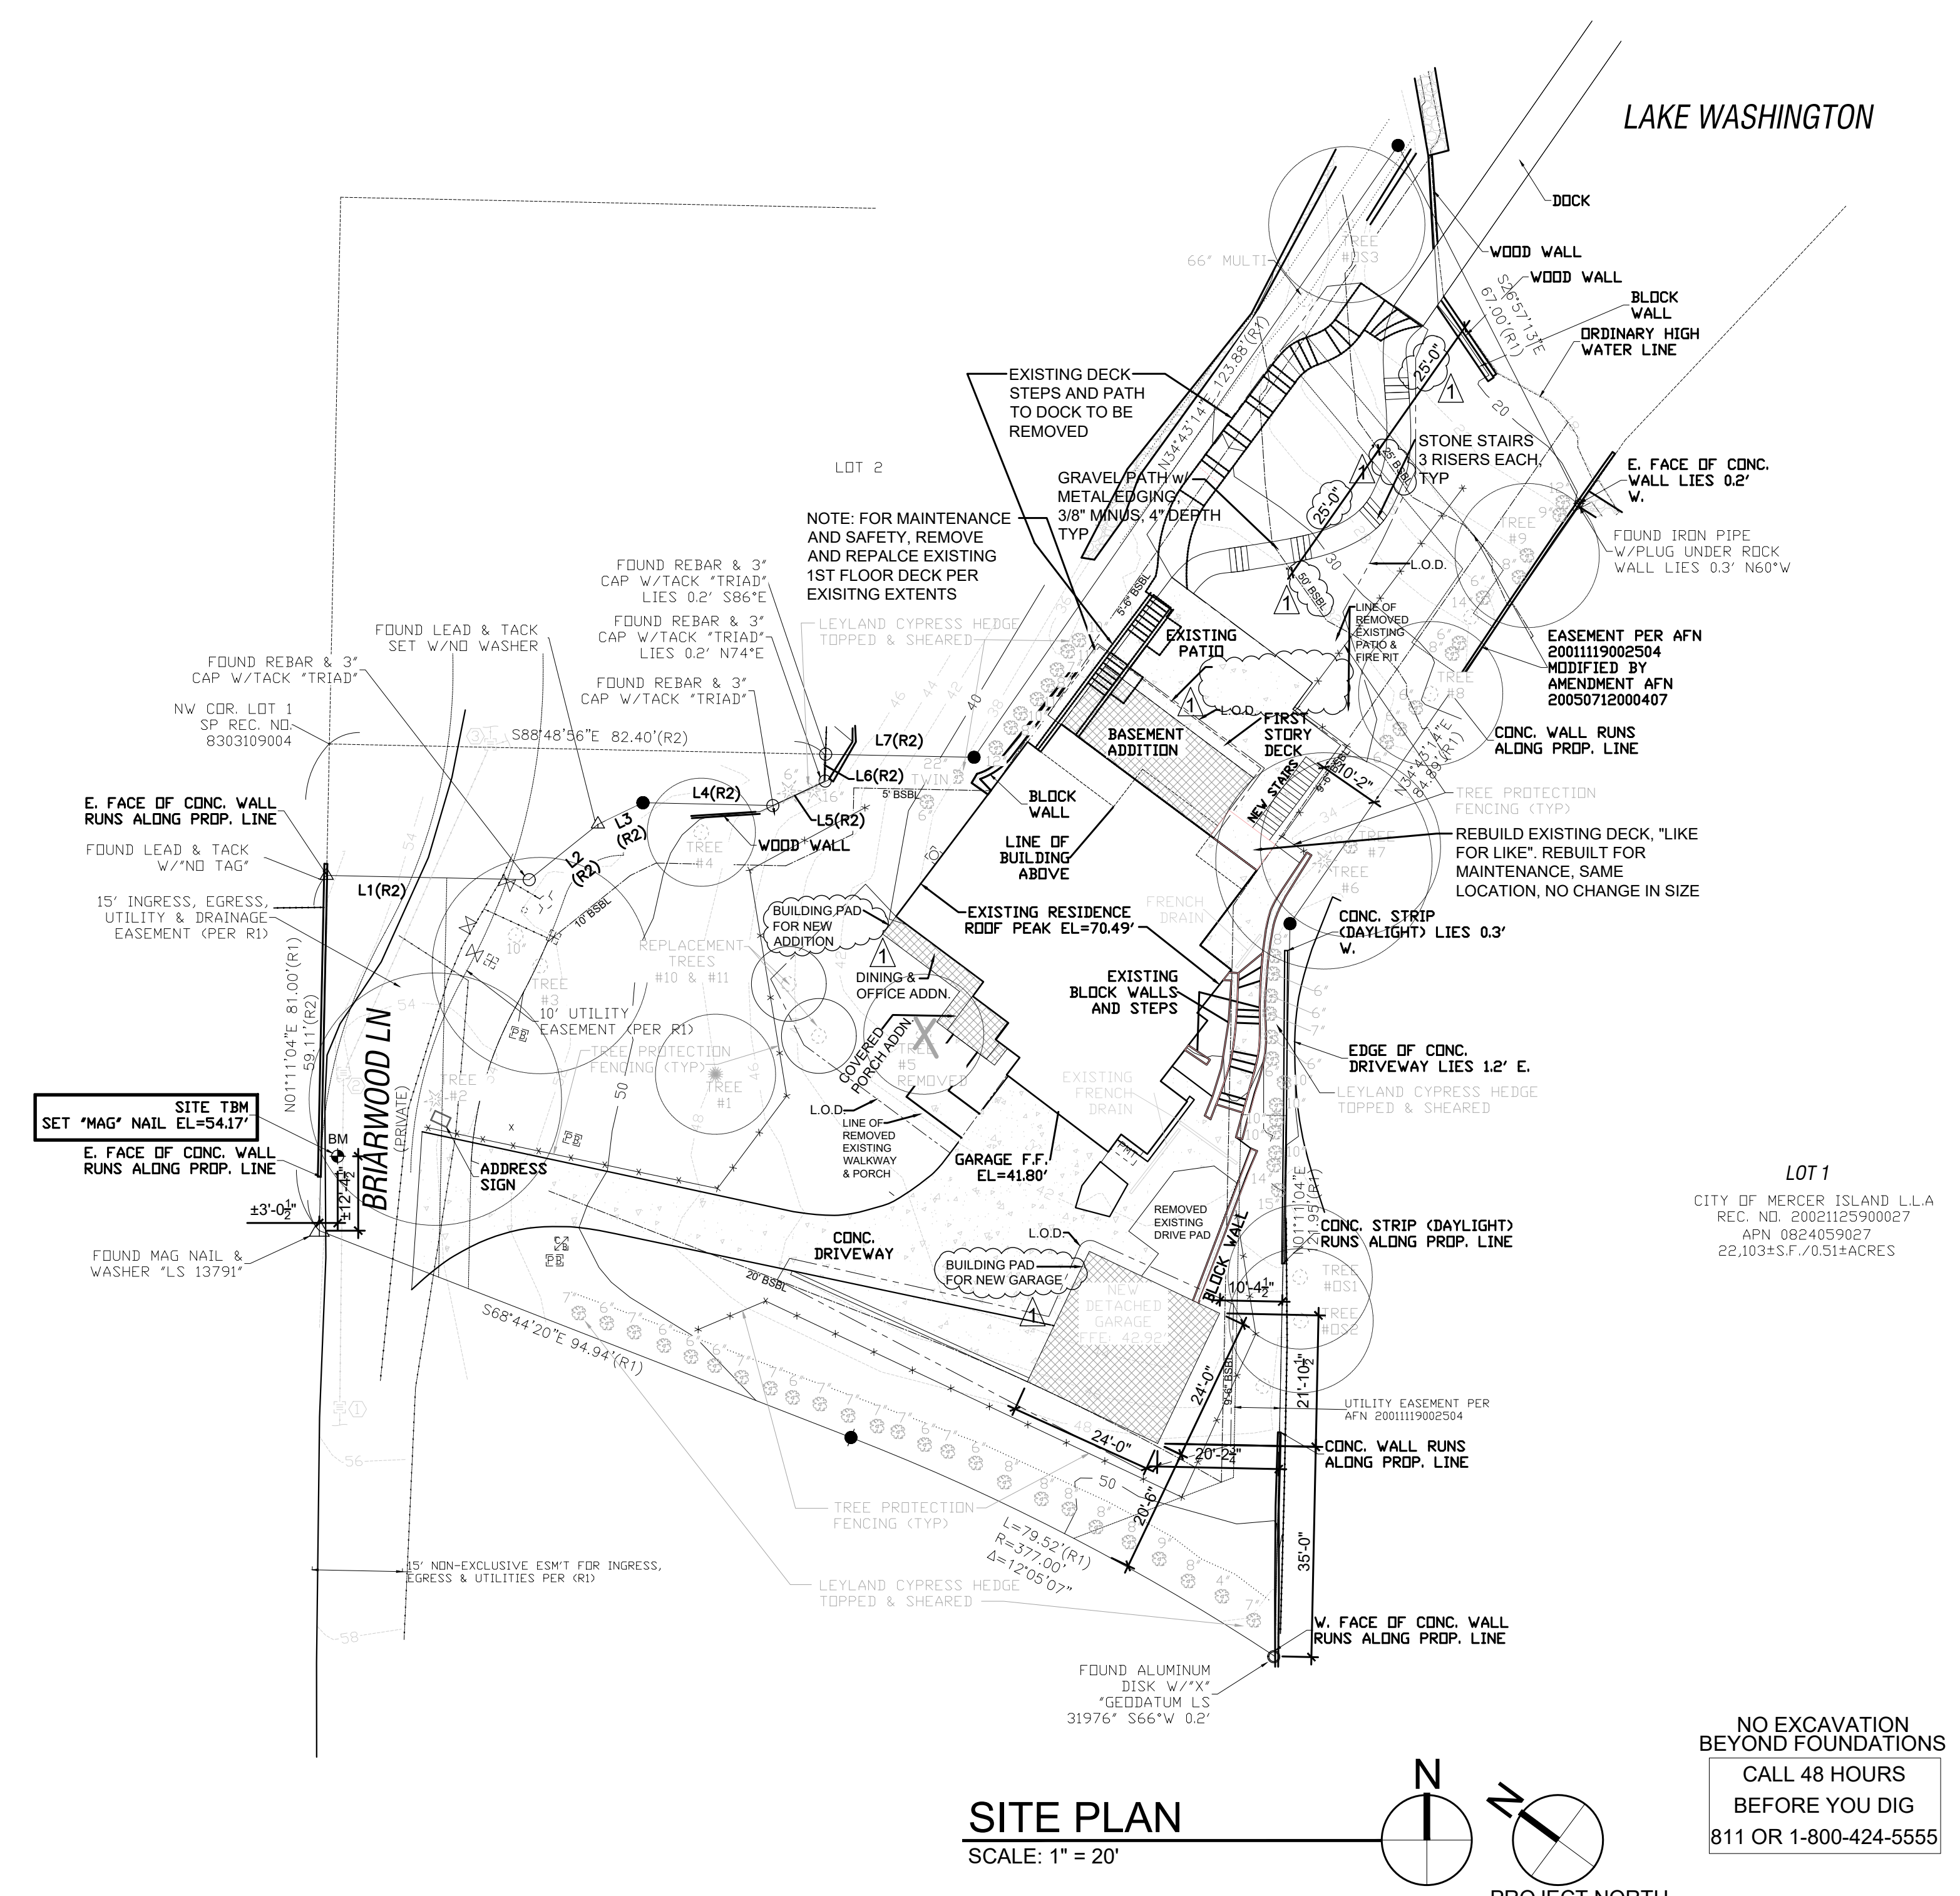

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### REGISTRATION:



### INTAKE: DATE:

- REVISIONS: DATE:
1. Robin Proebsting comments 12-04-20
  - 2.
  - 3.
  - 4.
  - 5.

### PROJECT / CLIENT:

**9820 SE 35TH PLACE**  
ACHIN & MARY CHEN  
9820 SE 35TH PLACE  
MERCER ISLAND, WA 98040

### JOB ADDRESS:

9820 SE 35TH PLACE  
MERCER ISLAND, WA 98040  
**PARCEL # 082405-9027**

### DRAWING NAME:

### SITE PLAN

Drawn By: JMG, RB  
Checked By: EB  
Owner Approval:

### PHASE:

### CONSTRUCTION DOCUMENTS


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### APPROVED FOR CONSTRUCTION:

PROJECT No.: 2020 007  
DATE: 12-22-2020

PLOT SCALE: 1:1

A0.1

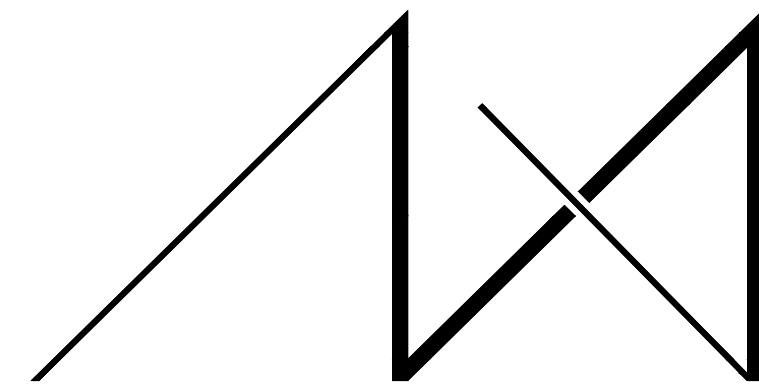

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**PARCEL # 082405-9027**

DRAWING NAME:

**SITE PLAN CALCULATIONS**

Drawn By: JMG, RB  
Checked By: EB  
Owner Approval:


PHASE:

**CONSTRUCTION DOCUMENTS**



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APPROVED FOR CONSTRUCTION:

A.B.E. CALC MAIN HOUSE				
MIDPOINT ELEVATION	*	WALL LENGTH	=	
A	33.71	a	31.67	1,067.60
B	33.74	b	12.00	404.88
C	33.74	c	9.67	326.27
D	33.71	d	16.00	539.36
E	34.33	e	6.50	223.15
F	37.52	f	12.13	455.12
G	39.52	g	2.00	79.04
H	40.14	h	9.71	389.76
I	40.49	i	5.33	215.81
J	40.89	j	10.67	436.30
K	41.29	k	5.33	220.08
L	41.39	l	3.50	144.87
M	40.83	m	20.92	854.16
N	40.54	n	3.50	141.89
O	40.39	o	2.64	106.63
P	40.51	p	3.50	141.79
Q	40.62	q	12.00	487.44
R	40.54	r	6.33	256.62
S	40.19	s	15.95	641.03
T	36.59	t	30.42	1,113.07
U	35.93	u	1.67	60.00
V	35.21	v	27.25	959.47
<b>TOTAL:</b>			248.69	9,264.31
<b>AVERAGE BUILDING ELEVATION:</b>				37.25
<b>MAX HEIGHT ALLOWED</b>				+ 30.00
<b>MAX ELEVATION</b>				= 67.25
<b>PROPOSED TOP OF ROOF</b>				= 66.03
<b>AMOUNT BELOW MAX:</b>				= 1.22


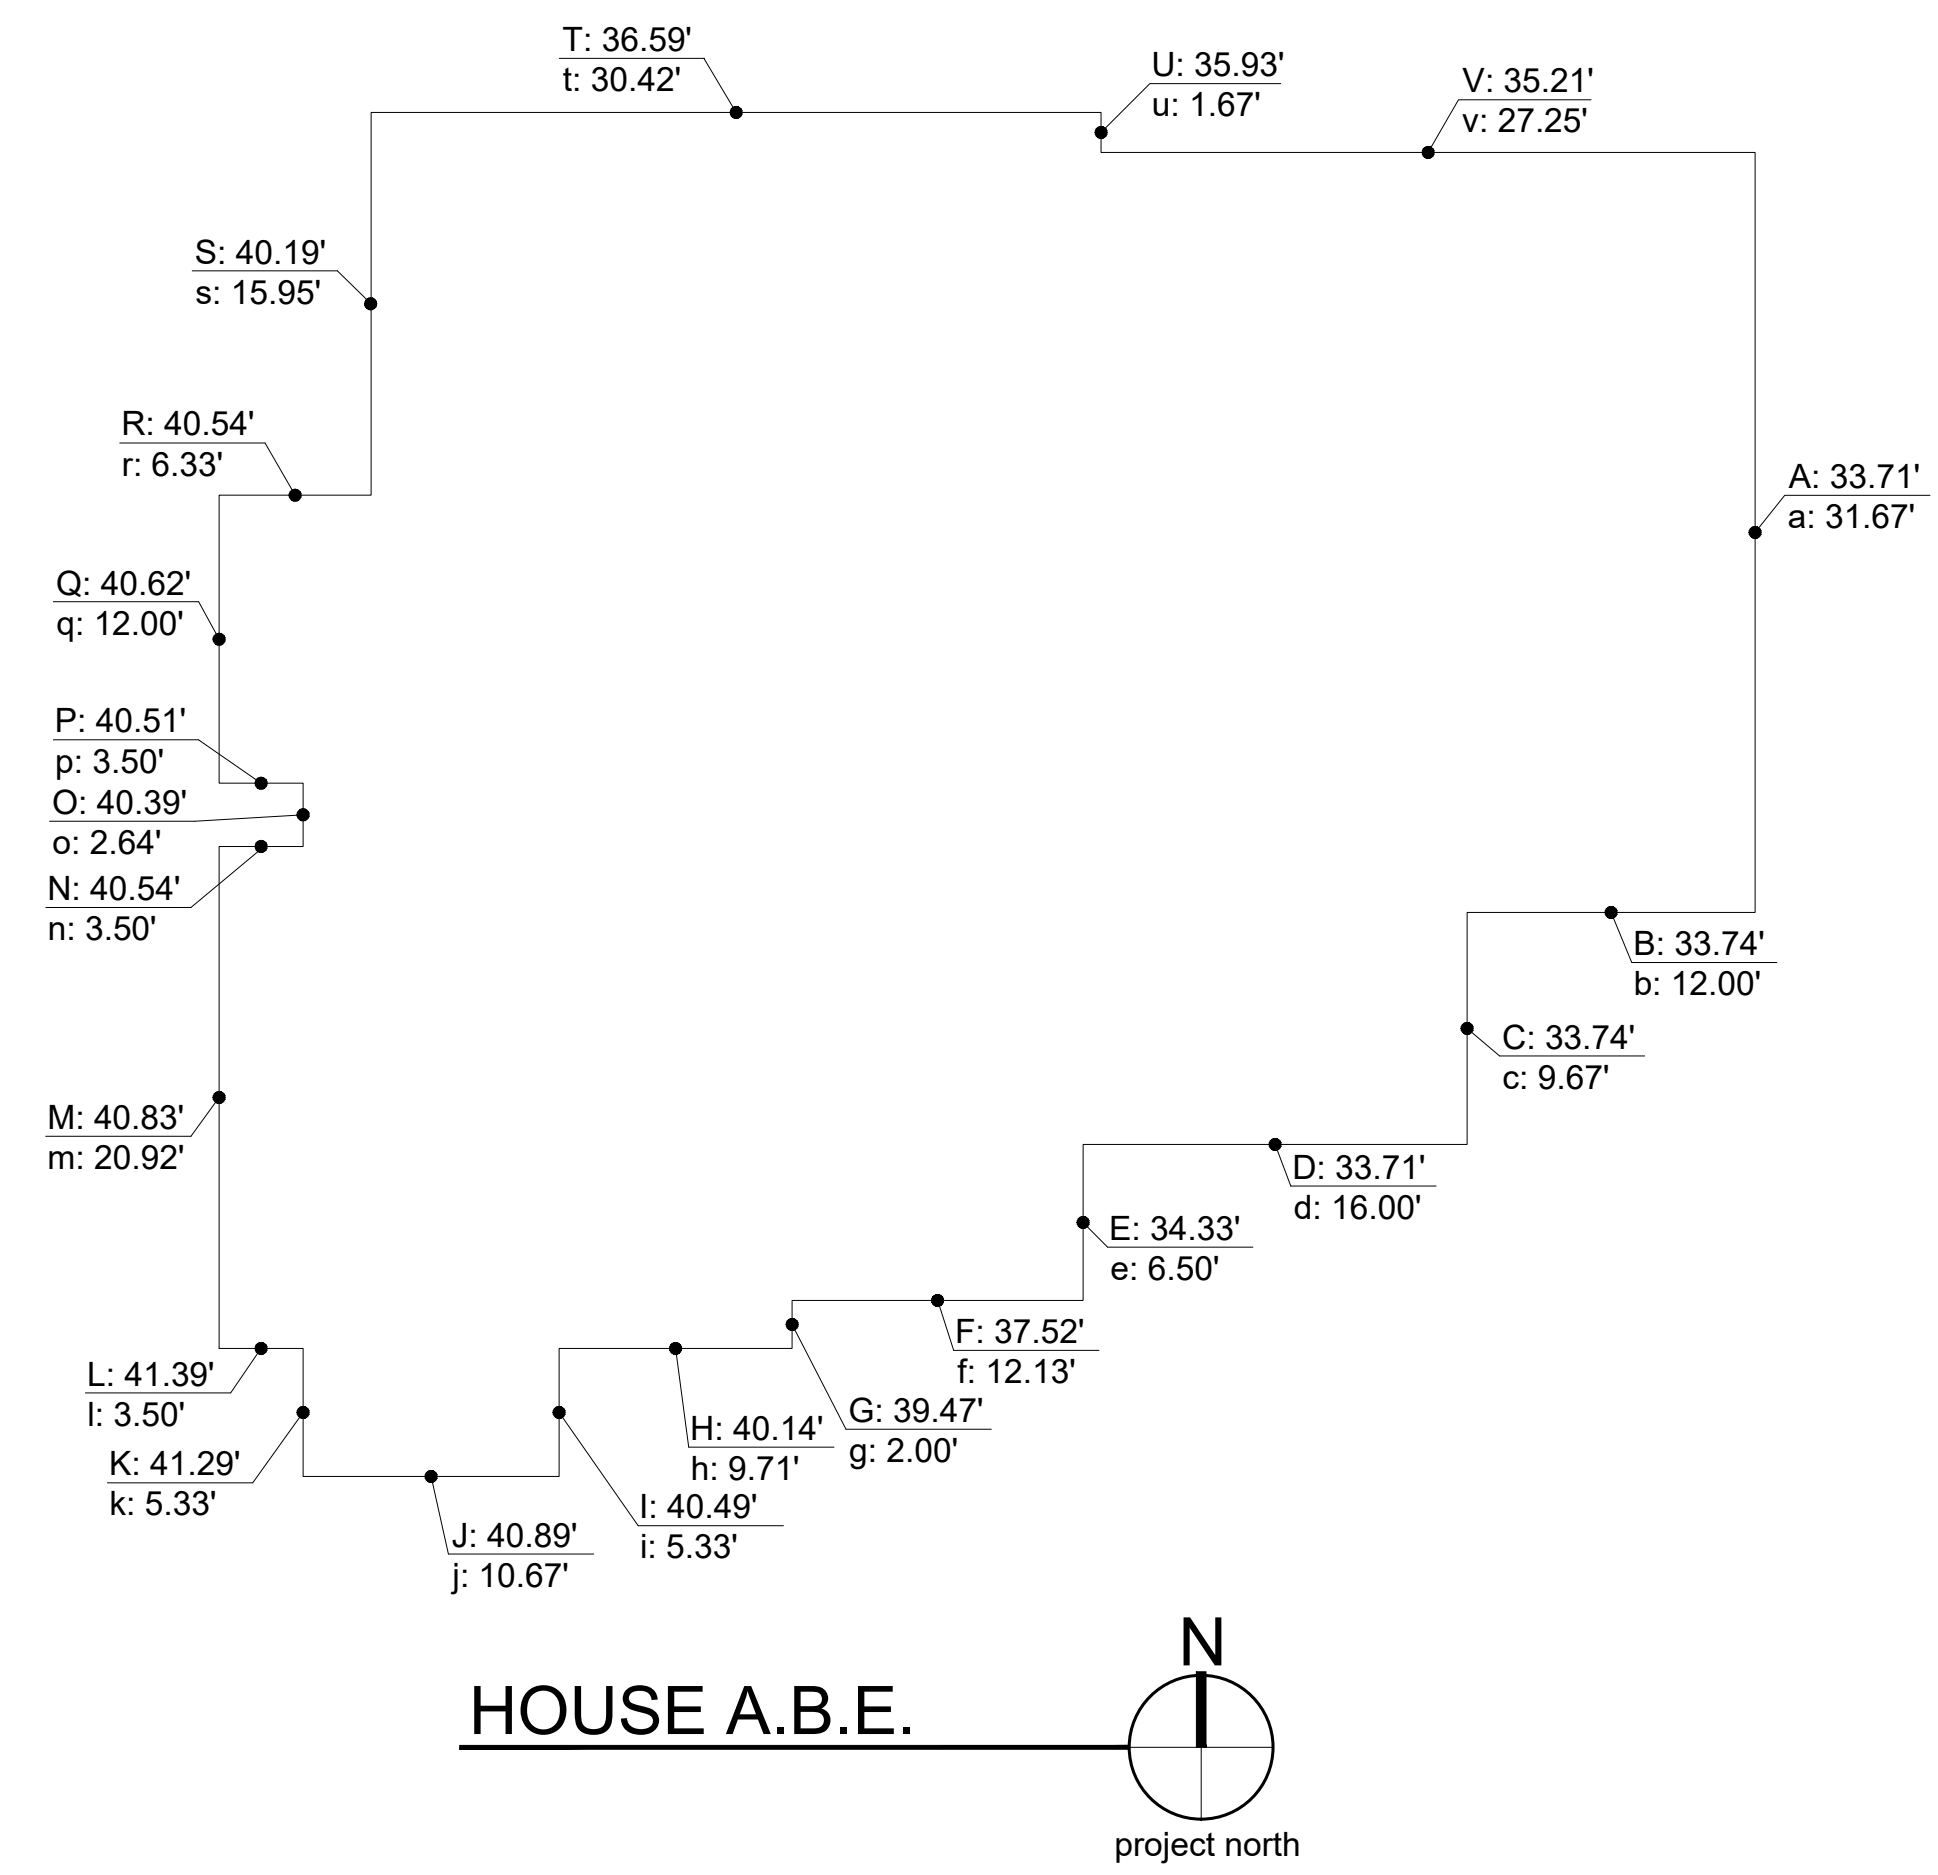


BASEMENT FLOOR AREA EXCLUSION			
WALL	LENGTH	COVERAGE	RESULT
A	31.67	9%	2.85
B	6.50	9%	0.59
C	12.13	9%	1.09
D	23.00	9%	2.07
E	1.71	16%	0.27
F	26.88	55%	14.78
G	14.81	97%	14.37
H	1.67	98%	1.64
I	27.63	86%	23.76
J	31.67	39%	12.35
K	12.00	35%	4.20
L	9.67	34%	3.29
<b>TOTAL:</b>	199.34		81.26
<b>SQ. FT.</b>		<b>PERCENTAGE</b>	<b>EXCLUDED</b>
1,670		40.76%	681

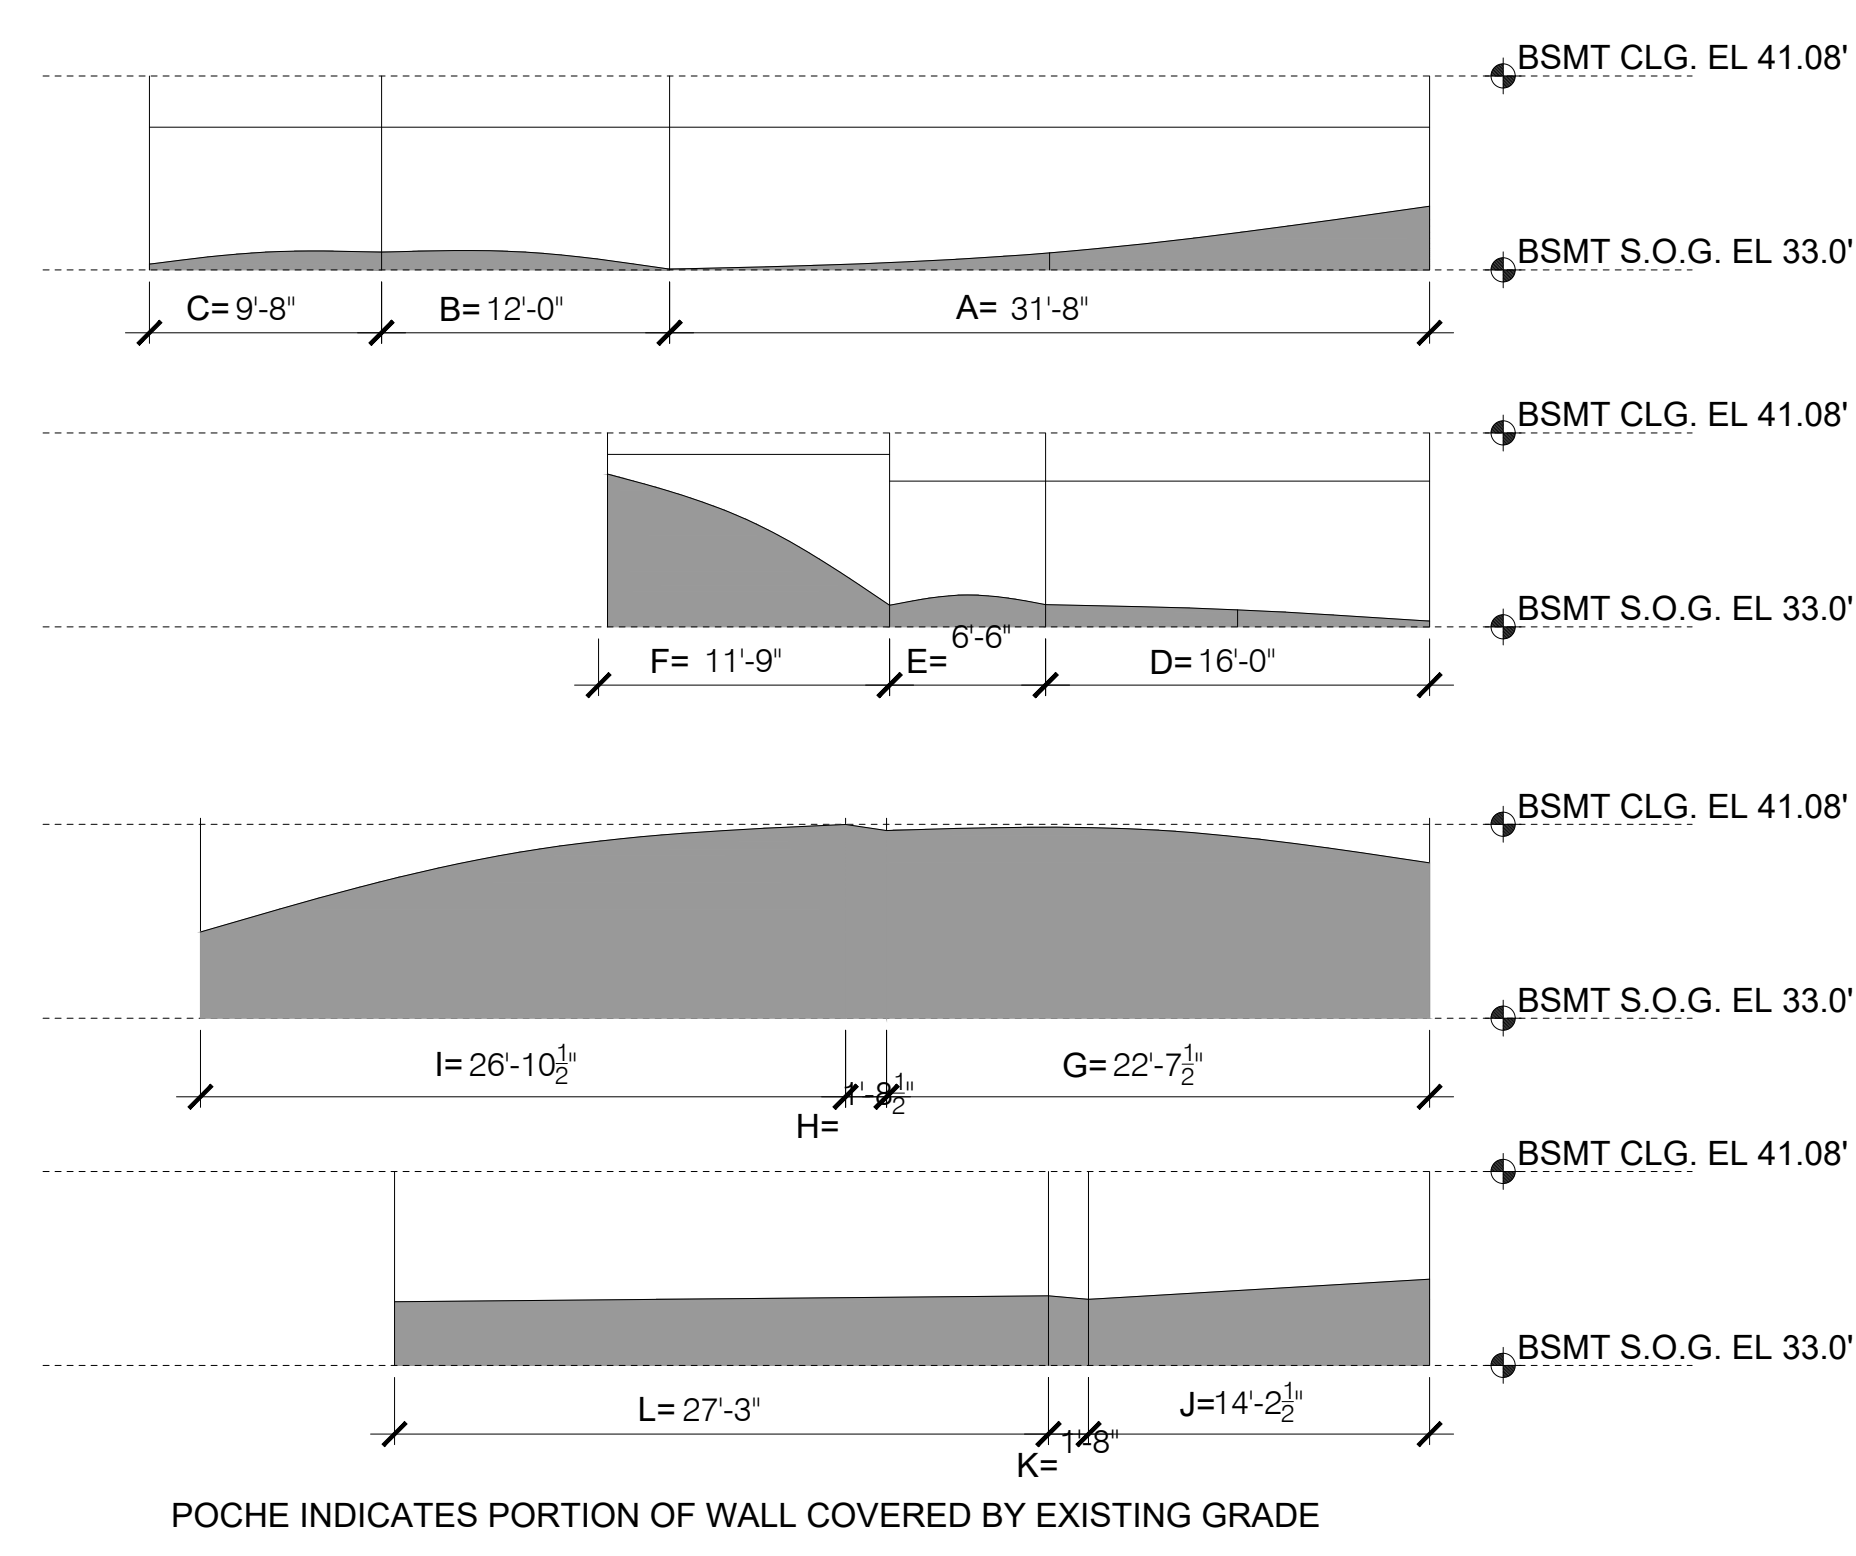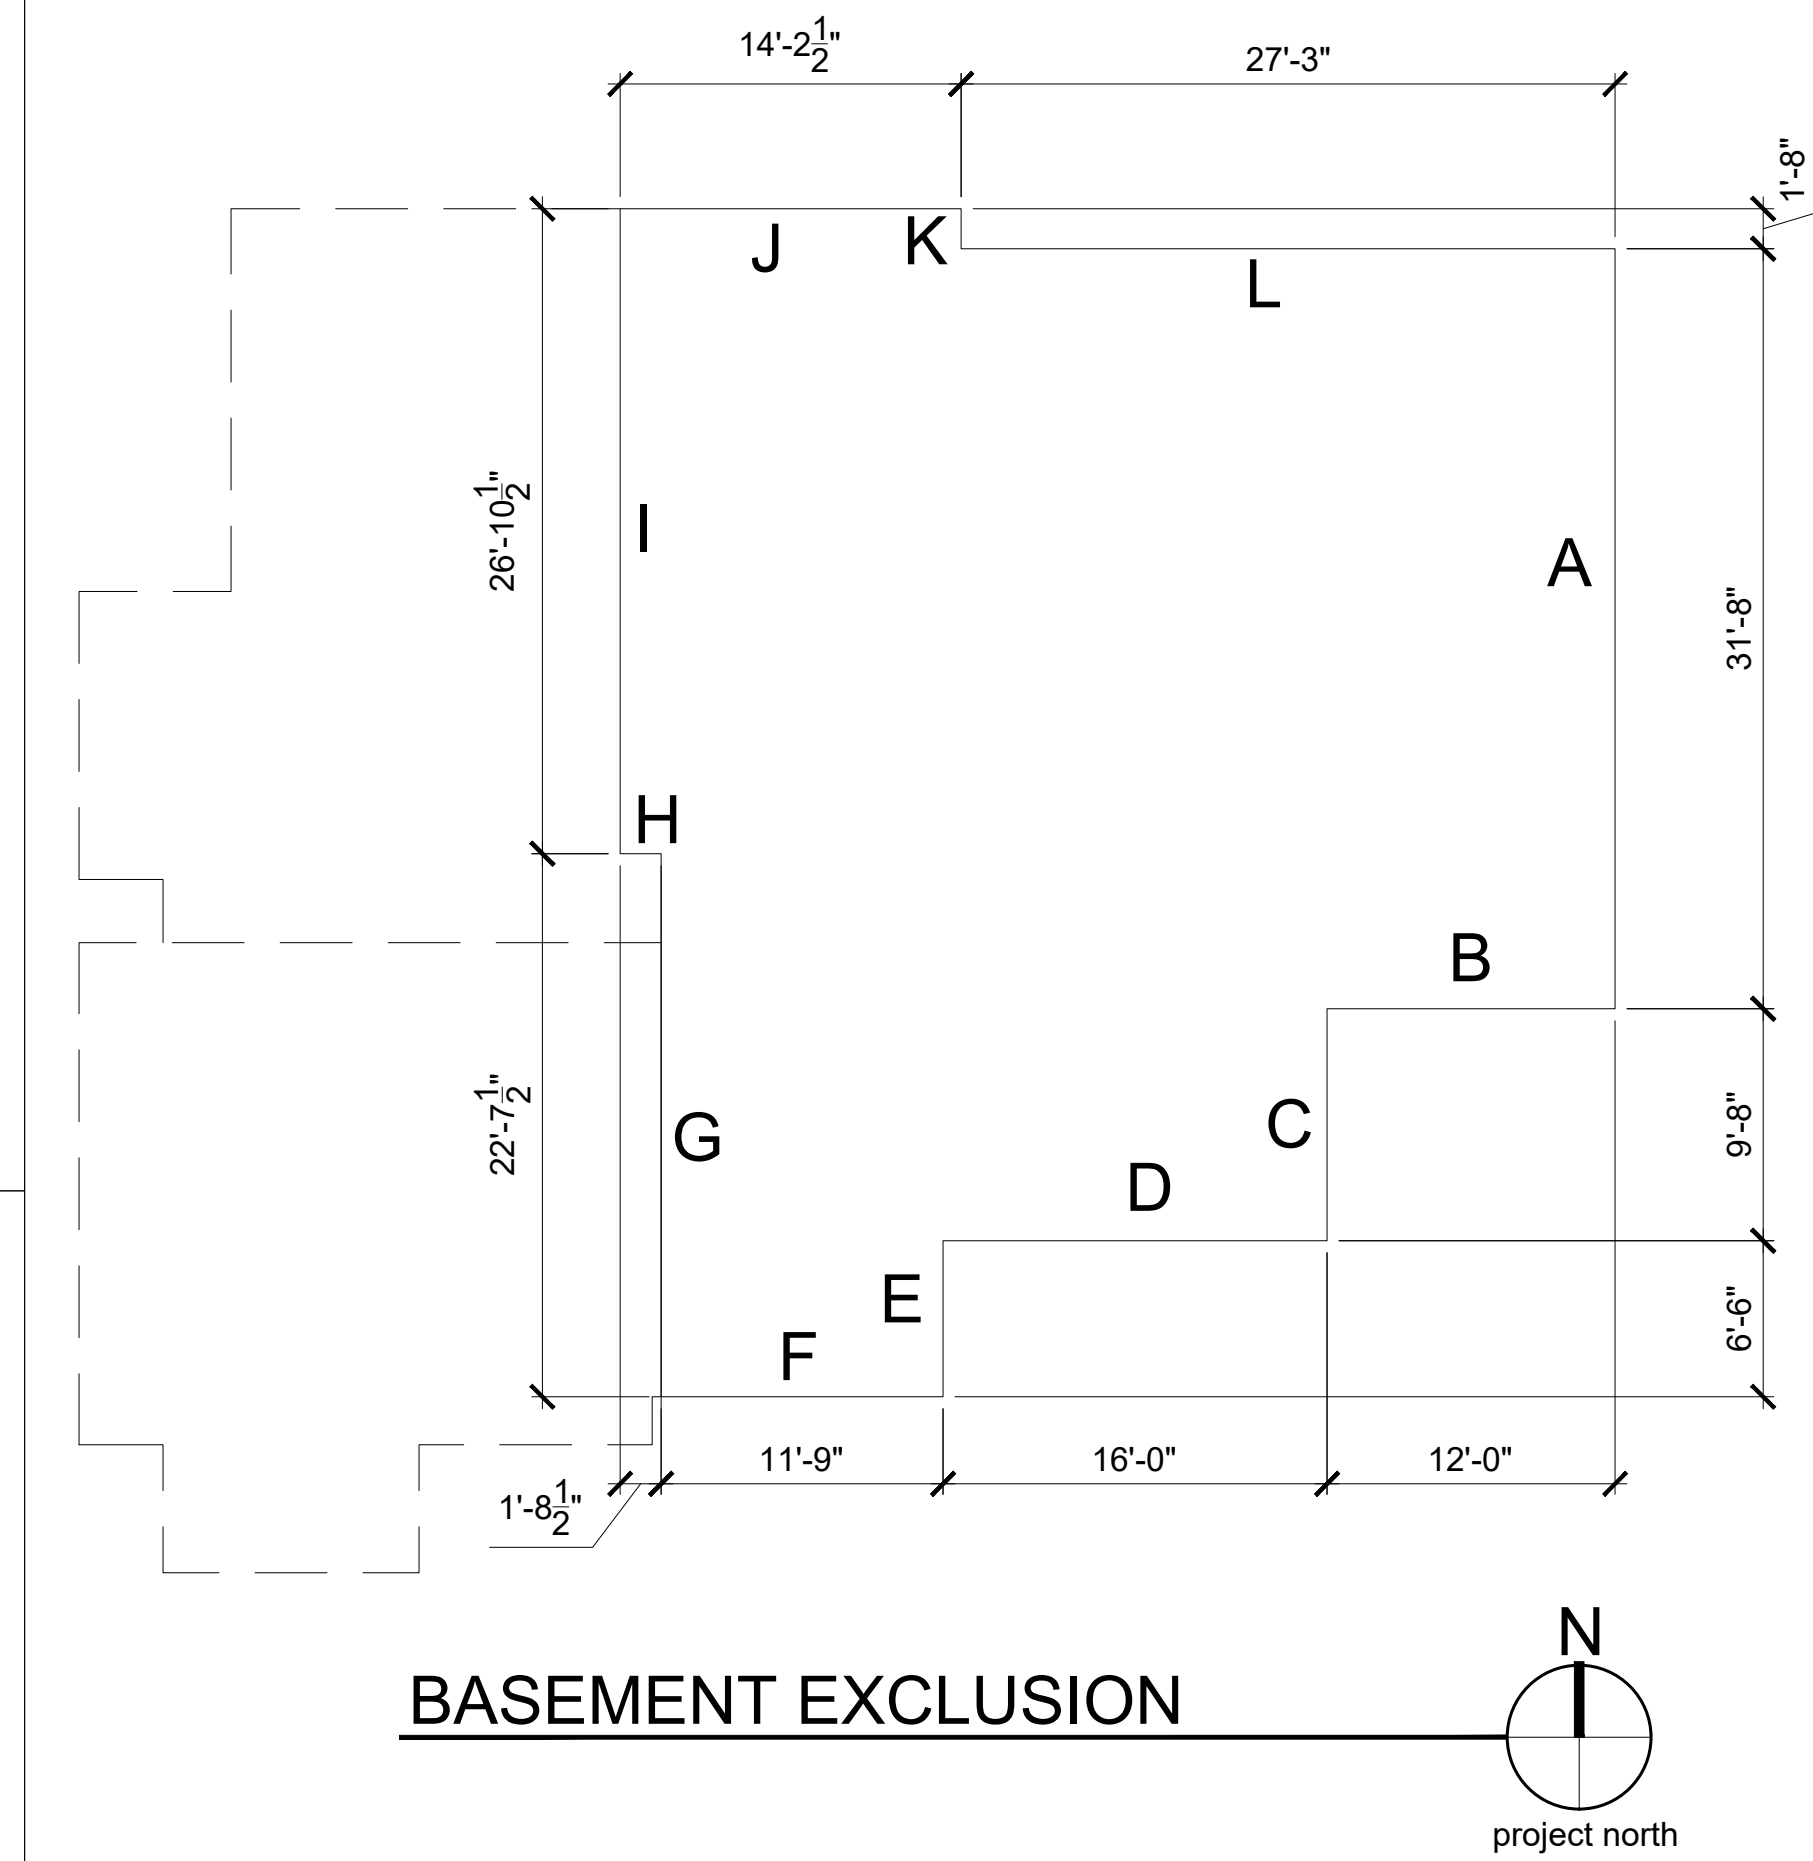

POCHE INDICATES PORTION OF WALL COVERED BY EXISTING GRADE


A.B.E. CALC DETACHED GARAGE				
MIDPOINT ELEVATION	*	WALL LENGTH	=	
A	43.74	a	24.00	1,049.76
B	42.89	b	24.00	1,029.36
C	45.21	c	24.00	1,085.04
D	47.20	d	24.00	1,132.80
<b>TOTAL</b>		96.00		4,296.96
<b>AVERAGE BUILDING ELEVATION:</b>				44.76
<b>MAX HEIGHT ALLOWED</b>				+ 17
<b>MAX ELEVATION</b>				= 61.76
<b>PROPOSED TOP OF ROOF</b>				= 61.26
<b>AMOUNT BELOW MAX</b>				= 0.50

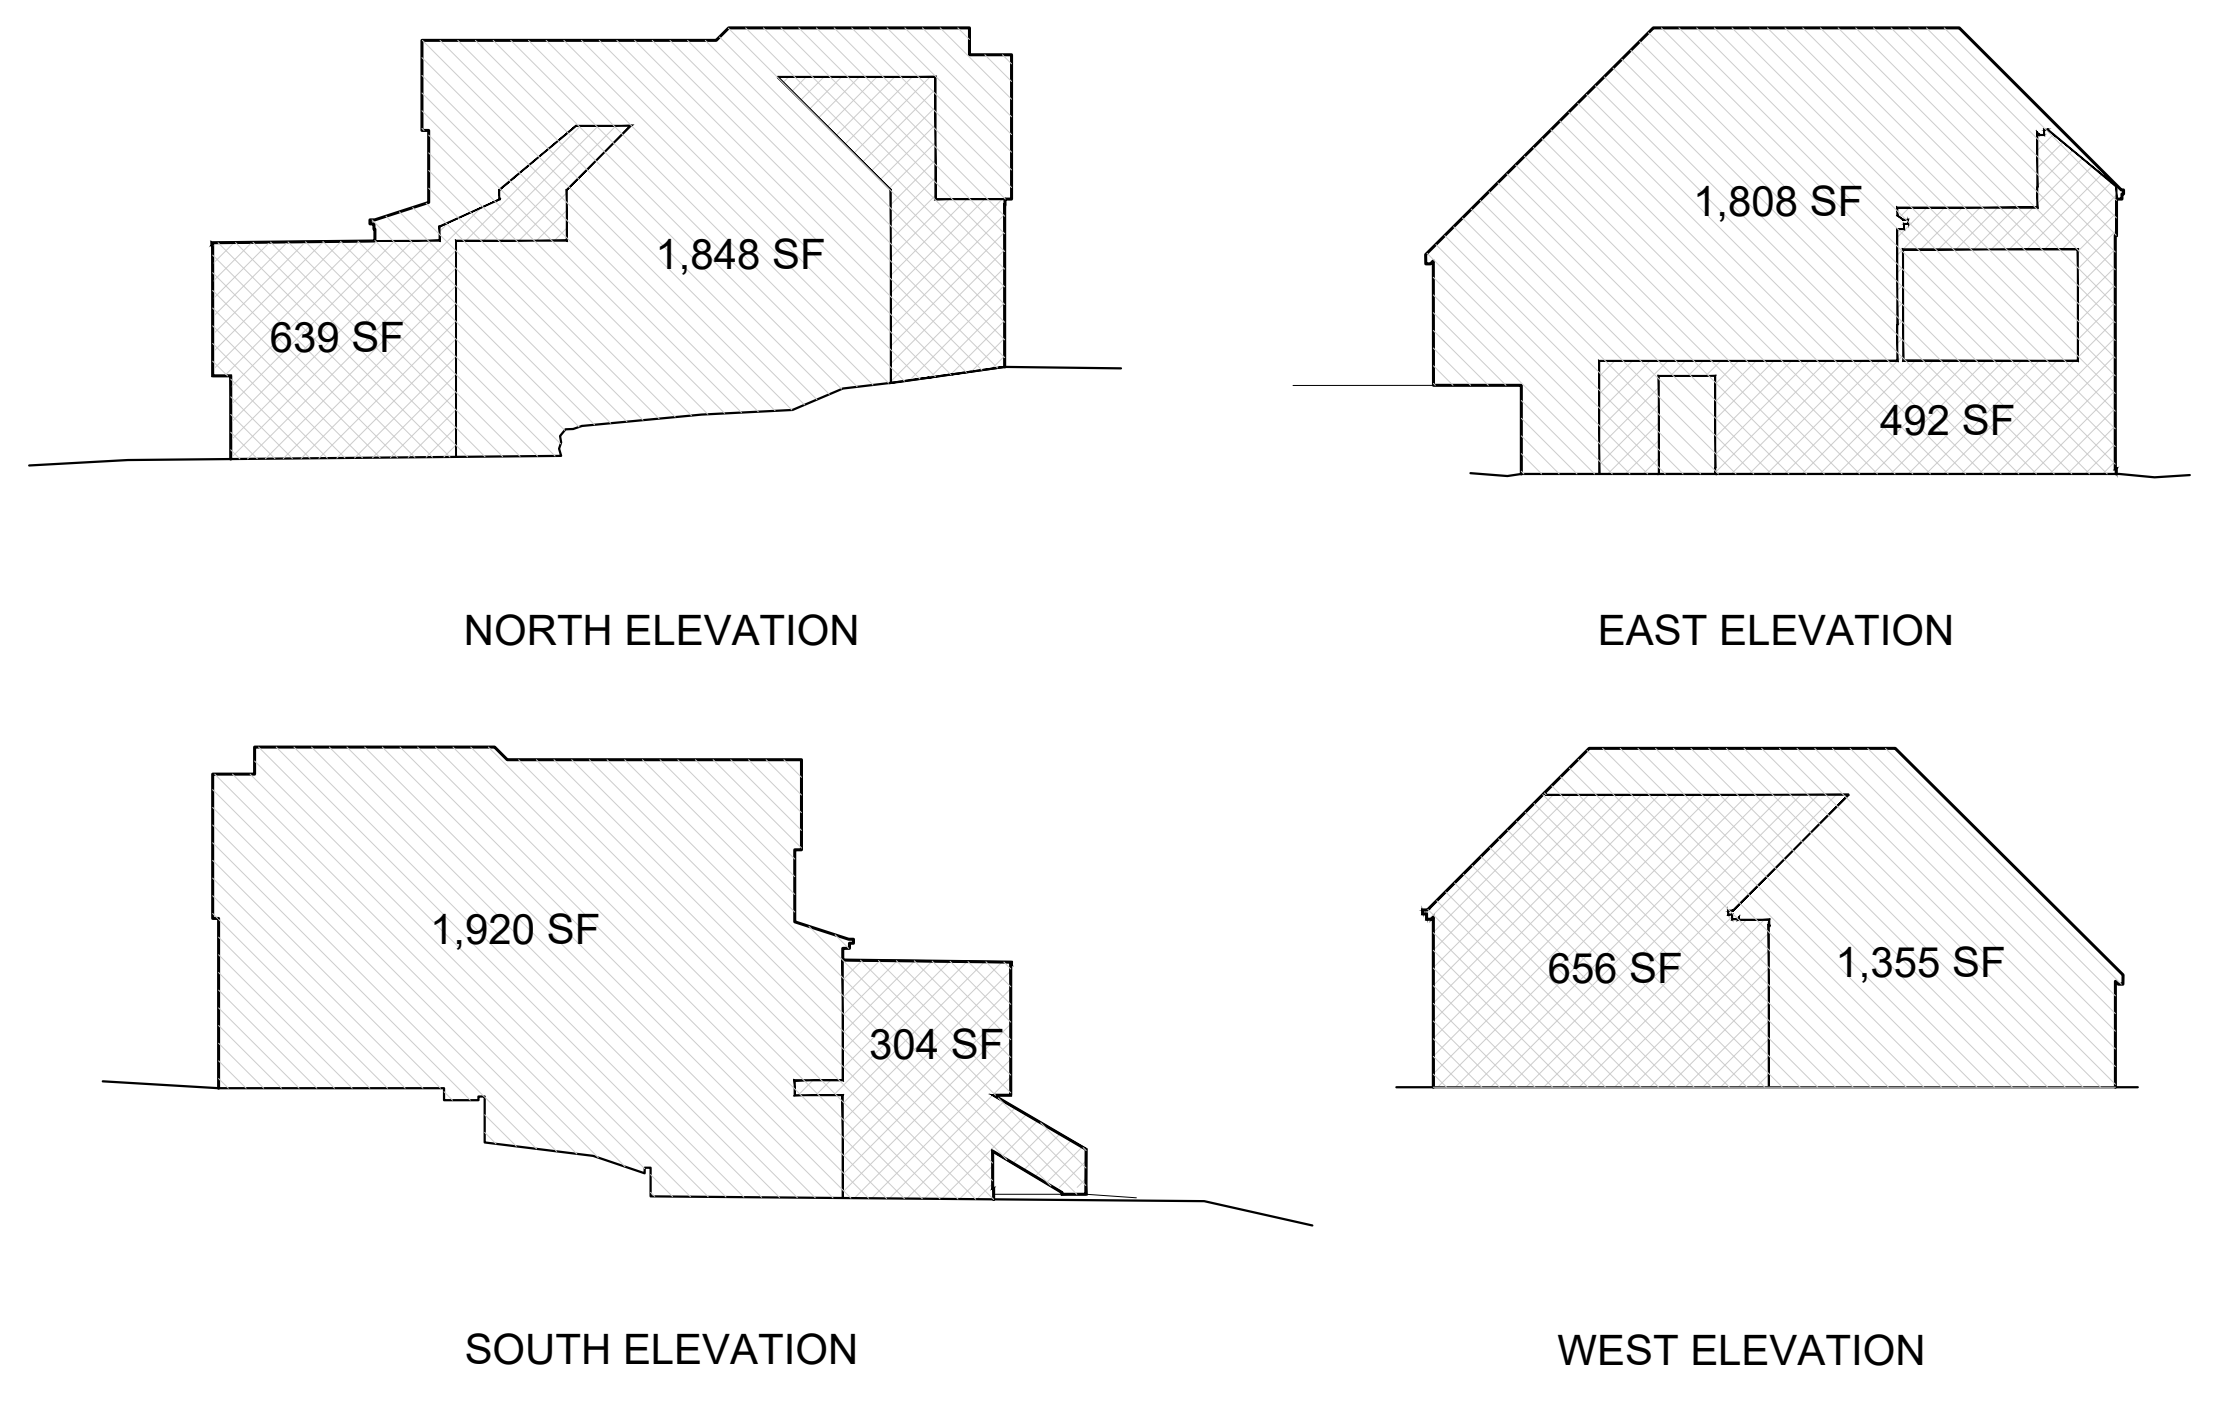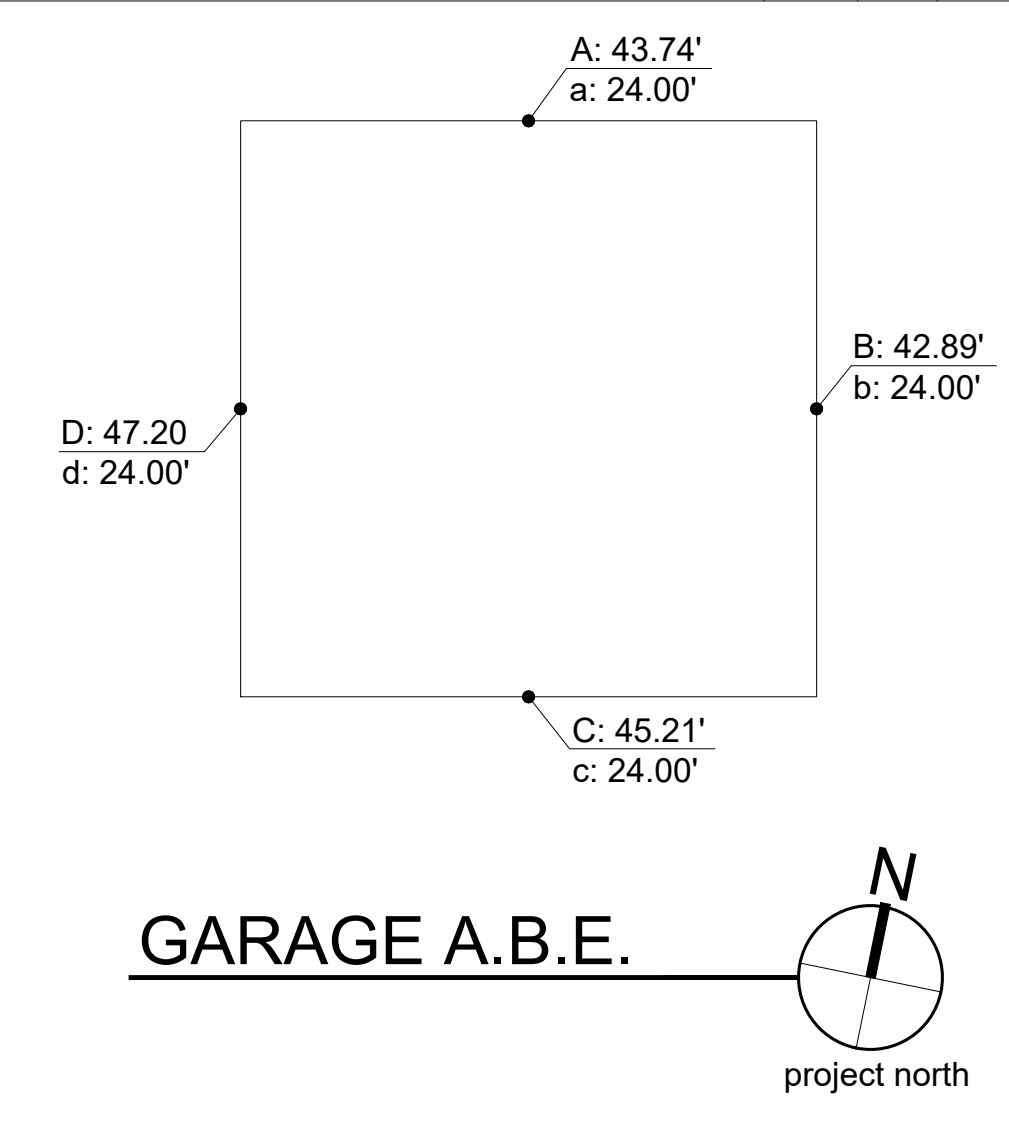

**40% EXTERIOR STRUCTURAL THRESHOLD:**  
ALL EXTERIOR SURFACE AREA 6,931 SF X 40%=2,772.4 SF  
NORTH ELEVATION 639.0 SF  
EAST ELEVATION 492.0 SF  
SOUTH ELEVATION 304.0 SF  
WEST ELEVATION 656.0 SF  
ALTERED EXTERIOR AREA 2,091.0 SF < 2,772.4 SF

**STRUCTURAL DISTURBANCE**



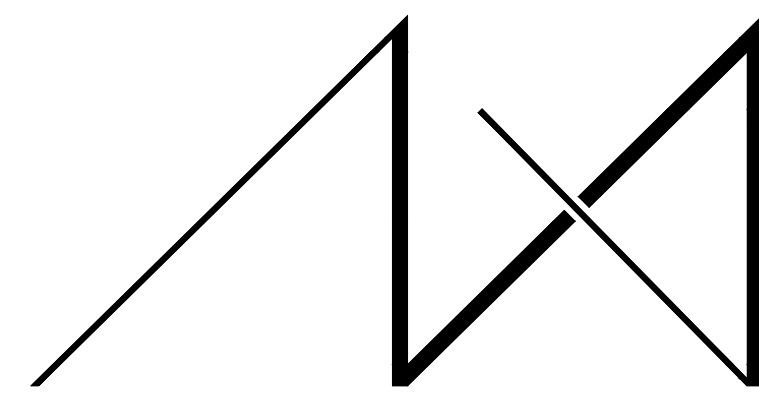


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PROJECT / CLIENT:

**9820 SE 35TH PLACE**  
ACHIN & MARY CHEN  
9820 SE 35TH PLACE  
MERCER ISLAND, WA 98040

JOB ADDRESS:

9820 SE 35TH PLACE  
MERCER ISLAND, WA 98040  
**PARCEL # 082405-9027**

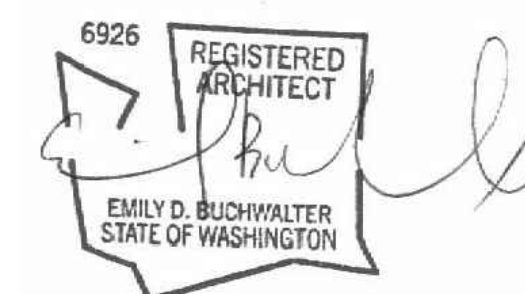DRAWING NAME:

SCHEDULES

Drawn By: JMG, RB

Checked By: EB

Owner Approval:

PHASE:

CONSTRUCTION DOCUMENTS

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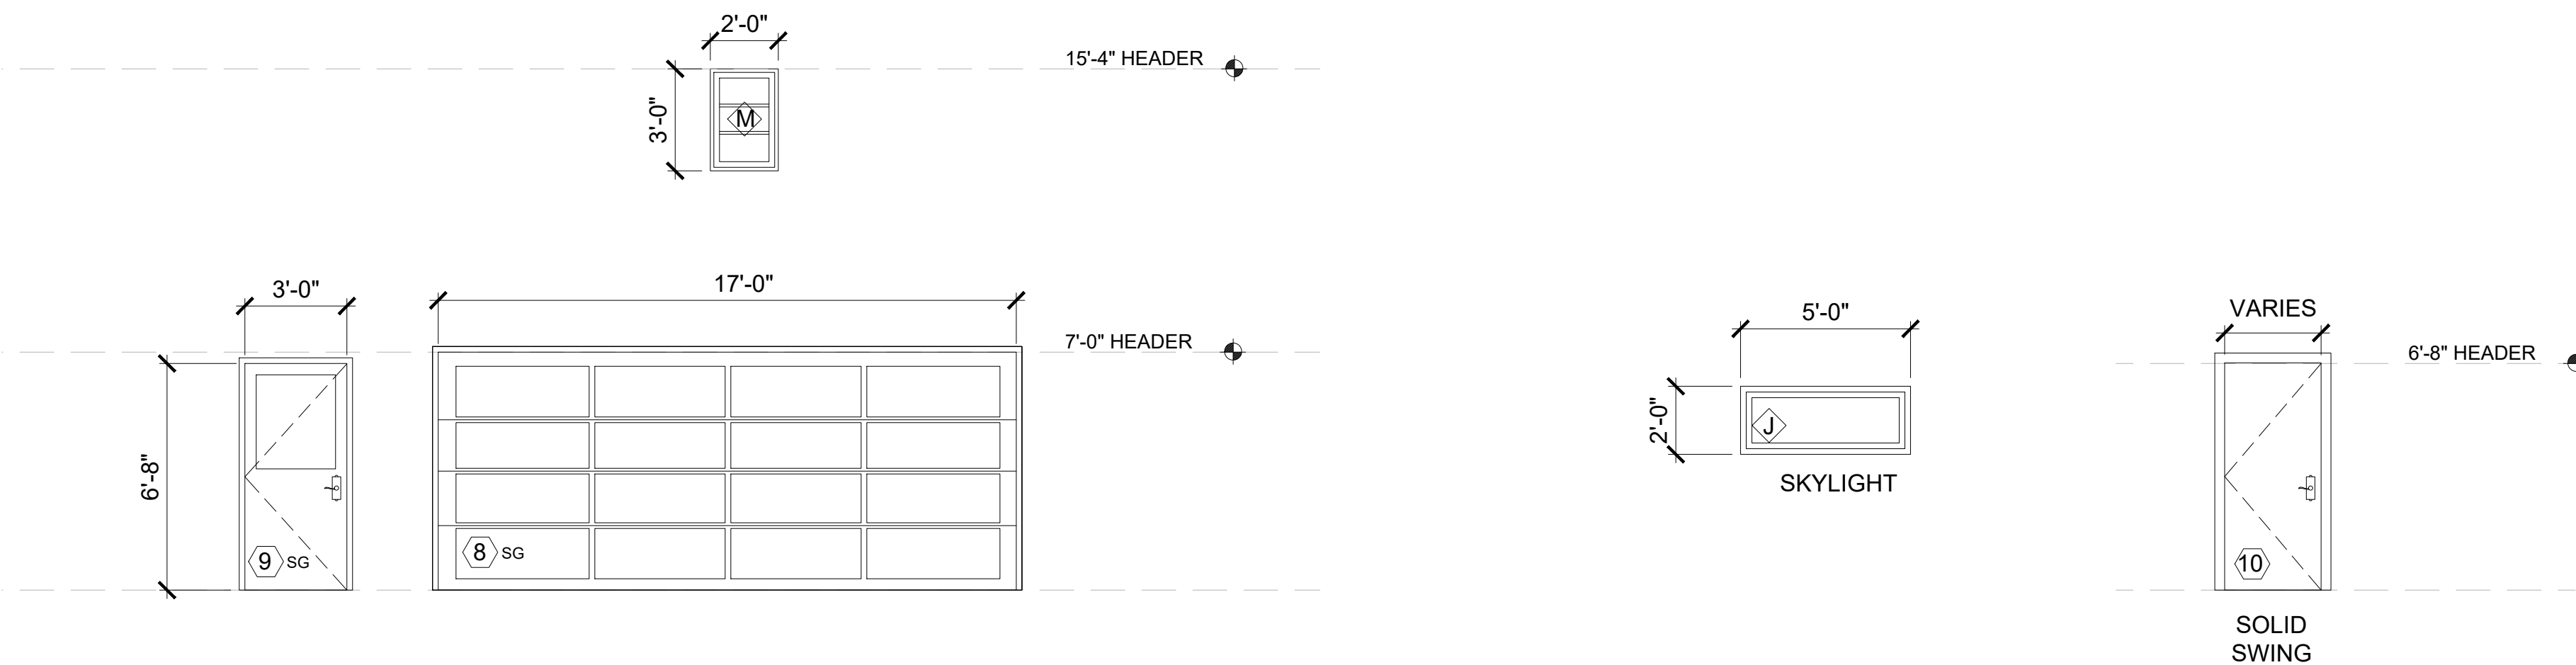
APPROVED FOR CONSTRUCTION:

PROJECT No.: 2020 007

DATE: 12-22-2020

PLOT SCALE: 1:1

A0.4



DETACHED GARAGE DOOR AND WINDOWS ELEVATIONS


SCALE: 1/4" = 1'-0"

SKYLIGHT ELEVATIONS

SCALE: 1/4" = 1'-0"


INTERIOR DOOR ELEVATIONS

SCALE: 1/4" = 1'-0"

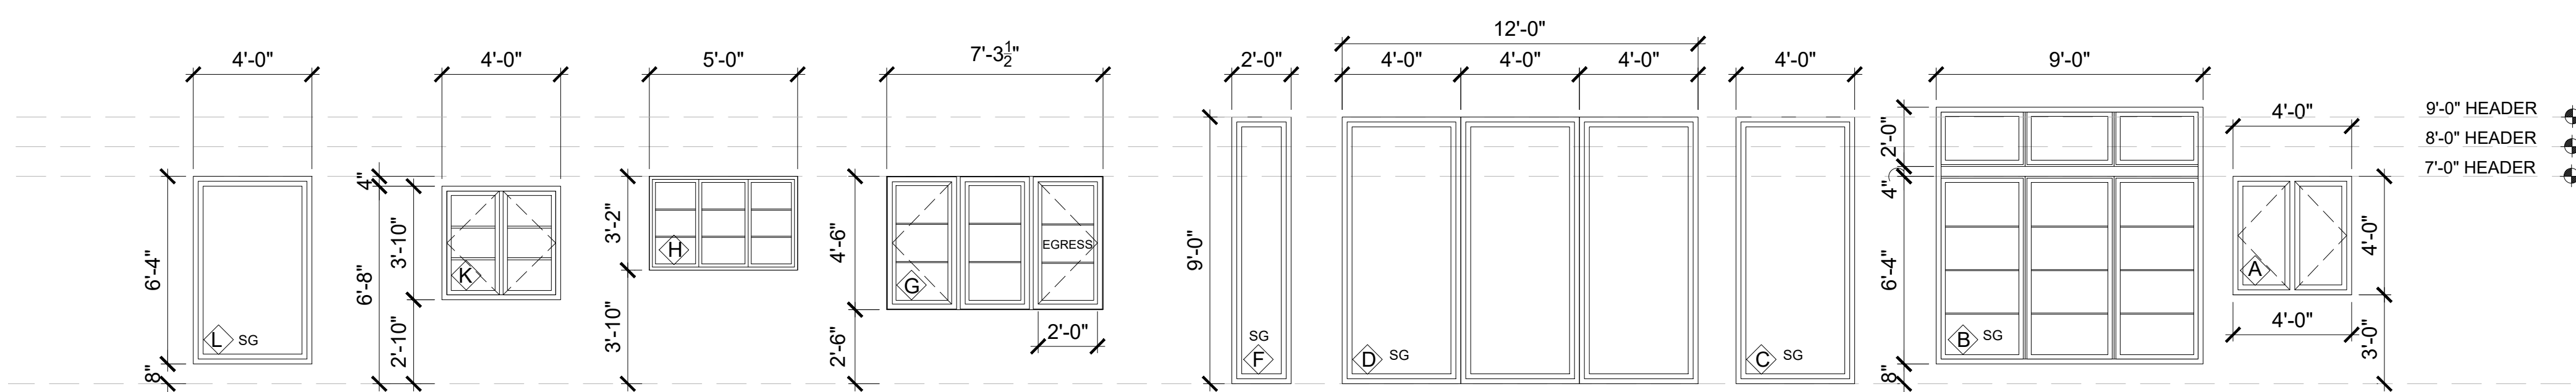

WINDOW ELEVATIONS

SCALE: 1/4" = 1'-0"

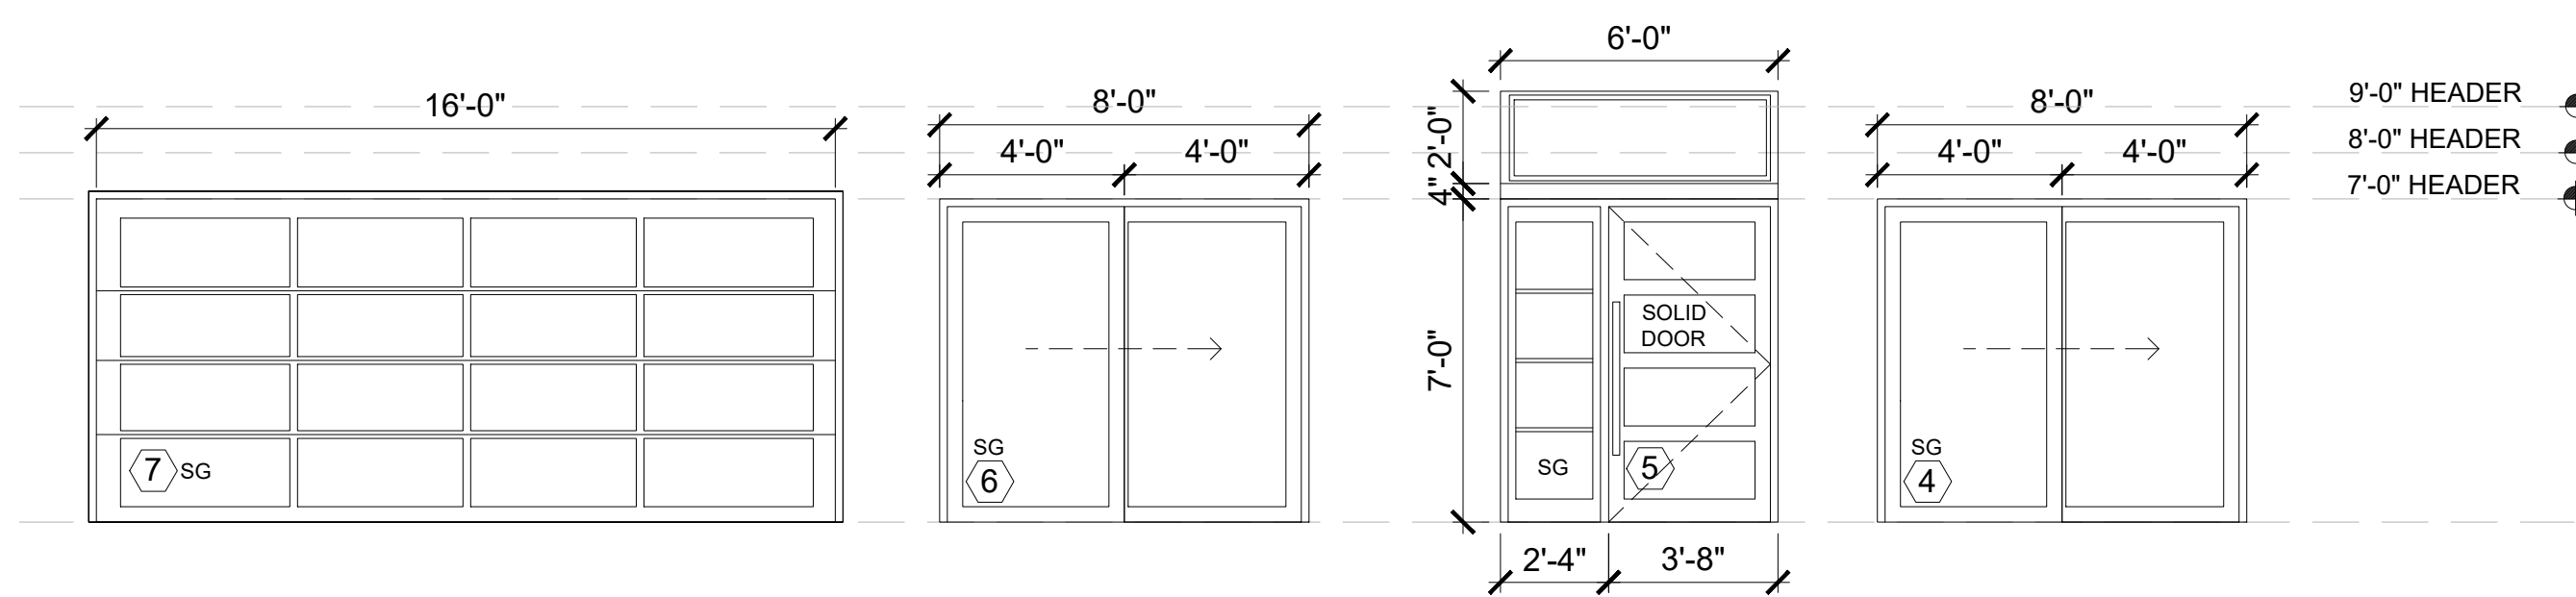

EXTERIOR DOOR ELEVATIONS

SCALE: 1/4" = 1'-0"

NOTE:  
DIMENSIONS INDICATE ROUGH OPENINGS.  
MANUFACTURER TO SIZE WINDOWS ACCORDINGLY.  
FIELD MEASURE PRIOR TO ORDERING. VERIFY SIZE REQUIREMENTS FOR EGRESS.

INTERIOR DOOR SCHEDULE										
NO	Qty	LOCATION	W	H	MANUF	TYPE	HARDWARE	REMARKS		
10	1	OFFICE	2'-6"	6'-8"	TBD	SOLID SWING			ALL HARDWARE TO BE BRUSHED NICKEL FINISH 2-PAIR OF BUTT HINGES FOR 6'-0" DOORS	
1		DOOR COUNT								

NOTES:

1. GENERAL CONTRACTOR SHALL PROVIDE MANUFACTURER'S DATA ON ALL WINDOWS SHOWING COMPLIANCE WITH THE 2015 WASHINGTON STATE ENERGY CODE.
2. ALL EXTERIOR TRUE DIVIDED FIXED TRANSOM GLAZING TO BE POSITIONED AT UPPER SASH LOCATION.
3. VERIFY ALL DOOR TYPES & HARDWARE W/OWNER PRIOR TO ORDERING.
4. DOOR SEPARATING UN-HEATED FROM HEATED SPACE TO BE U=28 MAX. PER WSEC 2015

WINDOW SCHEDULE											
NO	Qty	LOCATION	WIDTH	HEIGHT	AREA	MANUF.	U-VAL	TYPE	SCREEN	HARDWARE	REMARKS
A	1	NEW EXERCISE ROOM	4'-0"	4'-0"	16.00	TBD	0.28	CSMT/CSMT	Y	TBD	
B	1	FORMAL DINING ROOM	9'-0"	8'-4"	74.70	TBD	0.28	FIXED	N	TBD	TRANSOM,GRIDS
C	1	FAMILY ROOM	4'-0"	9'-0"	36.00	TBD	0.28	FIXED	N	TBD	SAFETY GLASS
D	1	FAMILY ROOM	12'-0"	9'-0"	18.00	TBD	0.28	FIXED	N	TBD	SAFETY GLASS, MULLED
E	1	EXISTING WINDOWS									
F	1	FAMILY ROOM	2'-0"	9'-0"	18.00	TBD	0.28	FIXED	N	TBD	SAFETY GLASS
G	1	BEDROOM 3	7'-3.5"	4'-6"	32.85	TBD	0.28	CSMT/CSMT/CSMT	Y	TBD	EGRESS, GRIDS
H	1	ABOVE FOYER	5'-0"	3'-2"	15.50	TBD	0.28	FIXED	N	TBD	GRIDS, SAFETY GLASS
I	1	NOT USED	0	0	0.00						
J	1	FOYER	2'-0"	5'-0"	10.00	TBD	0.43	SKYLIGHT	N	TBD	SKYLIGHT
K	1	NEW OFFICE	4'-0"	3'-10"	8.34	TBD	0.28	CSMT/CSMT	Y	TBD	GRIDS
L	2	NEW EXERCISE RM INTERIOR	4'-0"	6'-4"	50.40	TBD		FIXED	N	TBD	STOPPED IN GLASS
M	1	DETACHED GARAGE WINDOW	2'-0"	3'-0"	6.00	TBD		FIXED	N	TBD	NON CONDITIONED
					229.39		0.28			64.23	
					10.00	SF	0.43			4.3	
14		WINDOW COUNT						U X A =	68.53		NOTE: SEE A0.3 & A0.1.1.2 FOR WINDOW DIVISIONS


NOTES:

1. GENERAL CONTRACTOR SHALL PROVIDE MANUFACTURER'S DATA ON ALL WINDOWS SHOWING COMPLIANCE WITH THE 2015 WASHINGTON STATE ENERGY CODE. CONTRACTOR TO FIELD VERIFY ALL WINDOW AND DOOR SIZES AND EGRESS REQUIREMENTS PRIOR TO ORDERING. VERIFY SWING DIRECTION WITH OWNER
2. ALL EXTERIOR TRUE DIVIDED FIXED TRANSOM GLAZING TO BE POSITIONED AT UPPER SASH
3. ALL WINDOWS TO BE NFRC CERTIFIED AND LABELED

EXTERIOR DOOR SCHEDULE											
NO	Qty	LOCATION	W	H	MANUF.	AREA	U-VAL	TYPE	CONFIGURATION	HARDWARE	REMARKS
1	1	NEW EXERCISE ROOM	12'-0"	7'-0"	TBD	84.0	0.28	SLIDING	XXO		SAFETY GLASS
2	1	NEW SITTING ROOM	12'-0"	7'-0"	TBD	84.0	0.28	SLIDING	XXO		SAFETY GLASS
3	0	NOT USED	0	0	TBD	0.0	0.28				
4	1	KITCHEN	8'-0"	7'-0"	TBD	56.0	0.28	SLIDING	XO		SAFETY GLASS
5	1	FOYER	6'-0"	9'-0"	TBD	54.0	0.28	SOLID SWING WITH SIDE LITE & TRANSOM			ALL HARDWARE TO BE BRUSHED NICKEL FINISH 2-PAIR OF BUTT HINGES FOR 6'-8" 8'-0" DOORS SAFETY GLASS
6	1	MASTER BEDROOM	8'-0"	7'-0"	TBD	56.0	0.28	SLIDING	XO		SAFETY GLASS
7	1	GARAGE	16'-0"	7'-0"	TBD			OVER HEAD GARAGE DOOR	X		GARAGE DOOR OPENER. SEE ELEVATION FOR DOOR PATTERN
8	1	DETACHED GARAGE	17'-0"	7'-0"	TBD			OVER HEAD GARAGE DOOR	X		GARAGE DOOR OPENER. SEE ELEVATION FOR DOOR PATTERN
9	1	DETACHED GARAGE ENTRY	3'-0"	8'-0"	TBD		0.28	SOLID SWING	X		ALL HARDWARE TO BE BRUSHED NICKEL FINISH 2-PAIR OF BUTT HINGES FOR 6'-8" 8'-0" DOORS 1/2 LIGHT, SAFTY GLASS
TOTAL					SF	334.0	0.28	TOTAL U x A =	93.5		

NOTES:

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3. VERIFY ALL DOOR TYPES & HARDWARE W/OWNER PRIOR TO ORDERING.
4. DOOR SEPARATING UN-HEATED FROM HEATED SPACE TO BE U=28 MAX. PER WSEC 2015
5. ALL DOOR WITH GLAZING TO BE NFRC CERTIFIED AND LABELED

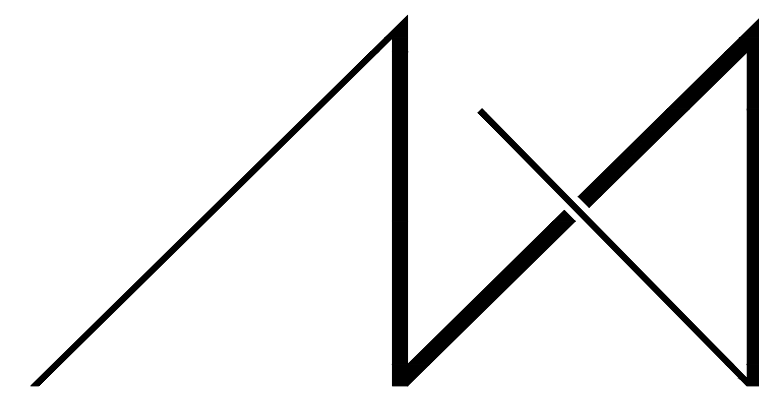

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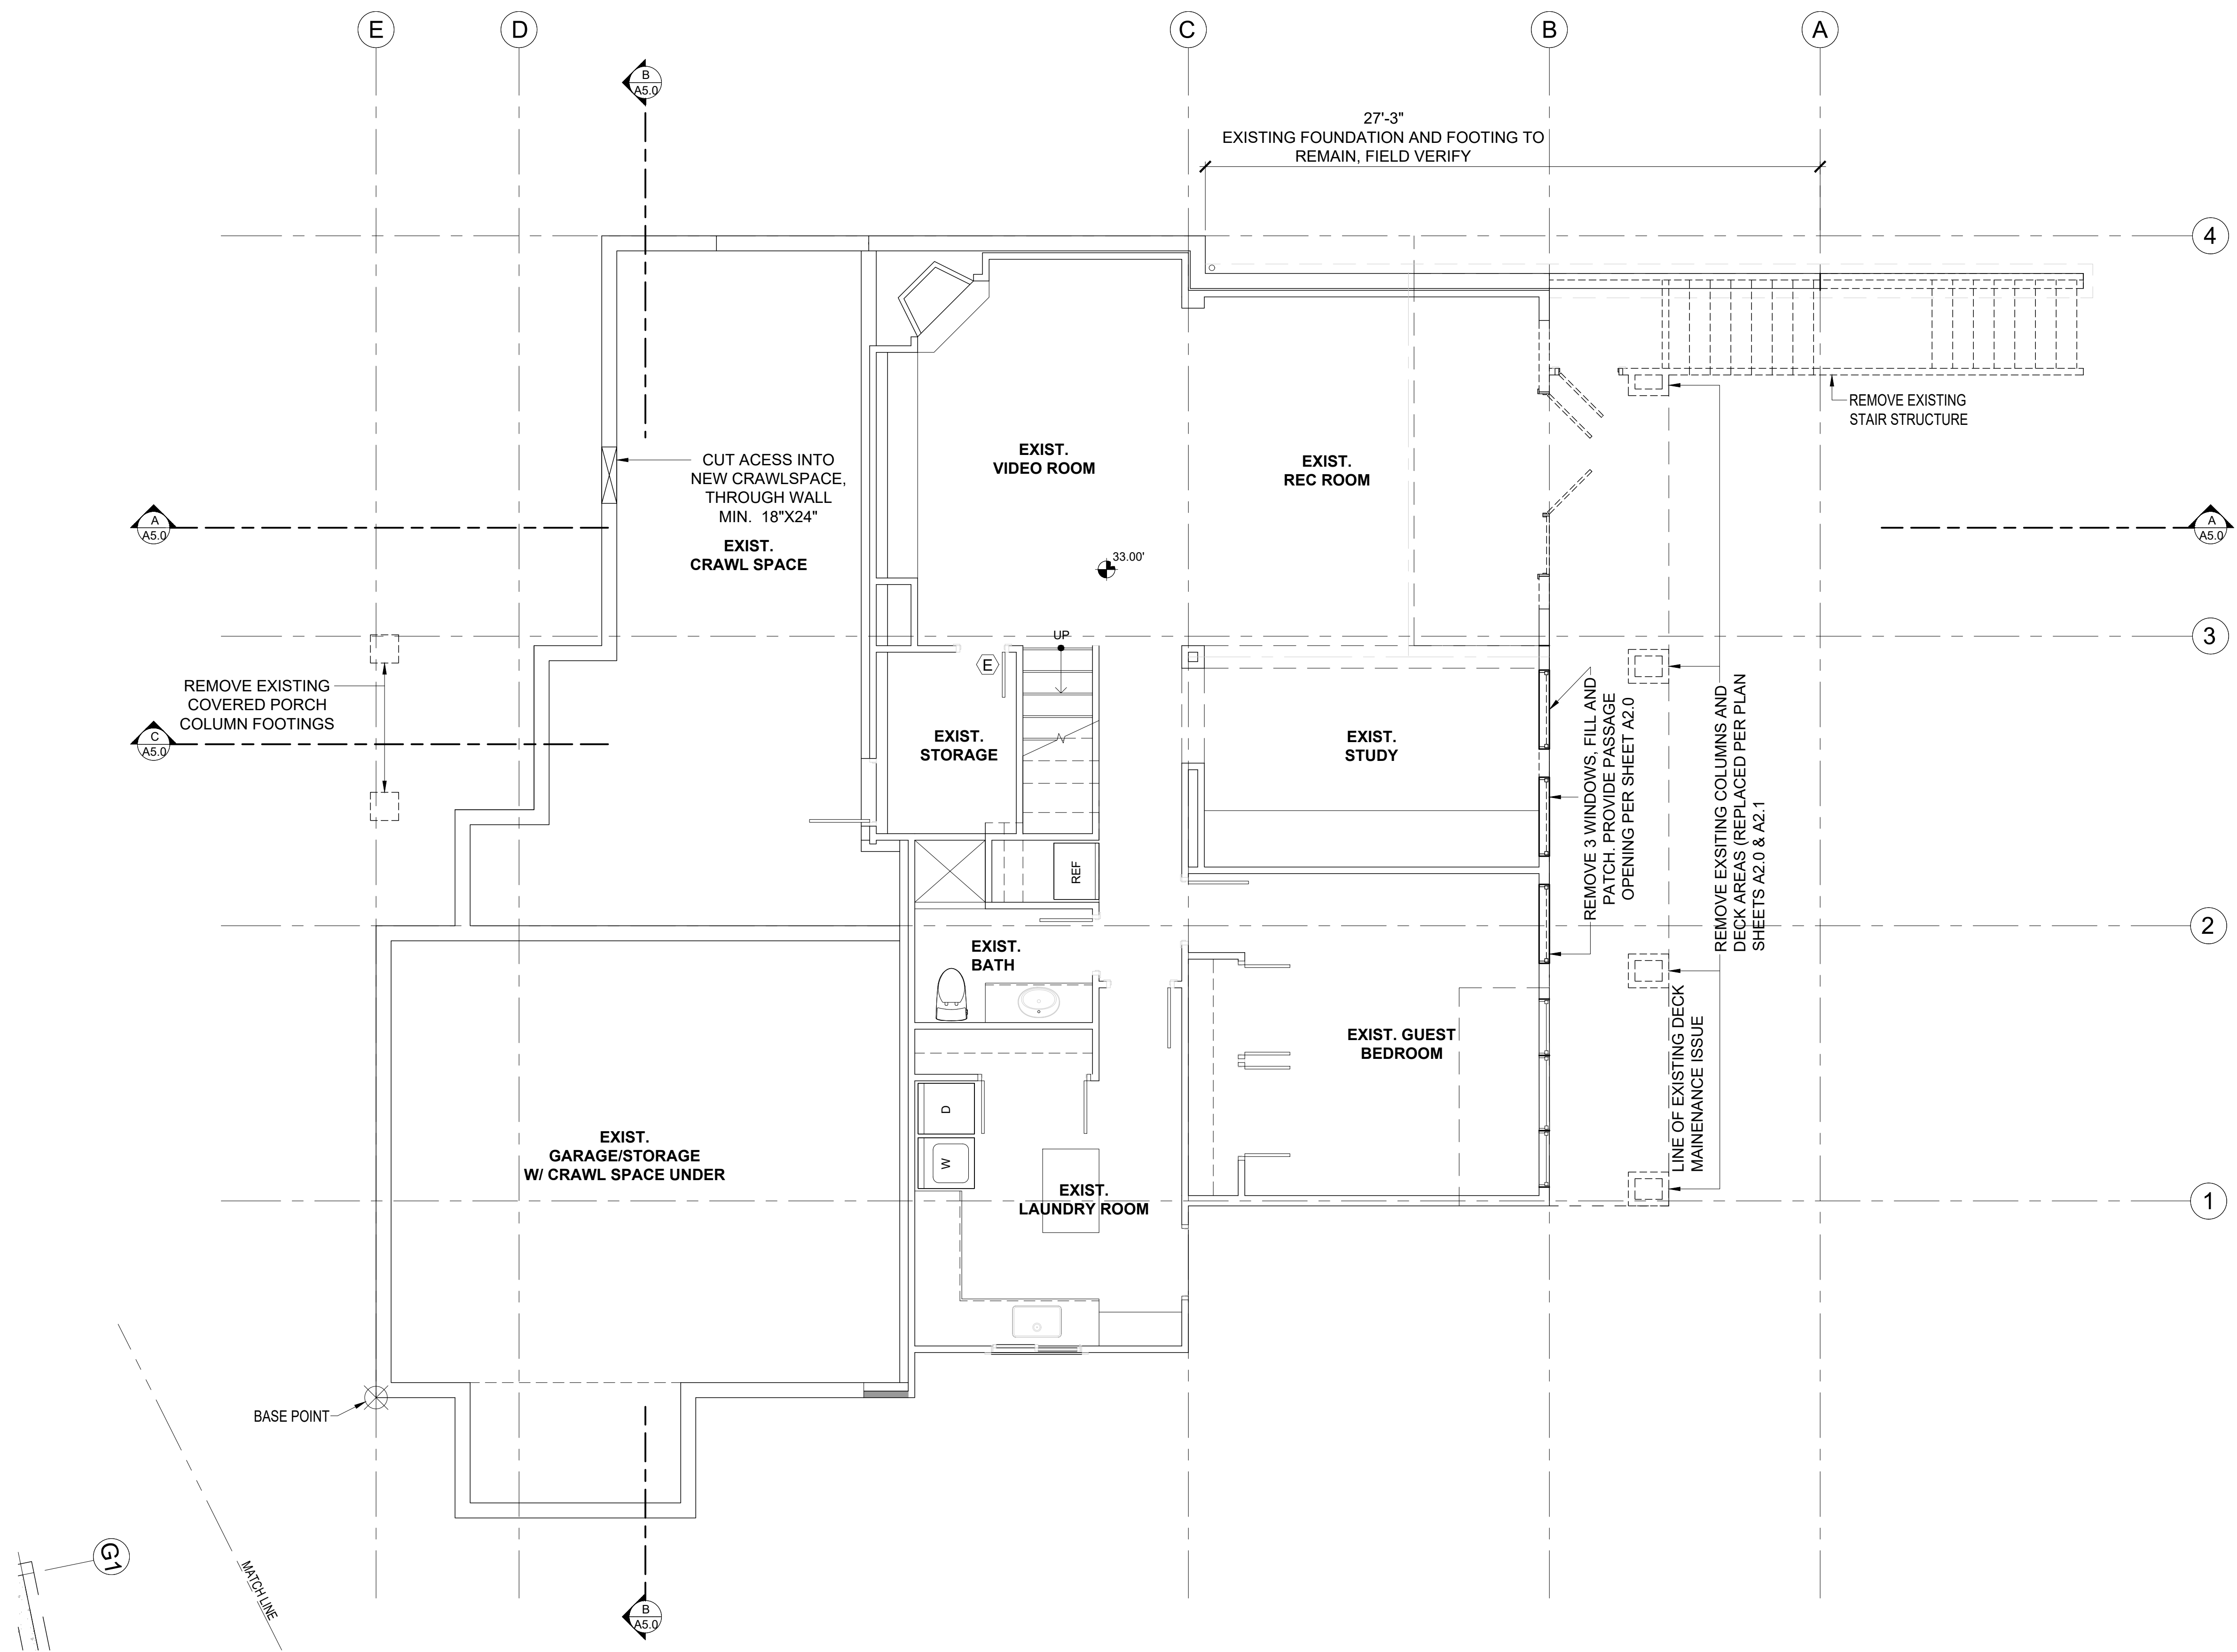
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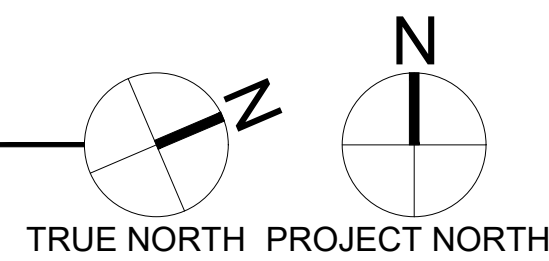
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**PARCEL # 082405-9027**



### BASEMENT PLAN DEMO

SCALE: 1/4" = 1'-0"



### DEMOLITION PLAN NOTES

- CONTRACTOR SHALL VERIFY ALL NOTES, DIMENSIONS & CONDITIONS PRIOR TO CONSTRUCTION.
- REFER TO SITE PLAN FOR ANY SITEWORK TO BE REMOVED.
- RELOCATE EXISTING UTILITIES AS REQUIRED TO ACCOMMODATE NEW ADDITION AND CONSTRUCTION. DISCONNECT OR CAP ANY UTILITIES AS REQUIRED.
- CONTRACTOR TO REMOVE ALL DEMOLITION DEBRIS FROM SITE.
- PROVIDE TEMPORARY SUPPORT WHILE INSERTING NEW BEAMS OR HEADERS.
- CONTRACTOR TO SEAL OFF WORK AREAS TO REDUCE DUST FROM ENTERING OCCUPIED AREAS.
- REMOVE ALL MATERIALS REQUIRED FOR NEW SCOPE OF WORK.
- SEE SHEET A0.3 FOR ADDITIONAL NOTES.

### SYMBOL LEGEND

- EXISTING STRUCTURE TO REMAIN
- EXISTING STRUCTURE TO REMAIN
- EXISTING DOOR TO REMAIN
- EXISTING STRUCTURE TO BE DEMOED

DRAWING NAME:

### DEMOLITION BASEMENT

Drawn By: JMG, RB  
Checked By: EB  
Owner Approval:

PHASE:

### CONSTRUCTION DOCUMENTS


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PLOT SCALE: 1:1

D1.0



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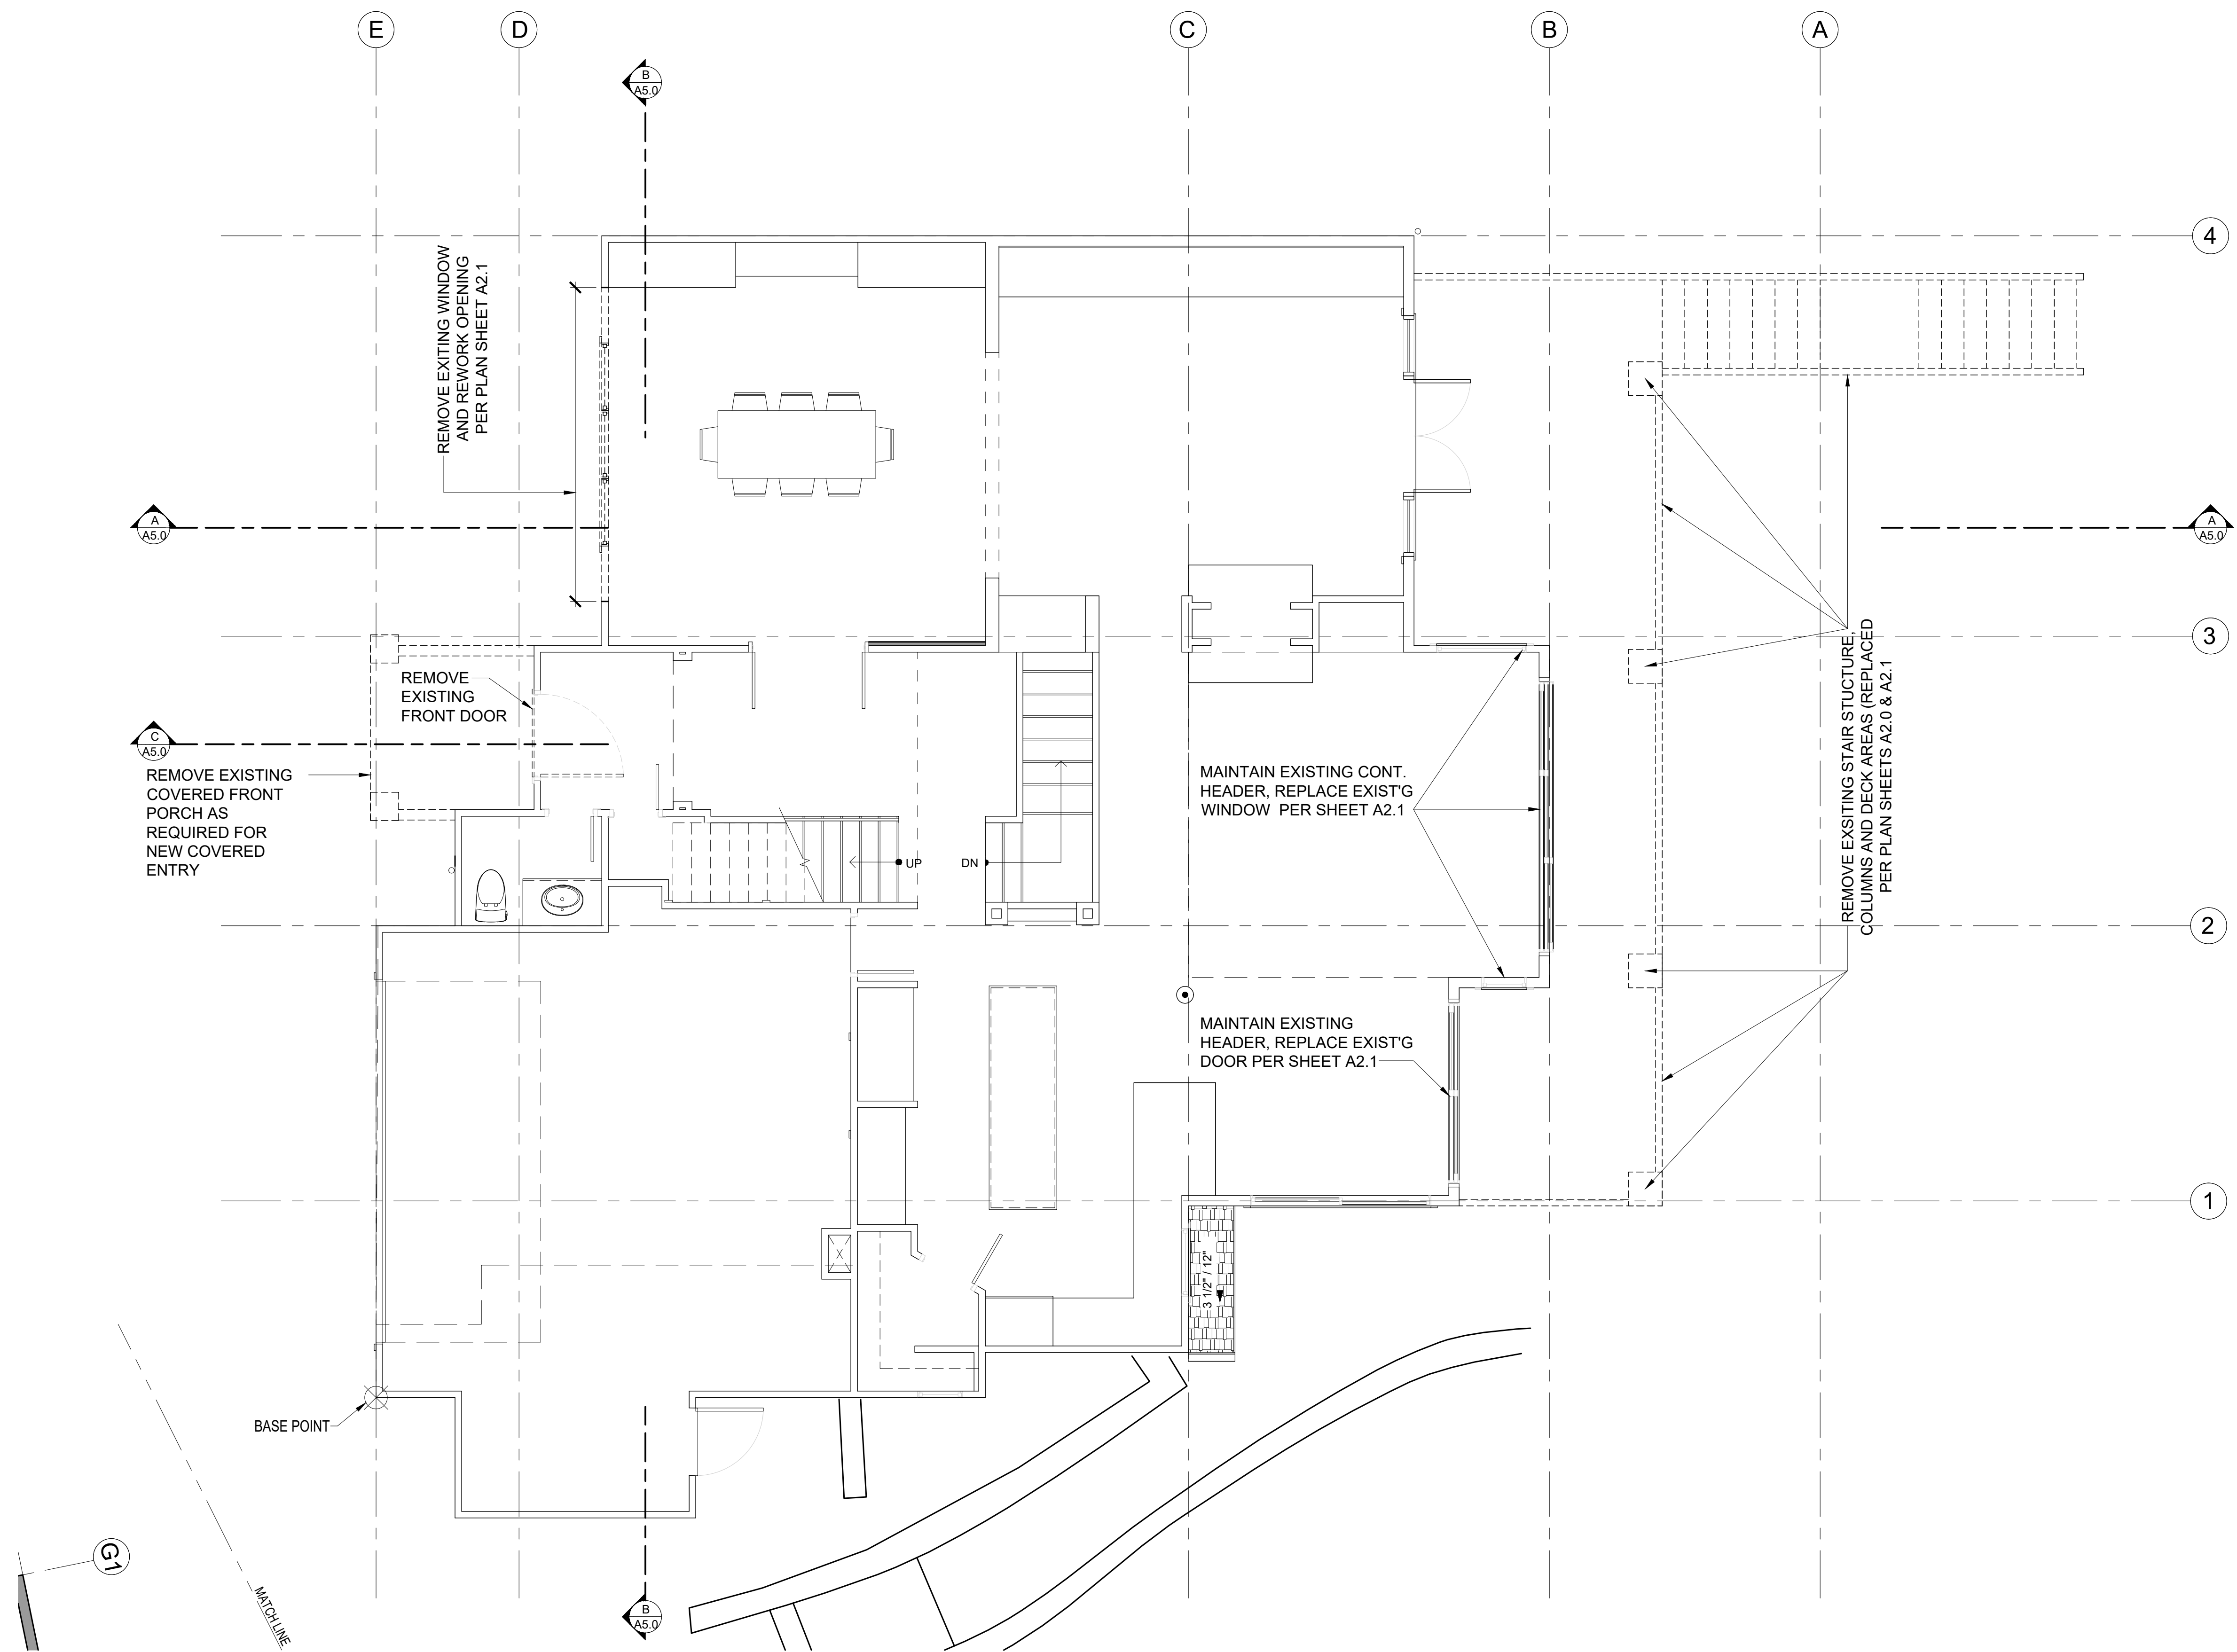
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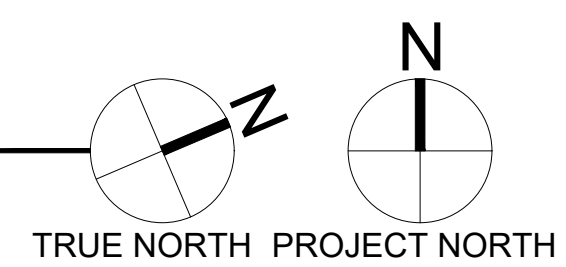
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**1ST FLOOR PLAN DEMO**

SCALE: 1/4" = 1'-0"

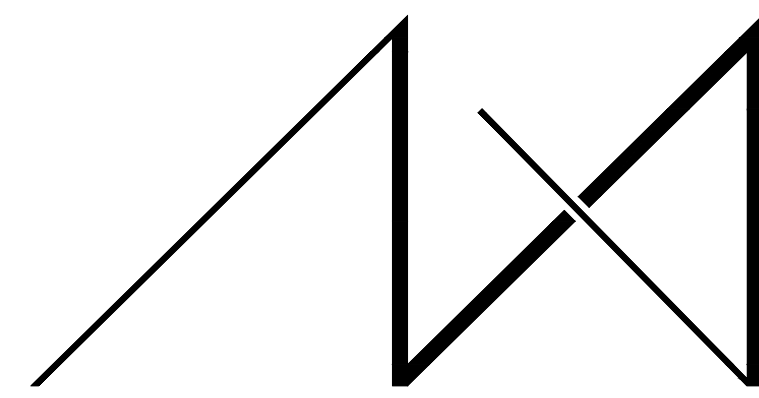

**DEMOLITION PLAN NOTES**

1. CONTRACTOR SHALL VERIFY ALL NOTES, DIMENSIONS & CONDITIONS PRIOR TO CONSTRUCTION.
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8. REMOVE ALL MATERIALS REQUIRED FOR NEW SCOPE OF WORK.
9. SEE SHEET A0.3 FOR ADDITIONAL NOTES.

**SYMBOL LEGEND**

- EXISTING STRUCTURE TO REMAIN
- EXISTING STRUCTURE TO REMAIN
- EXISTING DOOR TO REMAIN
- EXISTING STRUCTURE TO BE DEMOED

DRAWING NAME:

**DEMOLITION  
1ST FLOOR**

Drawn By: JMG, RB  
Checked By: EB  
Owner Approval:

PHASE:

**CONSTRUCTION DOCUMENTS**


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DATE: 12-22-2020

PLOT SCALE: 1:1

**D1.1**



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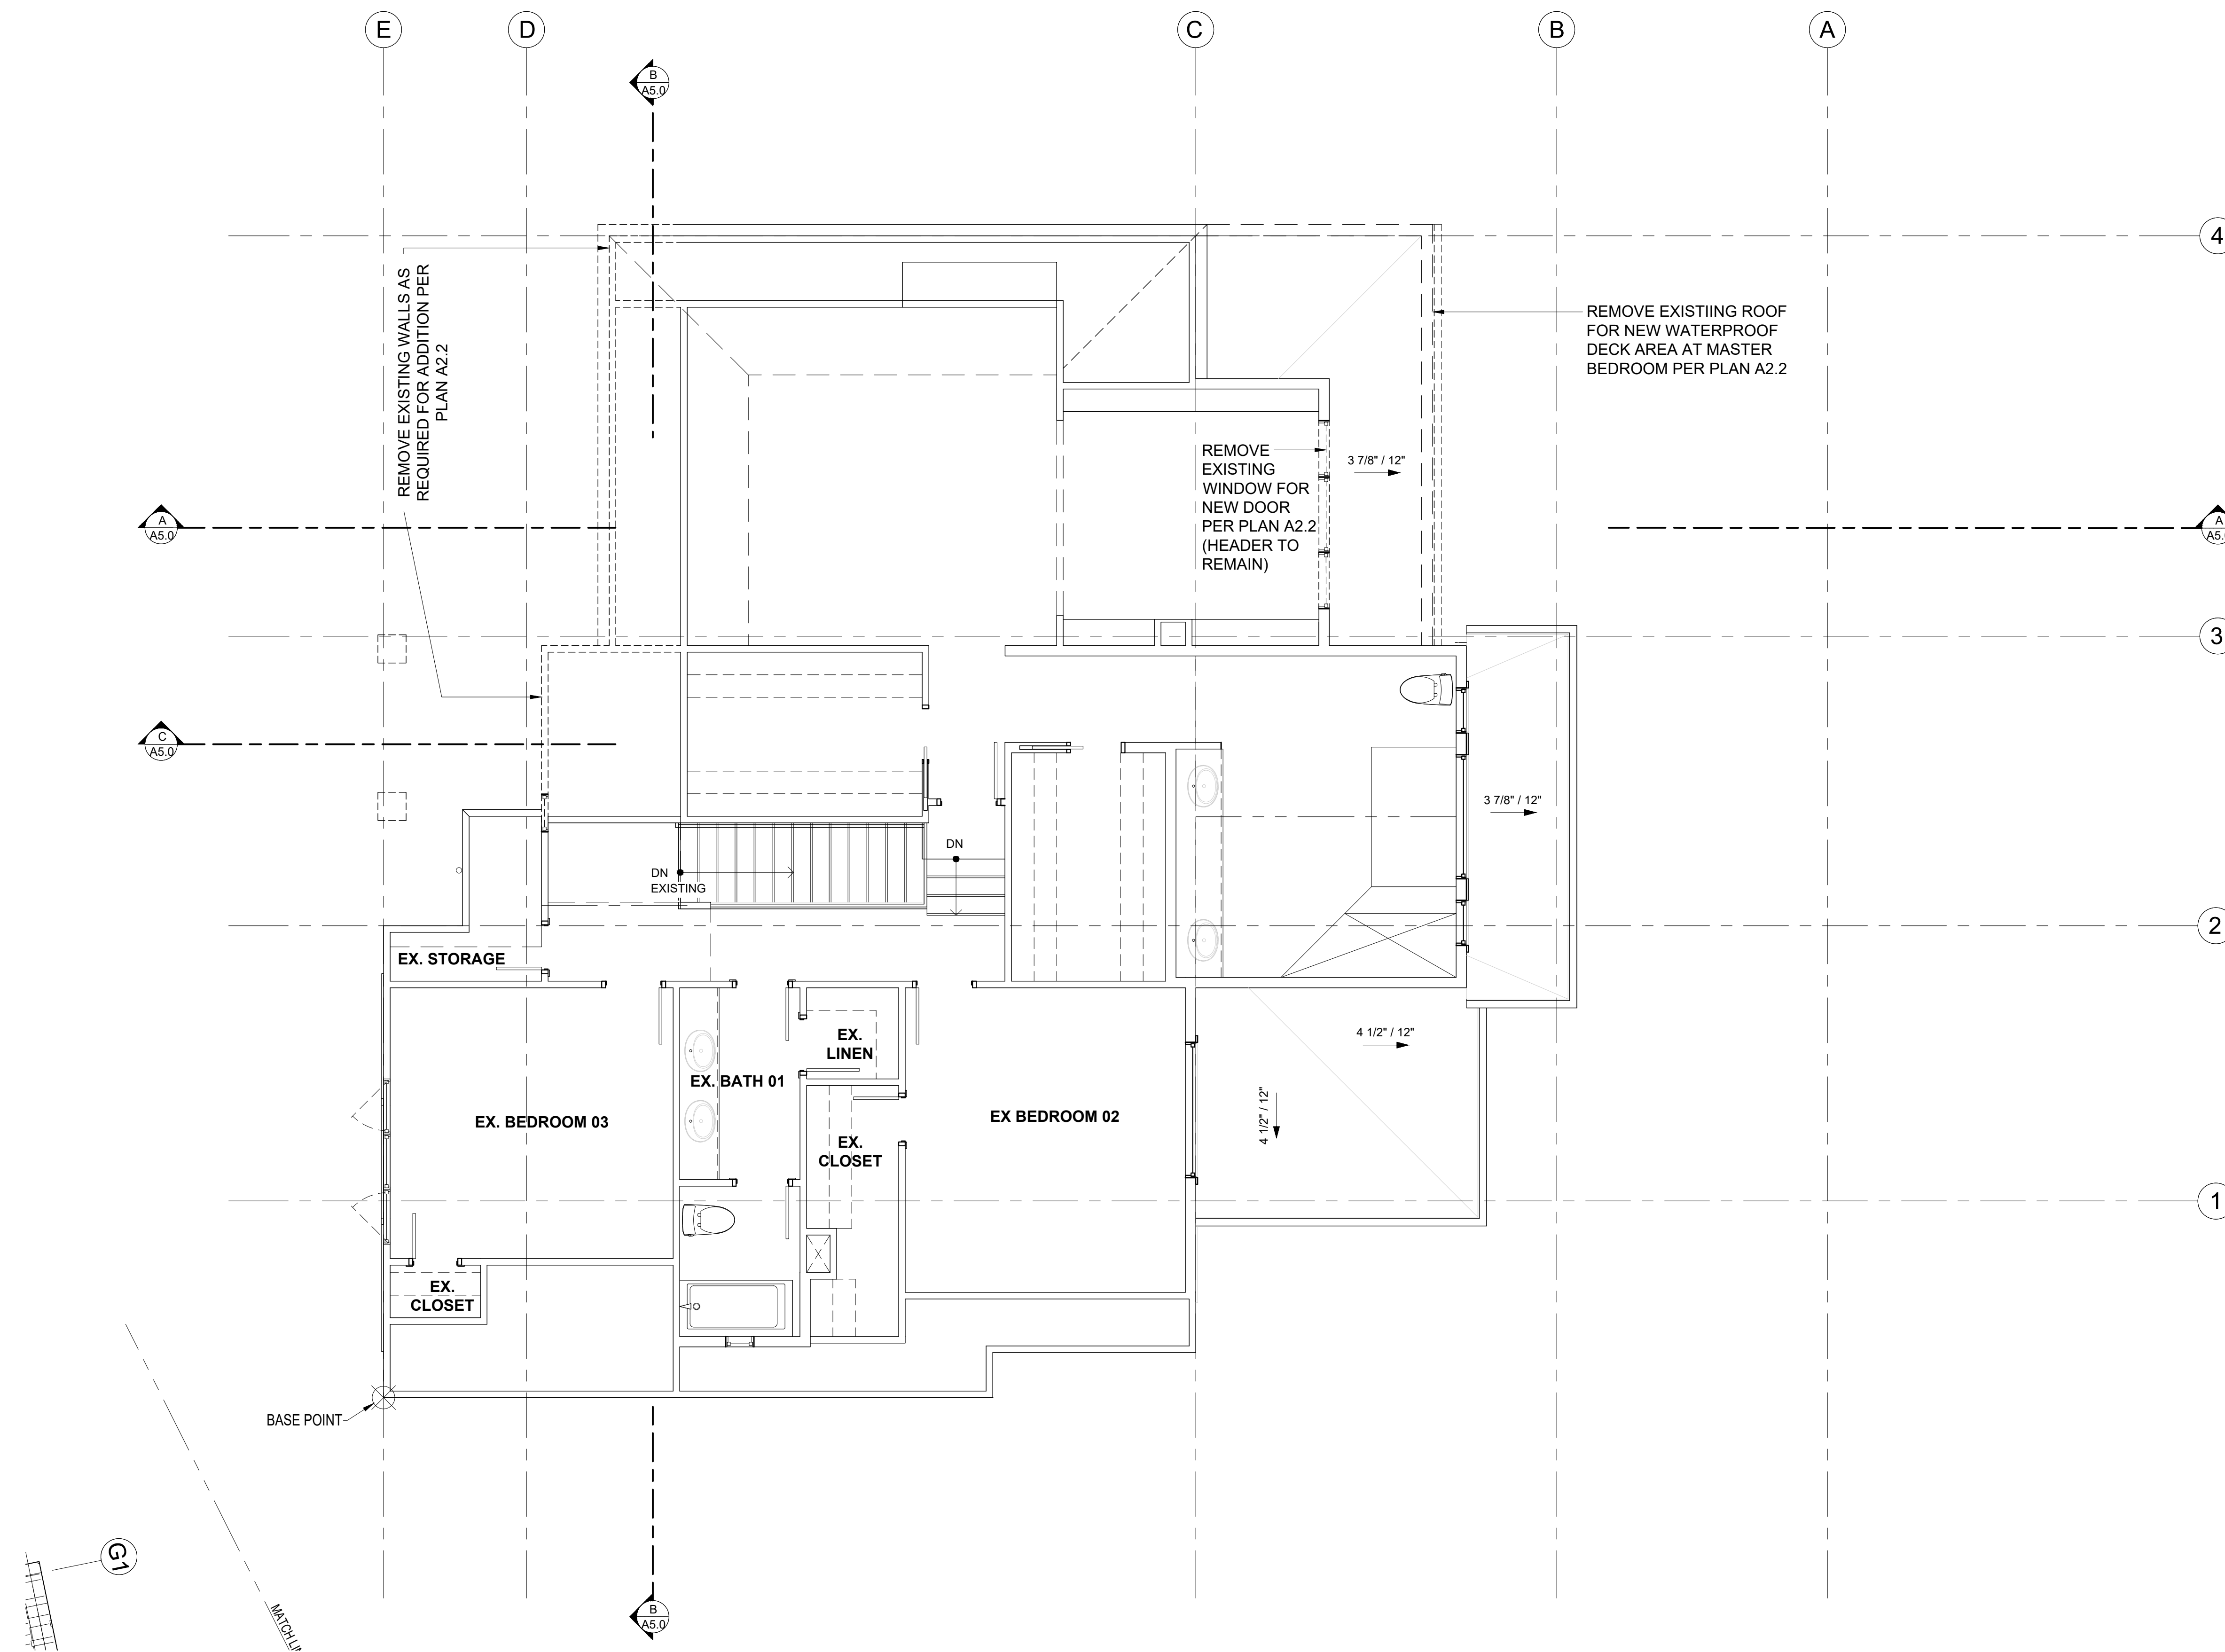
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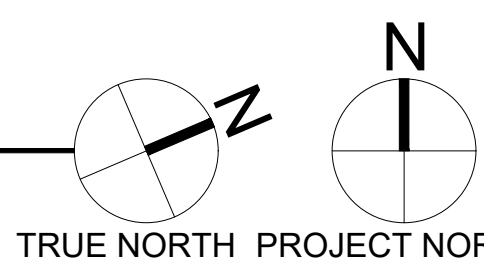
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**PARCEL # 082405-9027**

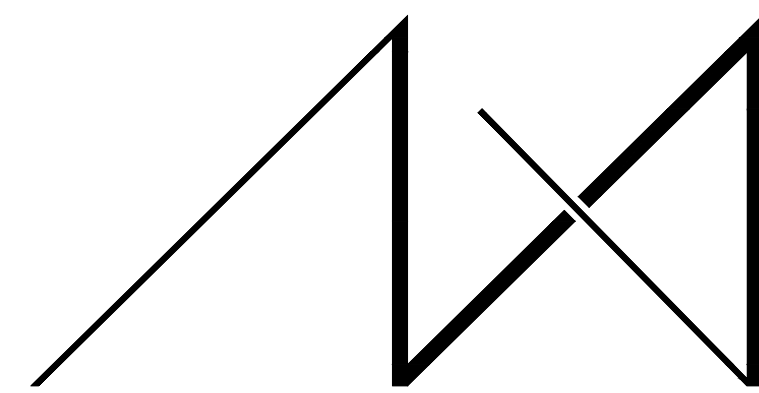

### 2ND FLOOR PLAN DEMO

SCALE: 1/4" = 1'-0"



### DEMOLITION PLAN NOTES

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8. REMOVE ALL MATERIALS REQUIRED FOR NEW SCOPE OF WORK.
9. SEE SHEET A0.3 FOR ADDITIONAL NOTES.

### SYMBOL LEGEND

- EXISTING STRUCTURE TO REMAIN
- EXISTING STRUCTURE TO REMAIN
- EXISTING DOOR TO REMAIN
- EXISTING STRUCTURE TO BE DEMOED

DRAWING NAME:

### DEMOLITION 2ND FLOOR

Drawn By: JMG, RB  
Checked By: EB  
Owner Approval:

PHASE:

### CONSTRUCTION DOCUMENTS

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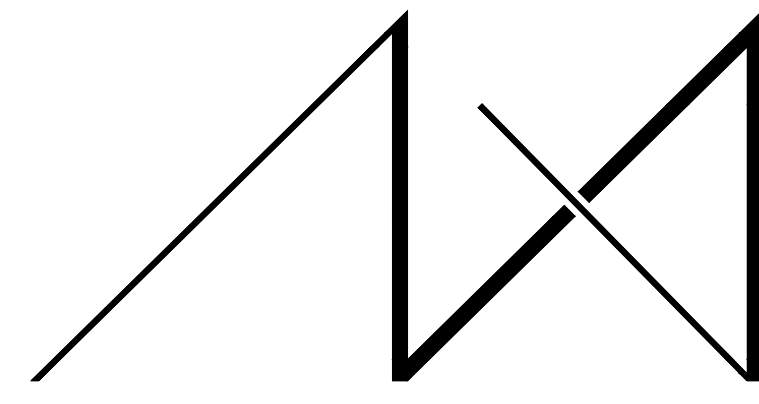
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PLOT SCALE: 1:1

D1.2






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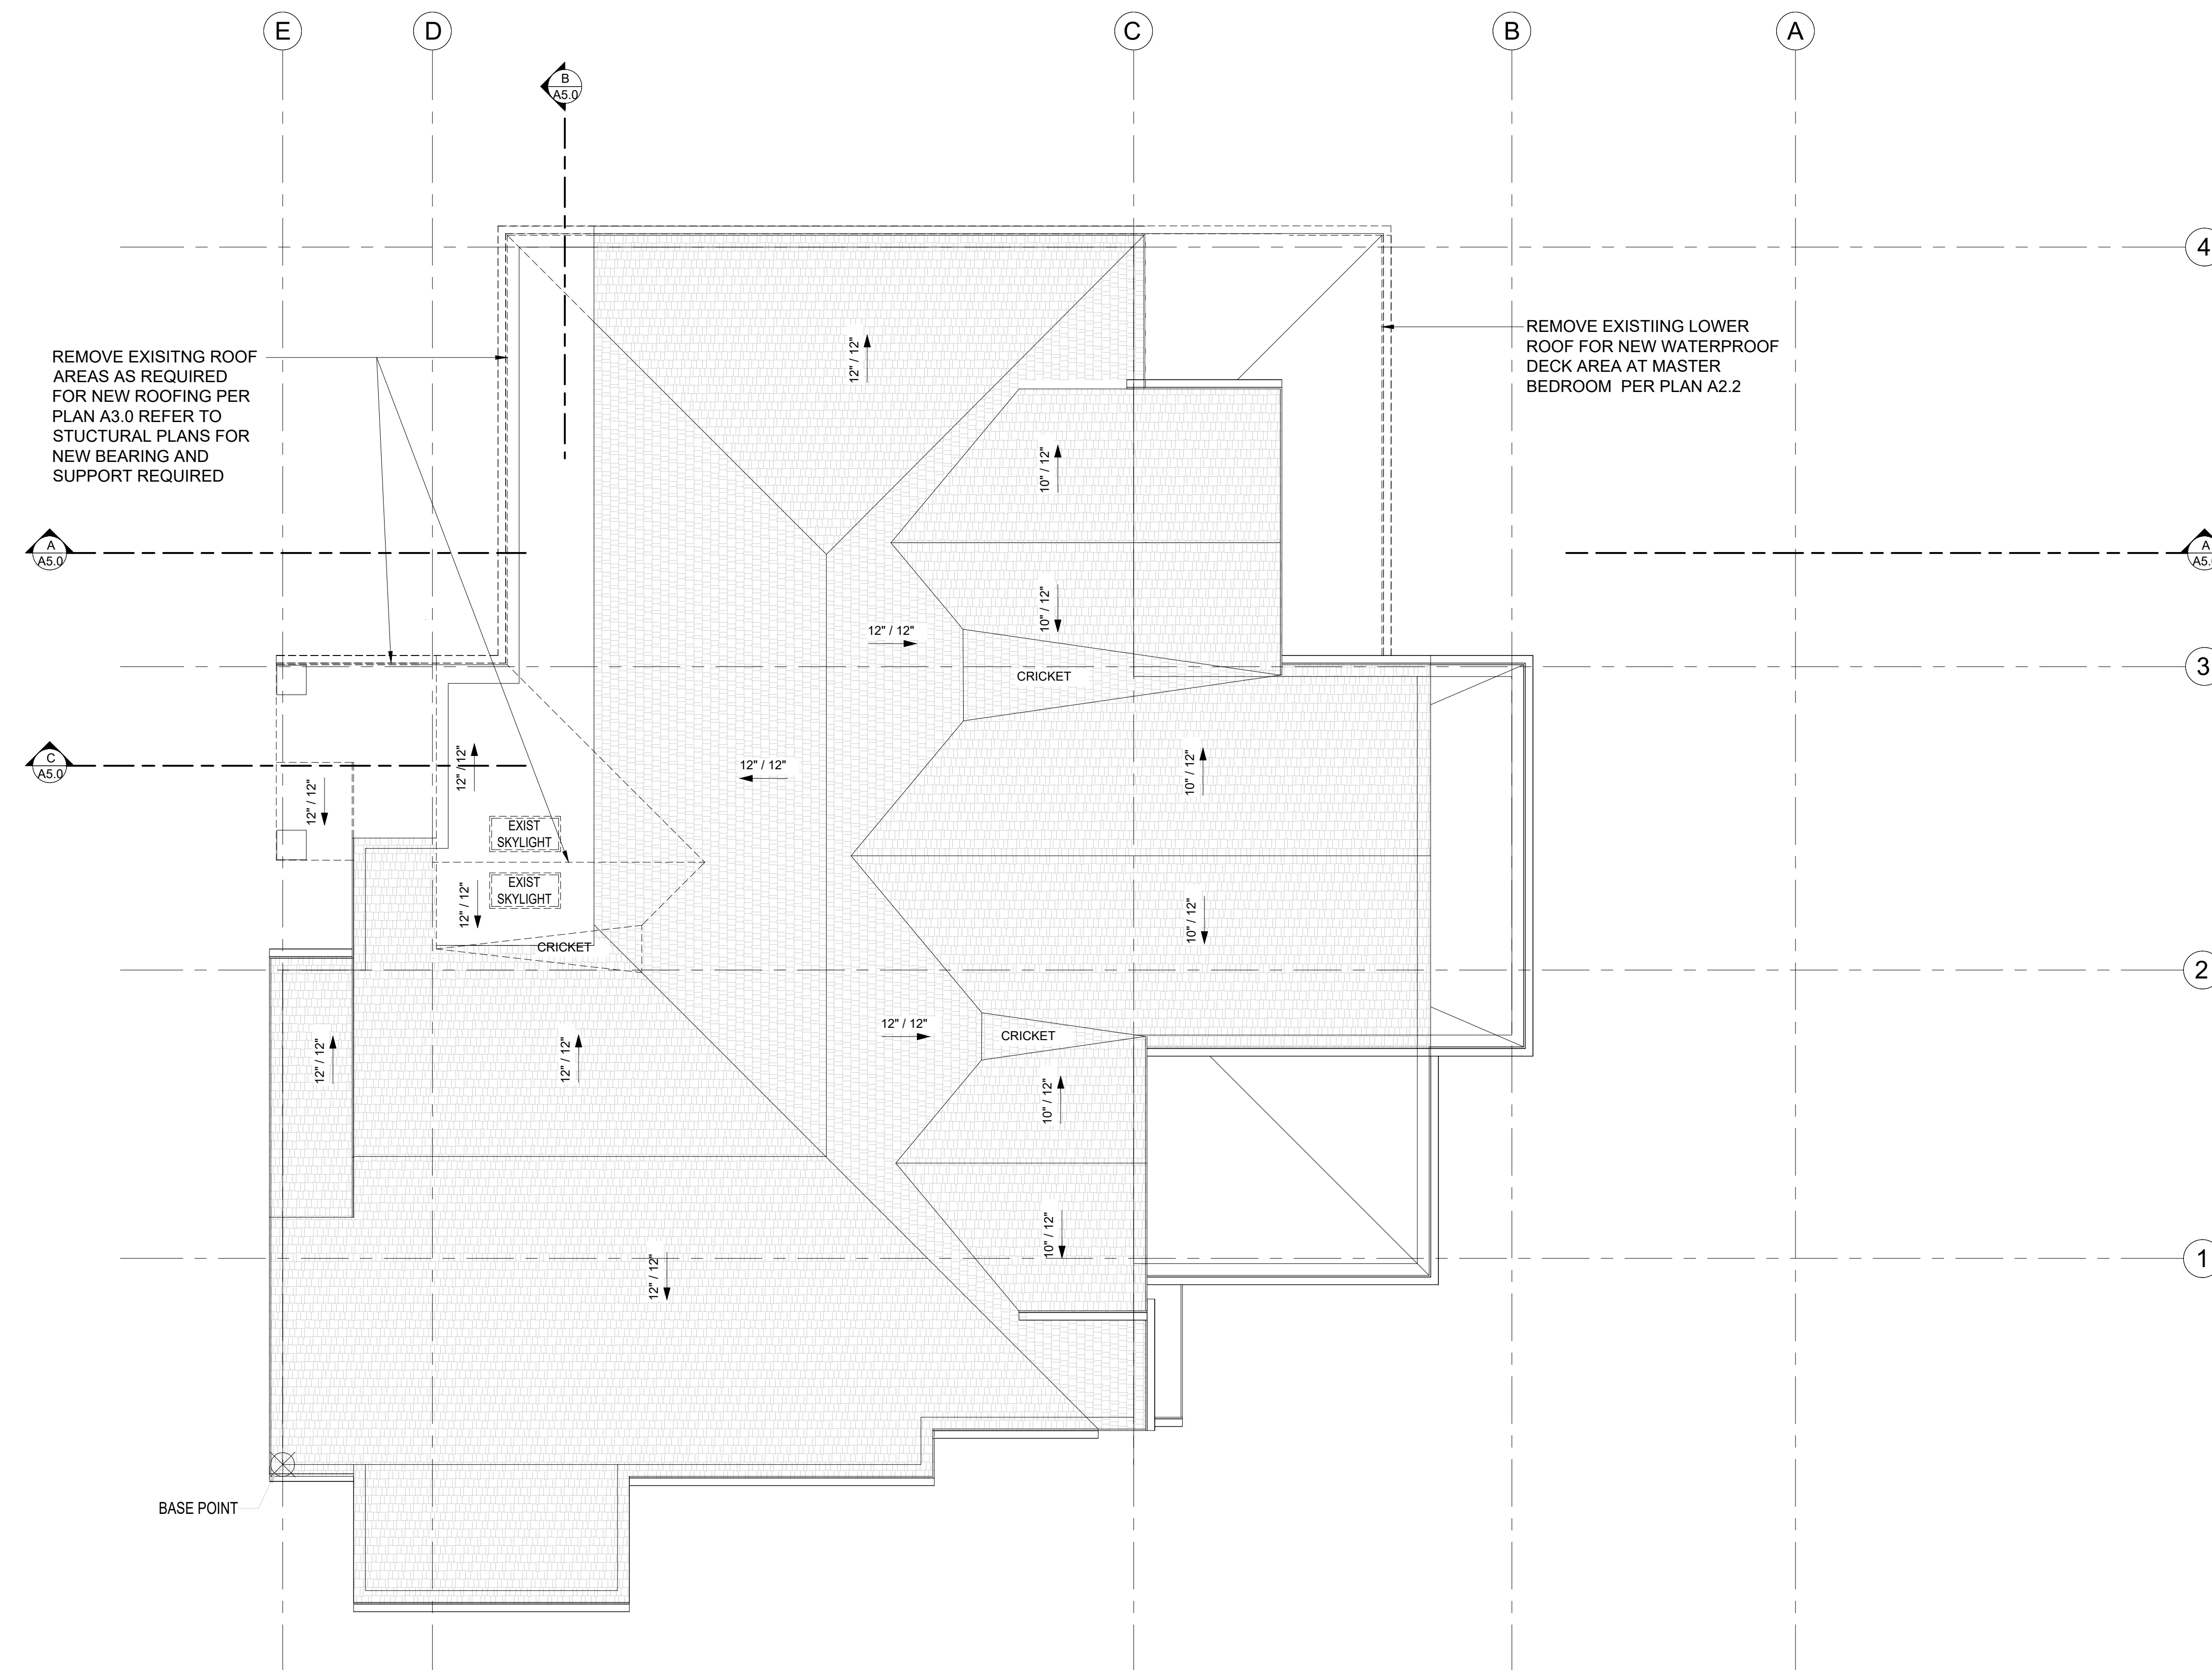
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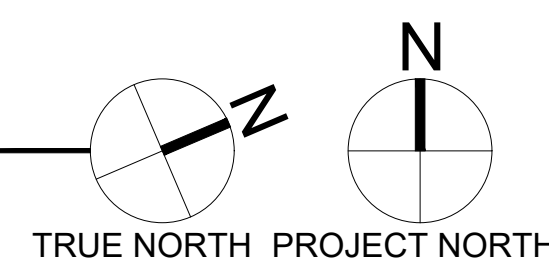
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**ROOF PLAN DEMO**

SCALE: 1/4" = 1'-0"



**DEMOLITION PLAN NOTES**
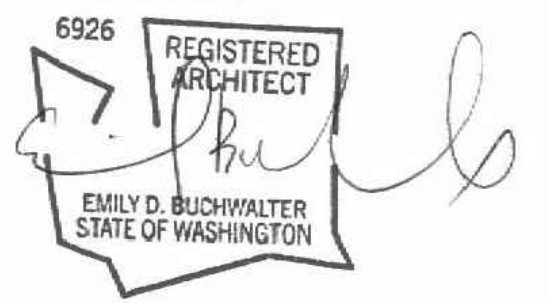
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- 5. CONTRACTOR TO REMOVE ALL DEMOLITION DEBRIS FROM SITE.
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- 7. CONTRACTOR TO SEAL OFF WORK AREAS TO REDUCE DUST FROM ENTERING OCCUPIED AREAS.
- 8. REMOVE ALL MATERIALS REQUIRED FOR NEW SCOPE OF WORK.
- 9. SEE SHEET A0.3 FOR ADDITIONAL NOTES.

**SYMBOL LEGEND**

- EXISTING STRUCTURE TO REMAIN
- EXISTING STRUCTURE TO REMAIN
- EXISTING DOOR TO REMAIN
- EXISTING STRUCTURE TO BE DEMOED

DRAWING NAME:

**DEMOLITION ROOF**

Drawn By: JMG, RB  
Checked By: EB  
Owner Approval:

PHASE:

**CONSTRUCTION DOCUMENTS**


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DATE: 12-22-2020

PLOT SCALE: 1:1

**D1.3**



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MERCER ISLAND, WA 98040
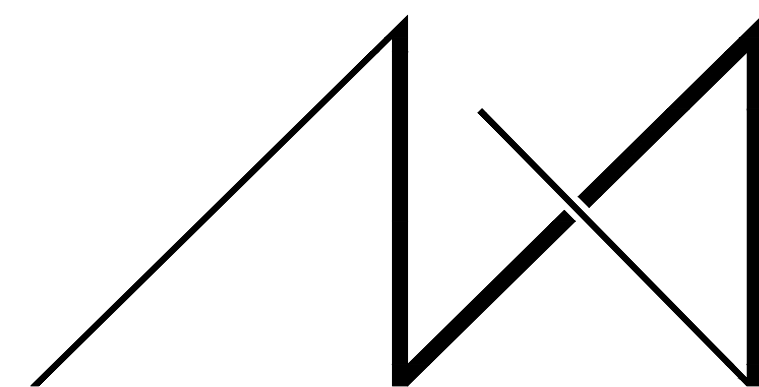
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**PARCEL # 082405-9027**

DRAWING NAME:

**FOUNDATION PLAN**

Drawn By: JMG, RB

Checked By: EB

Owner Approval:

PHASE:

**CONSTRUCTION DOCUMENTS**

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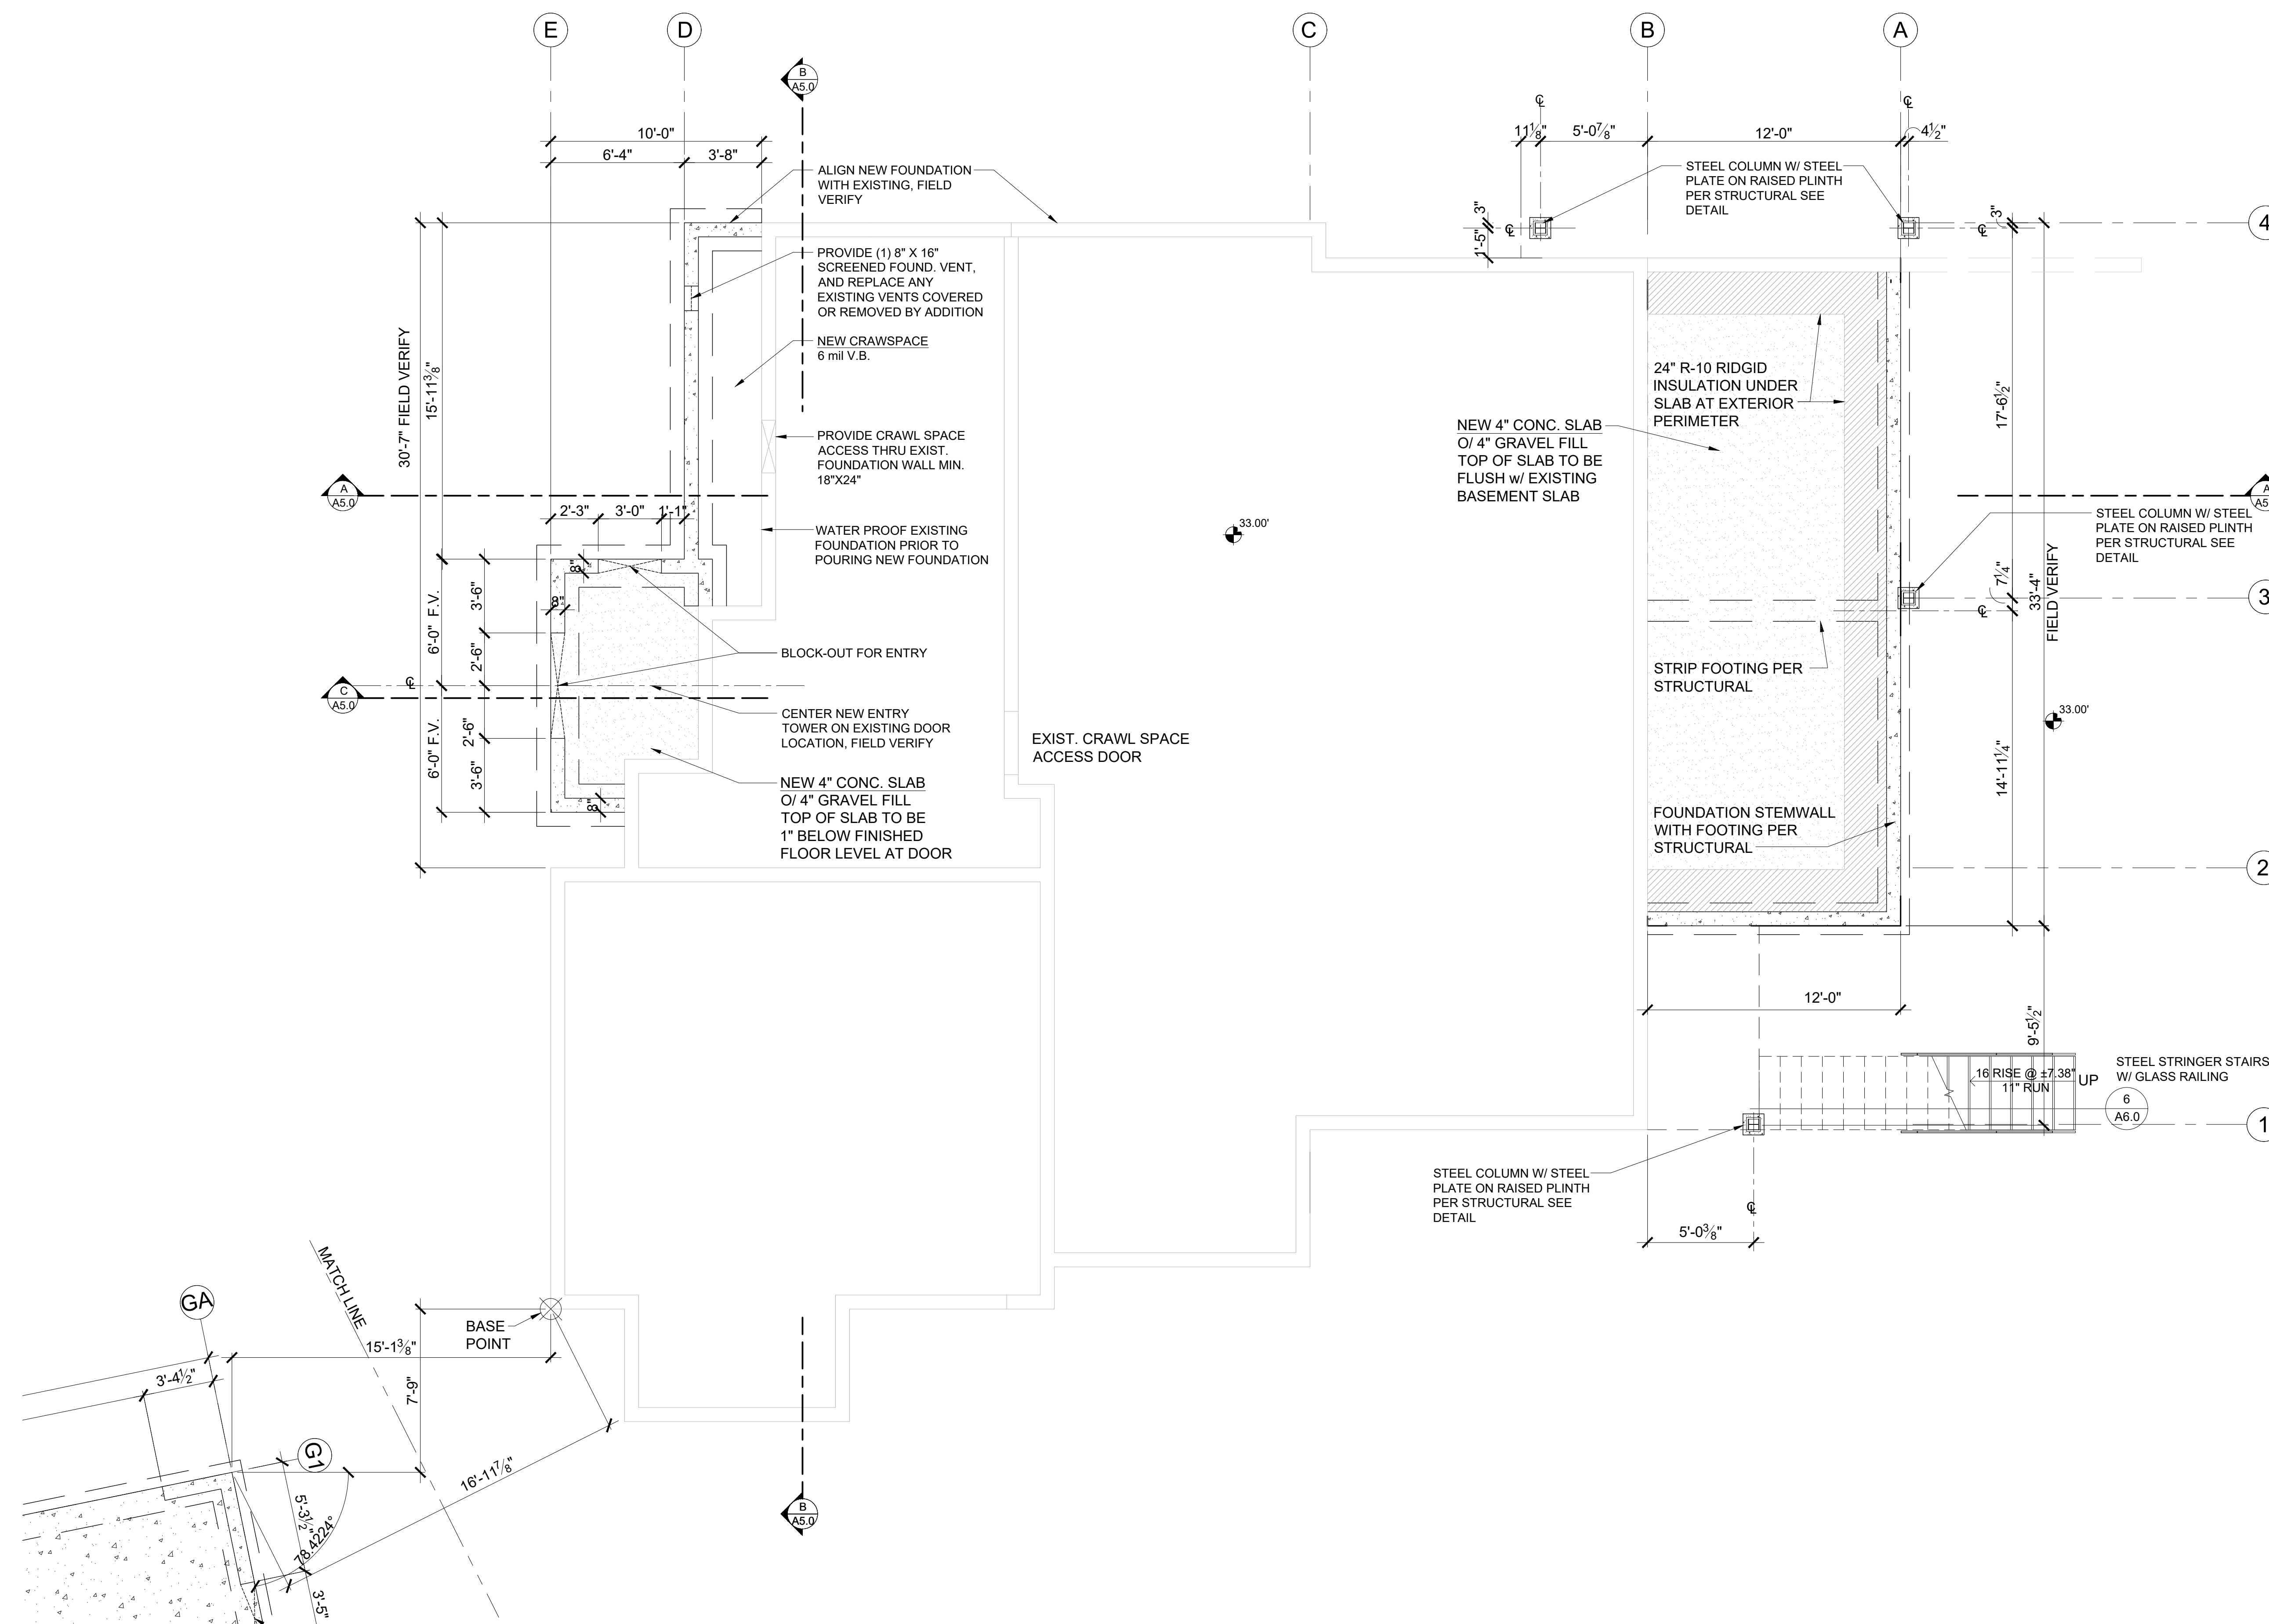
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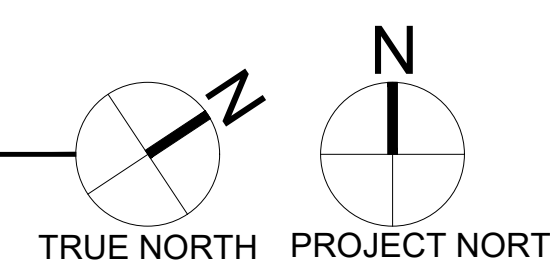
PLOT SCALE: 1:1

**A1.0**



**FOUNDATION PLAN**

SCALE: 1/4" = 1'-0"




CRAWL SPACE - VENTILATION CALCULATION			
Added Crawl Space Area:	51	s.f.	
Ventilation Required:	51	s.f. x 144 s.i.1 / 1,500*	4.9 s.i. Req'd
Use:	16"x8"	Foundation Vents	
Vent Area =	98.0	s.i. - 25% reduction + 1/4" mesh	73.5 s.i.
Number of vents required:	4.9	s.i. / vent area	0.1 vents
Provide:	1.0		73.5 Provided
Total Min. Ventilation Provided =	73.5	s.i. IS GREATER THAN	4.9 s.i. Req'd

\* 2015 IRC - PER R408.1 THE TOTAL AREA OF VENTILATION OPENINGS SHALL BE PERMITTED TO BE REDUCED TO 1/1,500 OF THE UNDER-FLOOR AREA WHERE THE GROUND SURFACE IS COVERED WITH AN APPROVED CLASS I VAPOR RETARDER MATERIAL AND THE REQUIRED OPENINGS ARE PLACED TO PROVIDE CROSS VENTILATION OF THE SPACE

**SYMBOL LEGEND**

- EXIST. FOUNDATION WALL
- SLAB ON GRADE
- NEW FOUNDATION WALL W/ FOOTING
- POST - VERIFY SIZE AND TYPE WITH STRUCTURAL PLAN
- CRAWL SPACE VENT

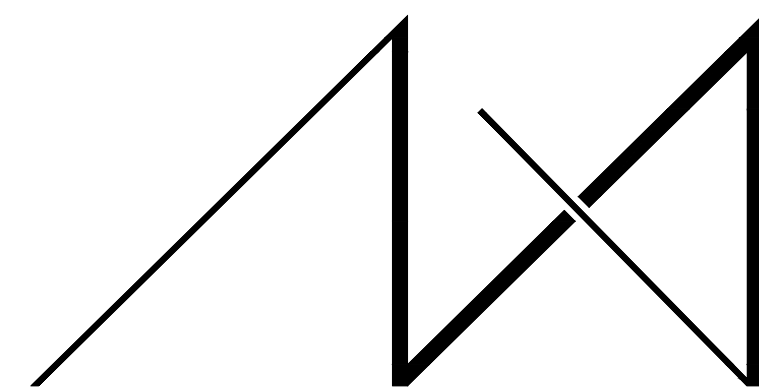


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PROJECT / CLIENT:

**9820 SE 35TH PLACE**

ACHIN & MARY CHEN  
9820 SE 35TH PLACE  
MERCER ISLAND, WA 98040

JOB ADDRESS:

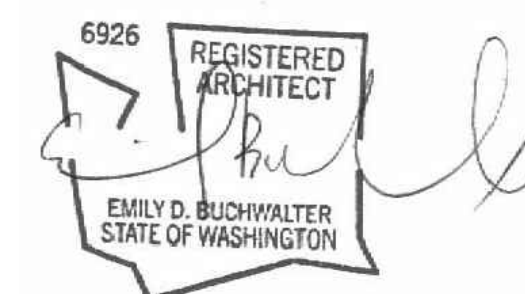9820 SE 35TH PLACE  
MERCER ISLAND, WA 98040  
PARCEL # 082405-9027

DRAWING NAME:

**BASEMENT  
CONSTRUCTION PLAN**

Drawn By: JMG, RB  
Checked By: EB  
Owner Approval:

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**CONSTRUCTION DOCUMENTS**

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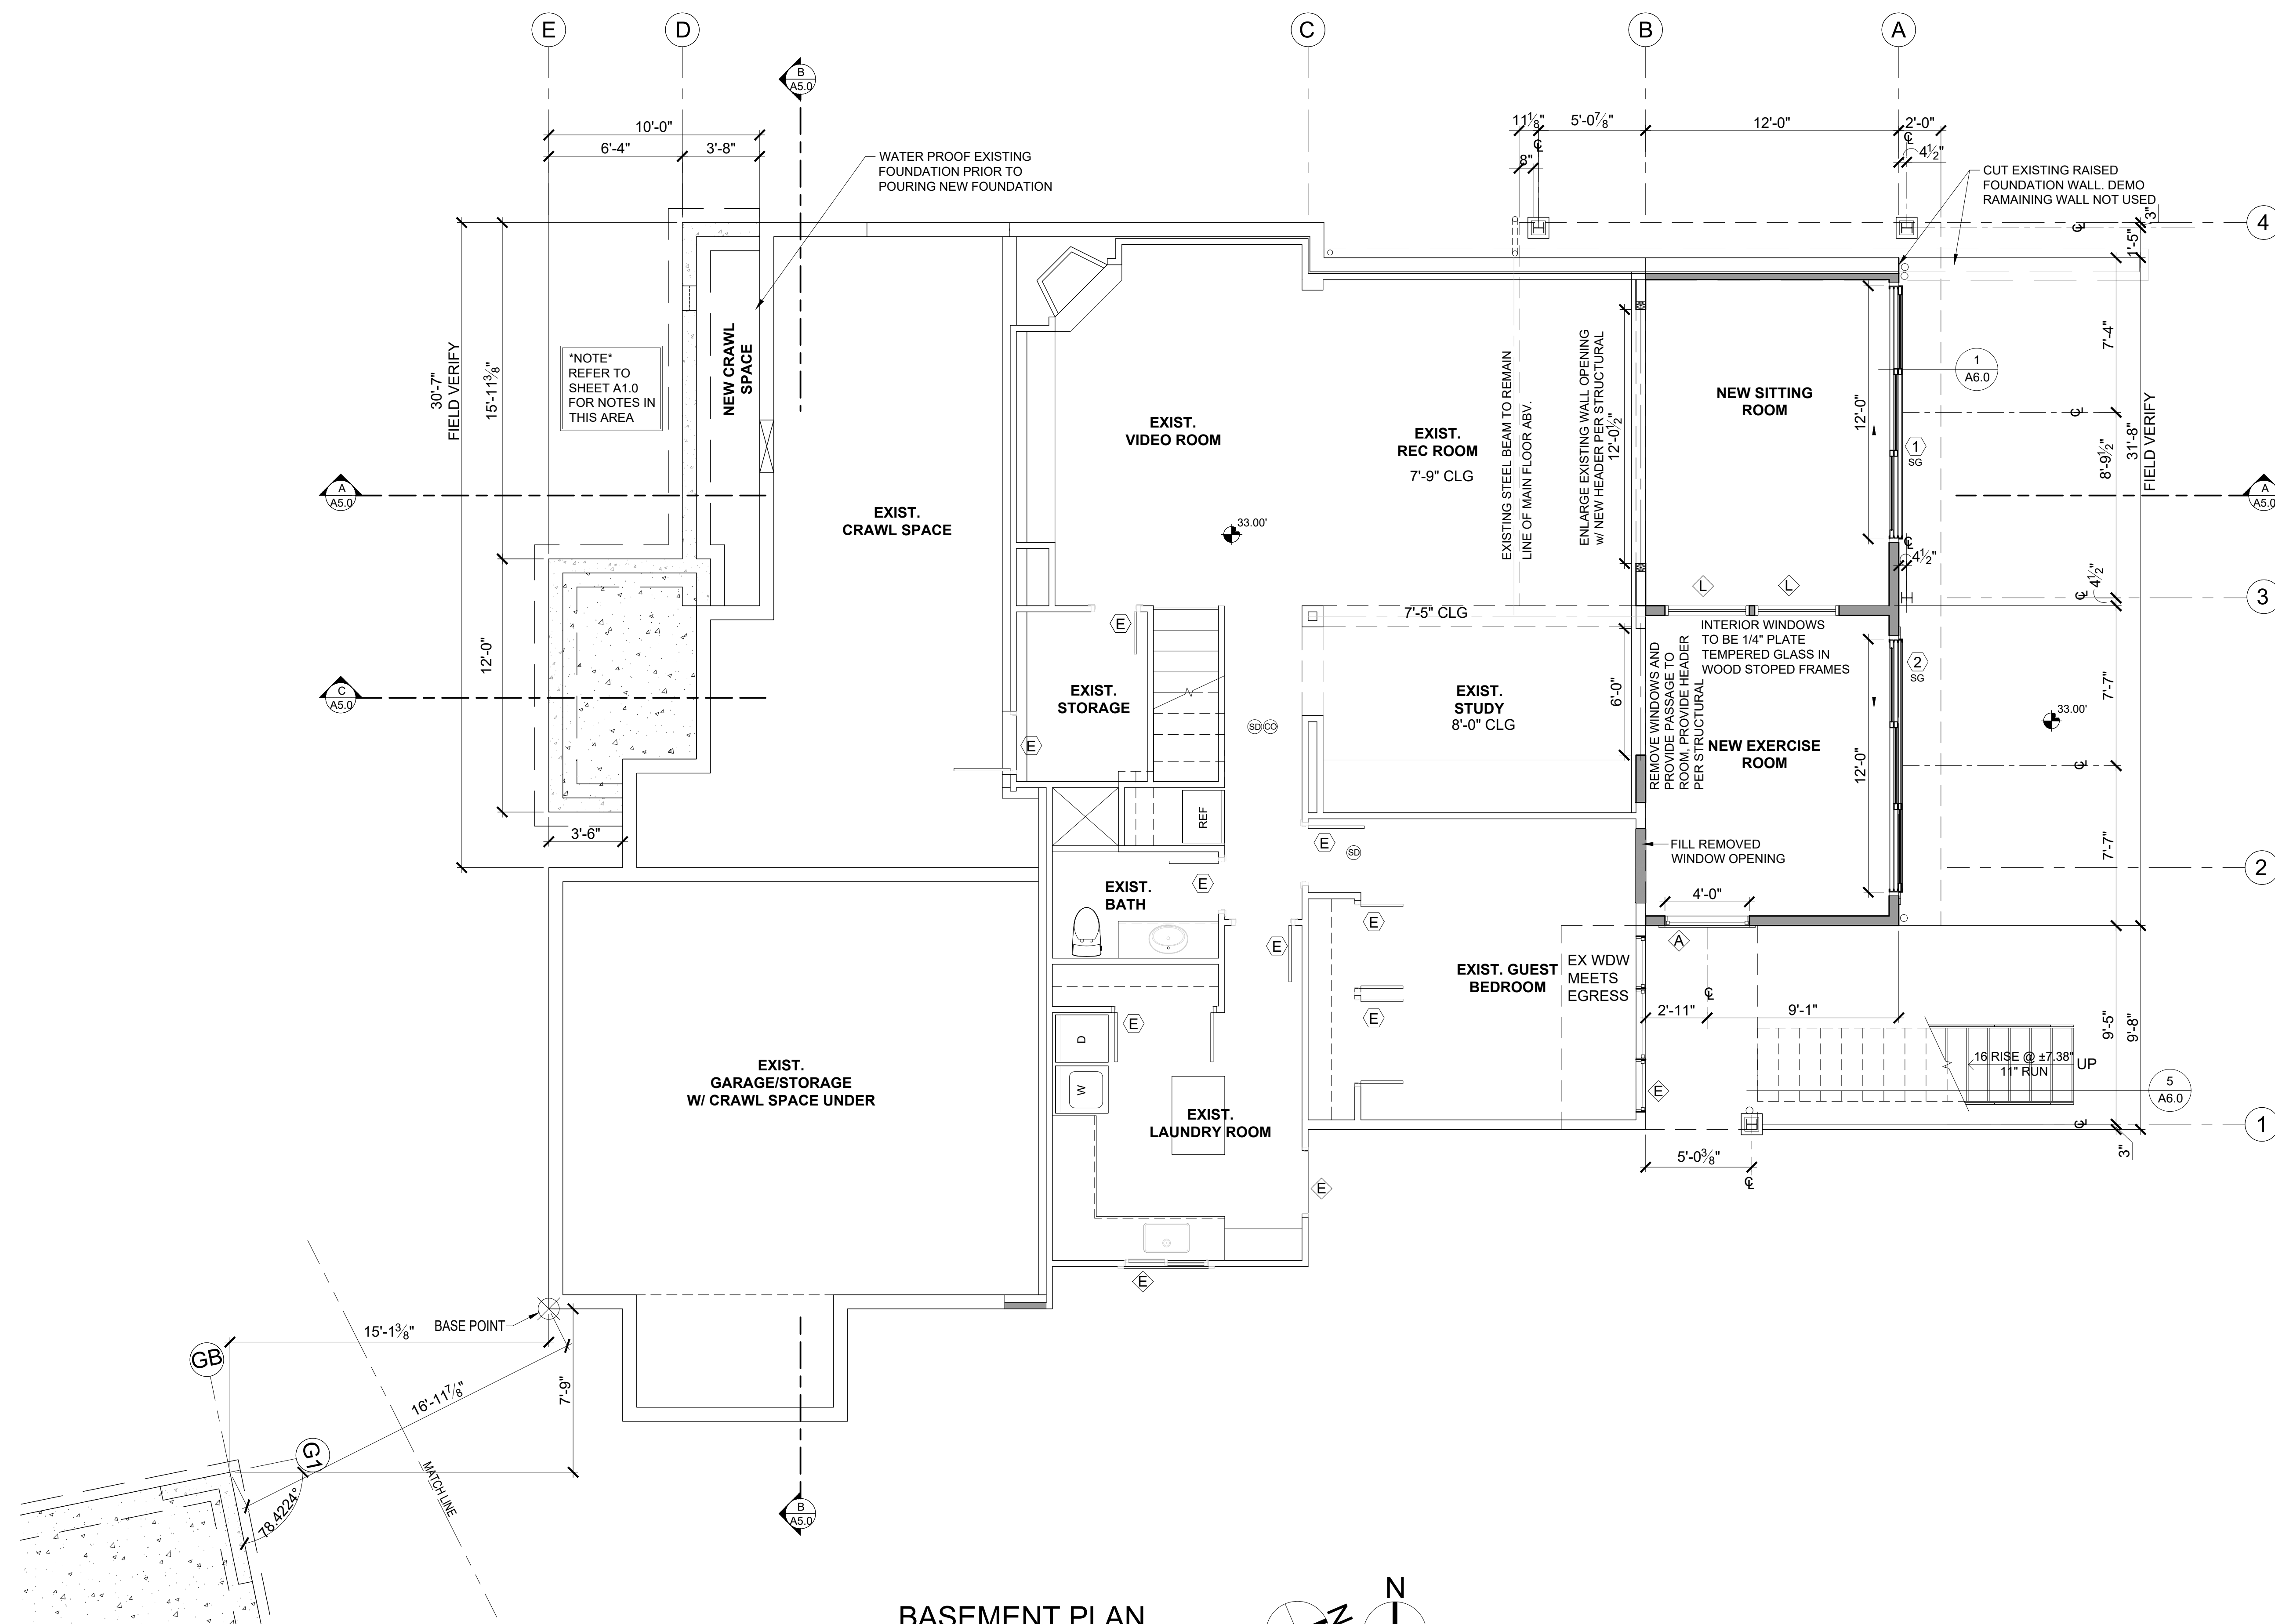
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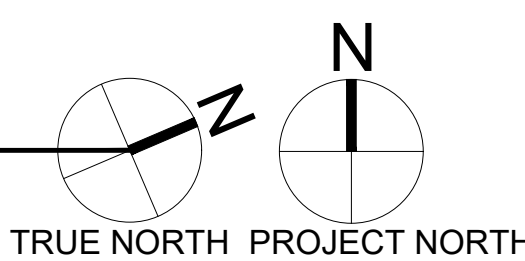
PLOT SCALE: 1:1

**A2.0**



**BASEMENT PLAN**

SCALE: 1/4" = 1'-0"



**FLOOR PLAN NOTES**

- CONTRACTOR SHALL VERIFY ALL NOTES, DIMENSIONS & CONDITIONS PRIOR TO CONSTRUCTION.
- ALL POSTS, BEAMS & HEADERS SEE STRUCTURAL DRAWINGS.
- PROVIDE SOLID BLOCKING OVER SUPPORTS.
- PROVIDE FIRE BLOCKING @ ALL PLUMBING PENETRATIONS.
- WINDOWS & DOORS ARE SHOWN & NOTED AS NOMINAL SIZES.
- DOOR JAMB 4.5" U.N.O.
- SEE ELEVATIONS SHEETS A4.0 & A4.1 FOR WINDOW & DOOR HEADER HEIGHTS ABOVE FINISHED FLOOR.
- ALL WOOD IN CONTACT WITH CONCRETE TO BE PRESSURE TREATED.
- EXTERIOR WALLS TO BE 2x6 STUDS @ 16" O.C., U.N.O.
- INSTALL SIMPSON CONC. TO WOOD HOLD-DOWNS PER STRUCTURAL DRAWINGS. ALSO SEE MANUFACTURER'S SPECS.
- SMOKE & CARBON MONOXIDE DETECTORS: VERIFY LOCATIONS OF EXISTING DETECTORS IN HOME AND UPDATE PER CODE.
  - SHALL BE 110V INTERCONNECTED W/ BATTERY BACKUP.
  - SHALL SOUND AN ALARM AUDIBLE IN ALL SLEEPING ROOMS.
  - SHALL BE INSTALLED ON EACH FLOOR AND IN ALL BEDROOMS.
  - SHALL BE INSTALLED IN EACH LOCATION WHERE THERE IS A CEILING CHANGE OF GREATER THAN 24".
- SEE SHEET A0.1 FOR ADDITIONAL NOTES.
- FIXTURES SHALL BE SPACED IN ACCORDANCE WITH FIGURE R307.1.
- ALL EXPOSED STEEL, METAL FLASHING AND COPING TO BE POWDER COATED, COLOR TO BE DETERMINED.

**SYMBOL LEGEND**

- SMOKE DETECTOR
- CARBON MONOXIDE DETECTOR
- DOORS
- WINDOWS
- EXIST. FOUNDATION WALL
- SLAB ON GRADE
- NEW FOUNDATION WALL w/ FOOTING
- NEW 2X WALLS
- EXISTING 2X WALLS
- BRICK WALLS
- POST - VERIFY SIZE AND TYPE WITH STRUCTURAL PLAN

**HOUSE VENTILATION**


2015 IRC - PROVIDE WHOLE HOUSE VENTILATION PER M1507, INTERMITTENT WHOLE HOUSE VENTILATION USING EXHAUST FAN PER 1507.3, TABLE 1507.3.3(1) & TABLE 1507.3.3(2), PROVIDE CONTROLS PER 1507.3.2. COMPLY WITH WSEC R403.6

SYMBOL	LOCATION	MINIMUM FAN REQUIREMENTS
	Bath & Powder	Min. 50 cfm (INTERMITTENT) @ 0.25" WG (TABLE M1507.4)
	Kitchen	Min. 100 cfm (INTERMITTENT) @ 0.25" WG (TABLE M1507.3) (Range hood or down draft exhaust fan rated at min. 100 cfm at 0.10" wg may be used for exhaust fan requirement.) If over 400 cfm, makeup air is required in the same room per M1503.4.
	Laundry Room	Min. 180 cfm (INTERMITTENT) @ 0.25" WG - to function and be labeled as whole house fan (4-6 BEDROOMS 3001+ 4500 SF.) TO OPERATE AT LEAST 50% OF TIME IN EACH 4-HOUR SEGMENT

DRYER VENT PER (TABLE M1507.4.5.1) VENTED TO OUTSIDE  
\*ALL FANS TO VENT TO OUTSIDE  
\*PER M1507.3.4 WHERE WHOLE HOUSE VENTILATION USING EXHAUST FANS ARE PROVIDED, OPERABLE WINDOWS WITH AN OPENABLE AREA NOT LESS THAN 4 SQUARE INCHES OF NET FREE AREA OF OPENING FOR EACH 10 CFM OF OUTDOOR AIR IS REQUIRED BY TABLE M1507.3.3(1) - PROVIDE 72 SQUARE INCHES OF NET FREE OPENING AREA PER HABITABLE ROOM.

NOTE:  
ALL SHOWERHEAD AND KITCHEN SINK FAUCETS SHALL BE RATED @ 1.75 GPM OR LESS. ALL OTHER LAVATORY FAUCETS SHALL BE RATED @ 1.0 GPM OR LESS.  
CONTRACTOR TO KEEP PRODUCT LITERATURE ON SITE.

LIMITING DEVICE FOR TUBS TO PROVIDE MAX. 120°F HOT WATER TEMPERATURE.

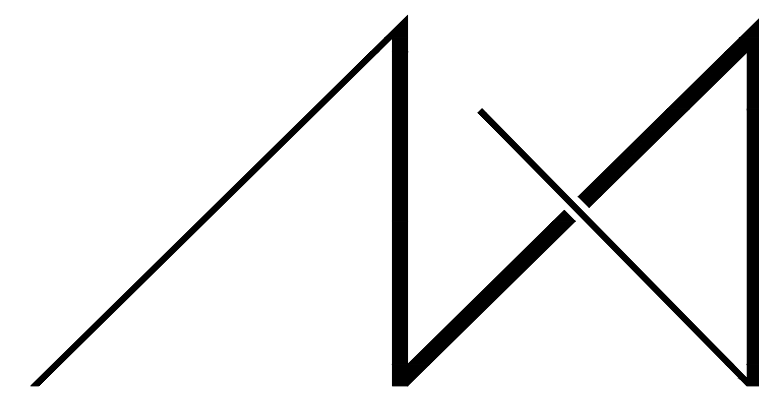

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PROJECT / CLIENT:

**9820 SE 35TH PLACE**

ACHIN & MARY CHEN  
9820 SE 35TH PLACE  
MERCER ISLAND, WA 98040

JOB ADDRESS:

9820 SE 35TH PLACE  
MERCER ISLAND, WA 98040  
PARCEL # 082405-9027

DRAWING NAME:

**1ST FLOOR  
CONSTRUCTION PLAN**

Drawn By: JMG, RB  
Checked By: EB  
Owner Approval:

PHASE:

**CONSTRUCTION DOCUMENTS**

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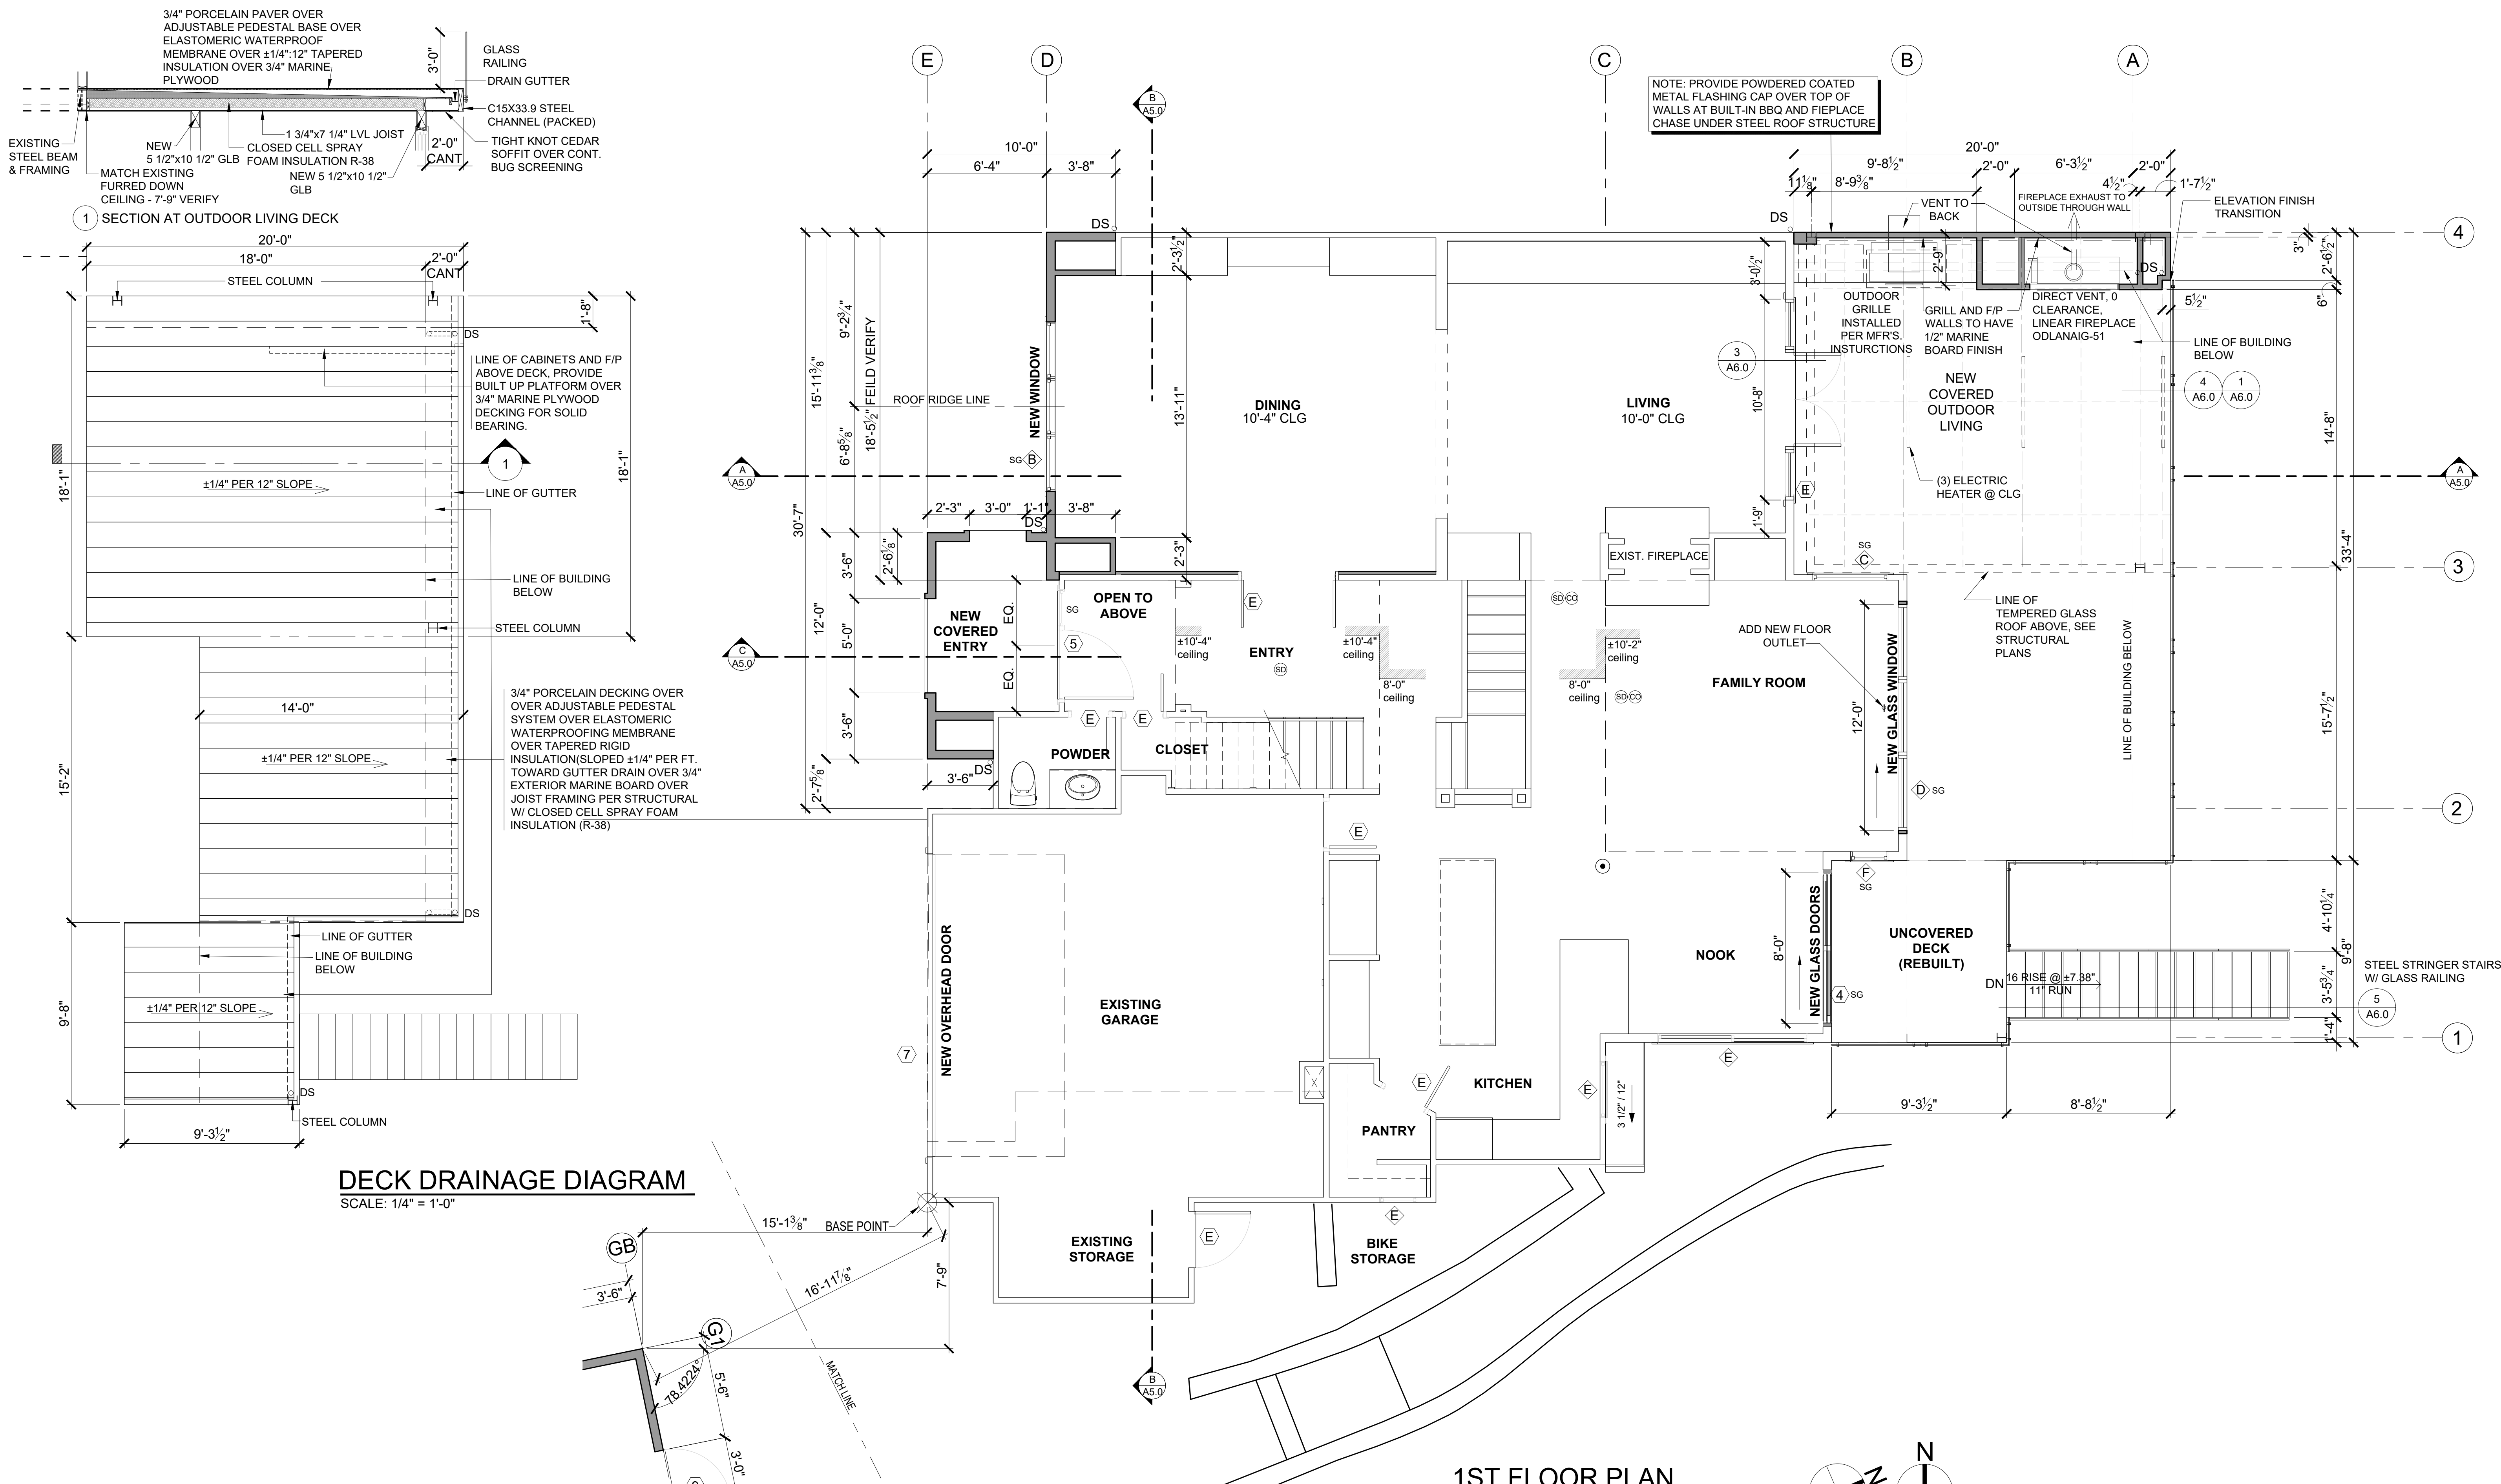
APPROVED FOR CONSTRUCTION:

PROJECT No.: 2020 007

DATE: 12-22-2020

PLOT SCALE: 1:1

A2.1



**SYMBOL LEGEND**

- SMOKE DETECTOR
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- POST - VERIFY SIZE AND TYPE WITH STRUCTURAL PLAN

**HOUSE VENTILATION**


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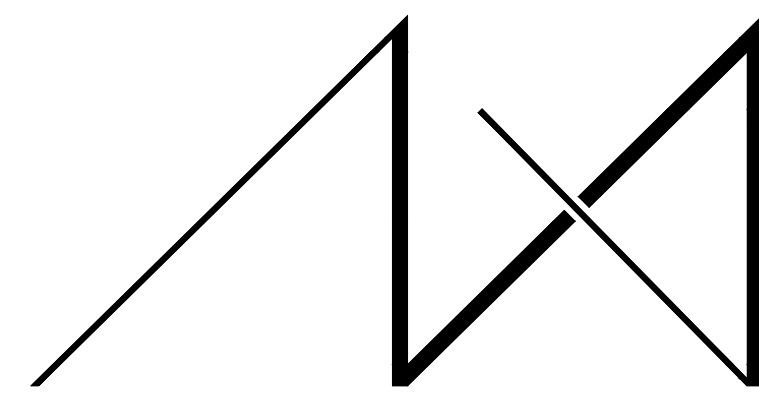
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CONTRACTOR TO KEEP PRODUCT LITERATURE ON SITE.

LIMITING DEVICE FOR TUBS TO PROVIDE MAX. 120°F HOT WATER TEMPERATURE.

**DECK DRAINAGE DIAGRAM**

SCALE: 1/4" = 1'-0"



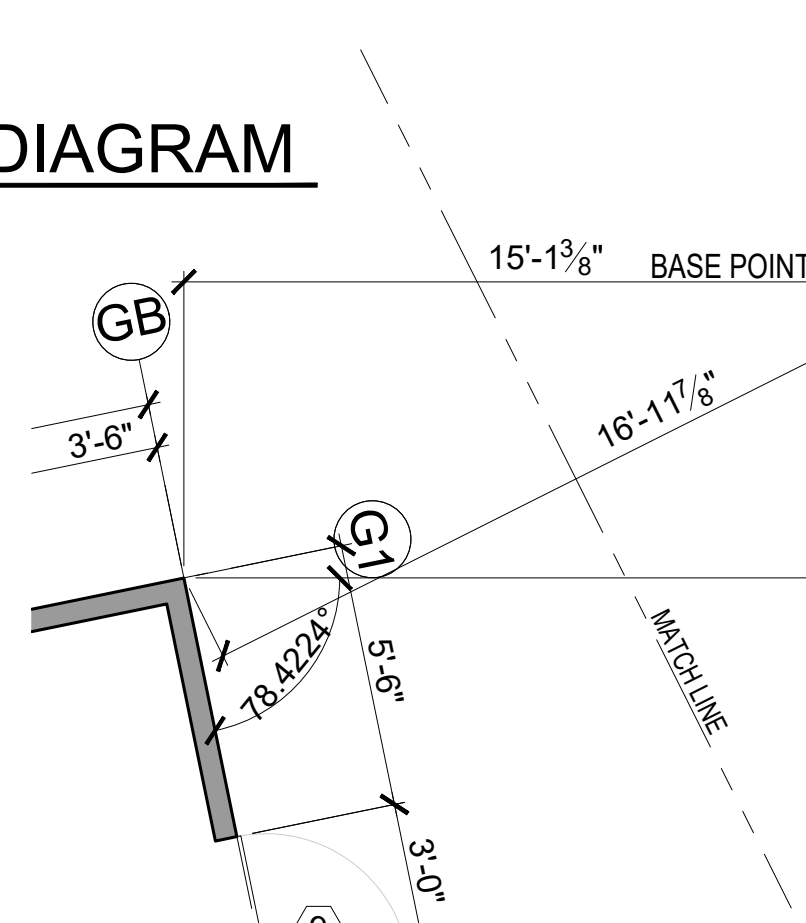

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JOB ADDRESS:

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MERCER ISLAND, WA 98040  
**PARCEL # 082405-9027**

DRAWING NAME:

**2ND FLOOR  
CONSTRUCTION PLAN**

Drawn By: JMG, RB  
Checked By: EB  
Owner Approval:

PHASE:

**CONSTRUCTION DOCUMENTS**

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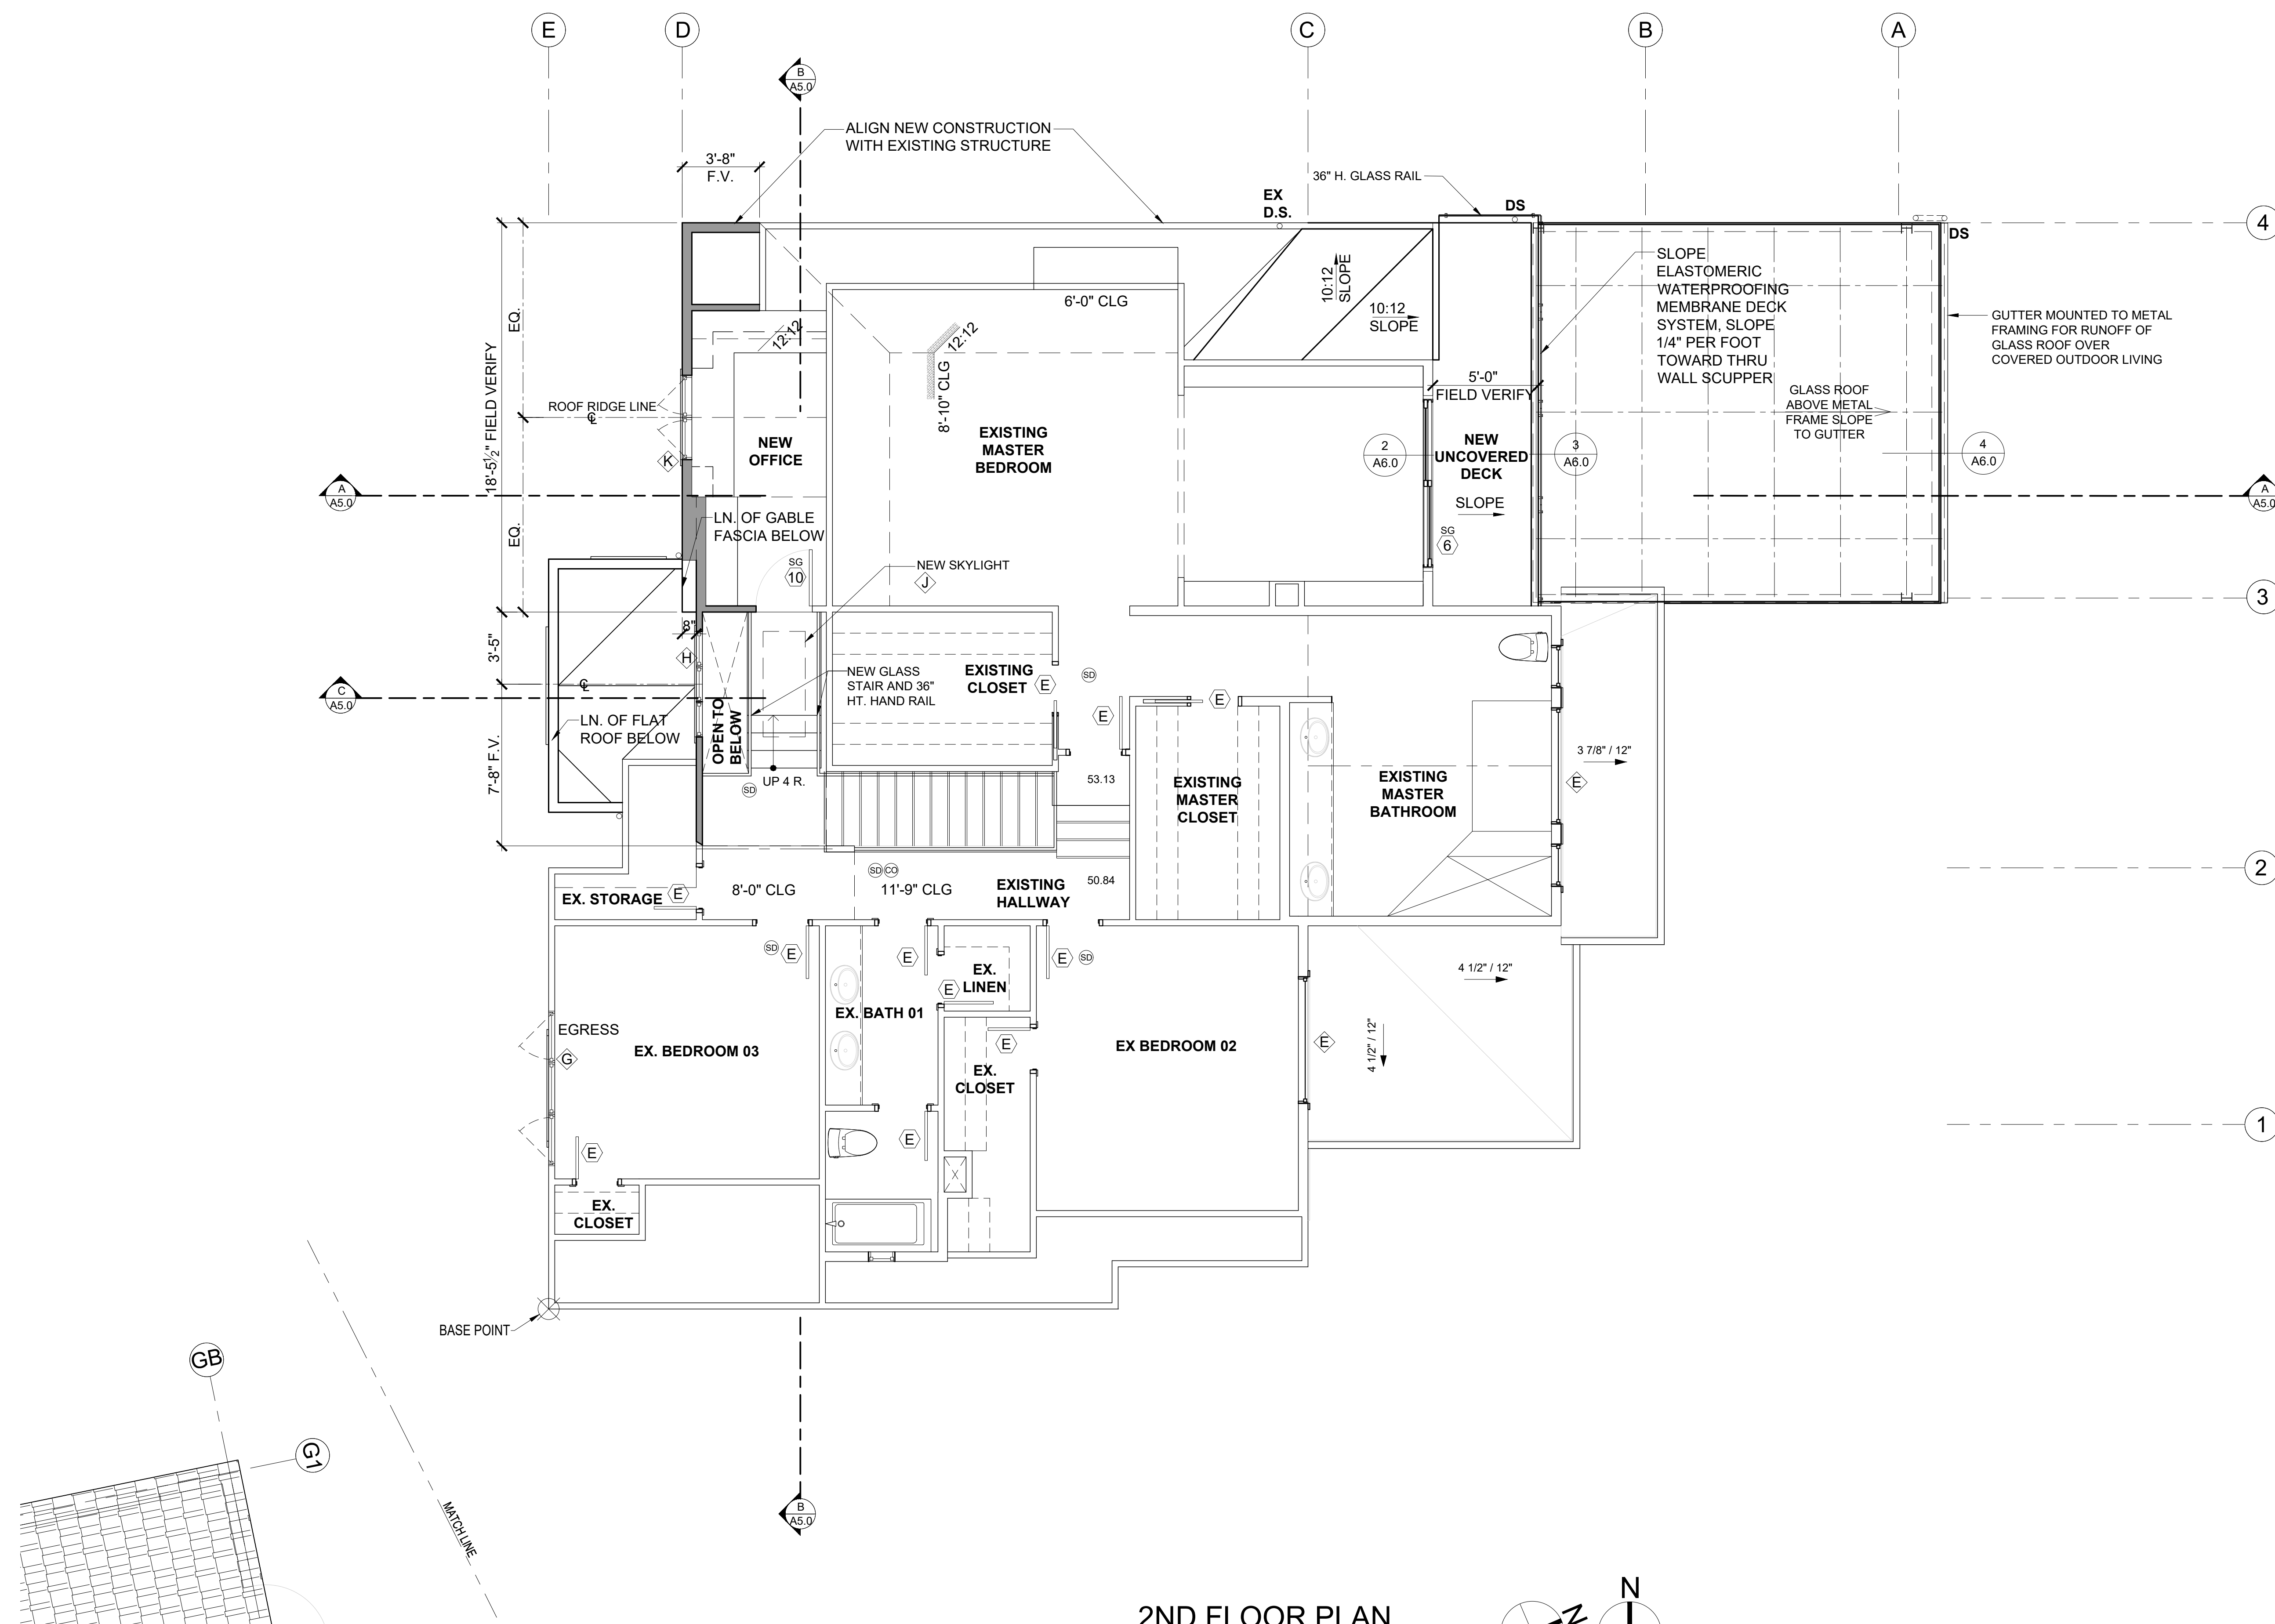
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DATE: 12-22-2020

PLOT SCALE: 1:1

**A2.2**



**2ND FLOOR PLAN**


SCALE: 1/4" = 1'-0"

**FLOOR PLAN NOTES**

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- PROVIDE FIRE BLOCKING @ ALL PLUMBING PENETRATIONS.
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- DOOR JAMB 4 5/8" U.N.O.
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**SYMBOL LEGEND**

- SD SMOKE DETECTOR
- CO CARBON MONOXIDE DETECTOR
- D DOORS
- C WINDOWS
- EXIST. FOUNDATION WALL
- SLAB ON GRADE
- NEW FOUNDATION WALL W/ FOOTING
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- BRICK WALLS
- POST - VERIFY SIZE AND TYPE WITH STRUCTURAL PLAN

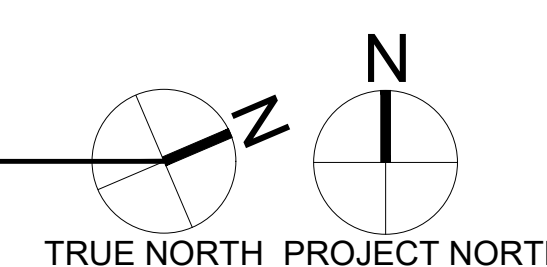


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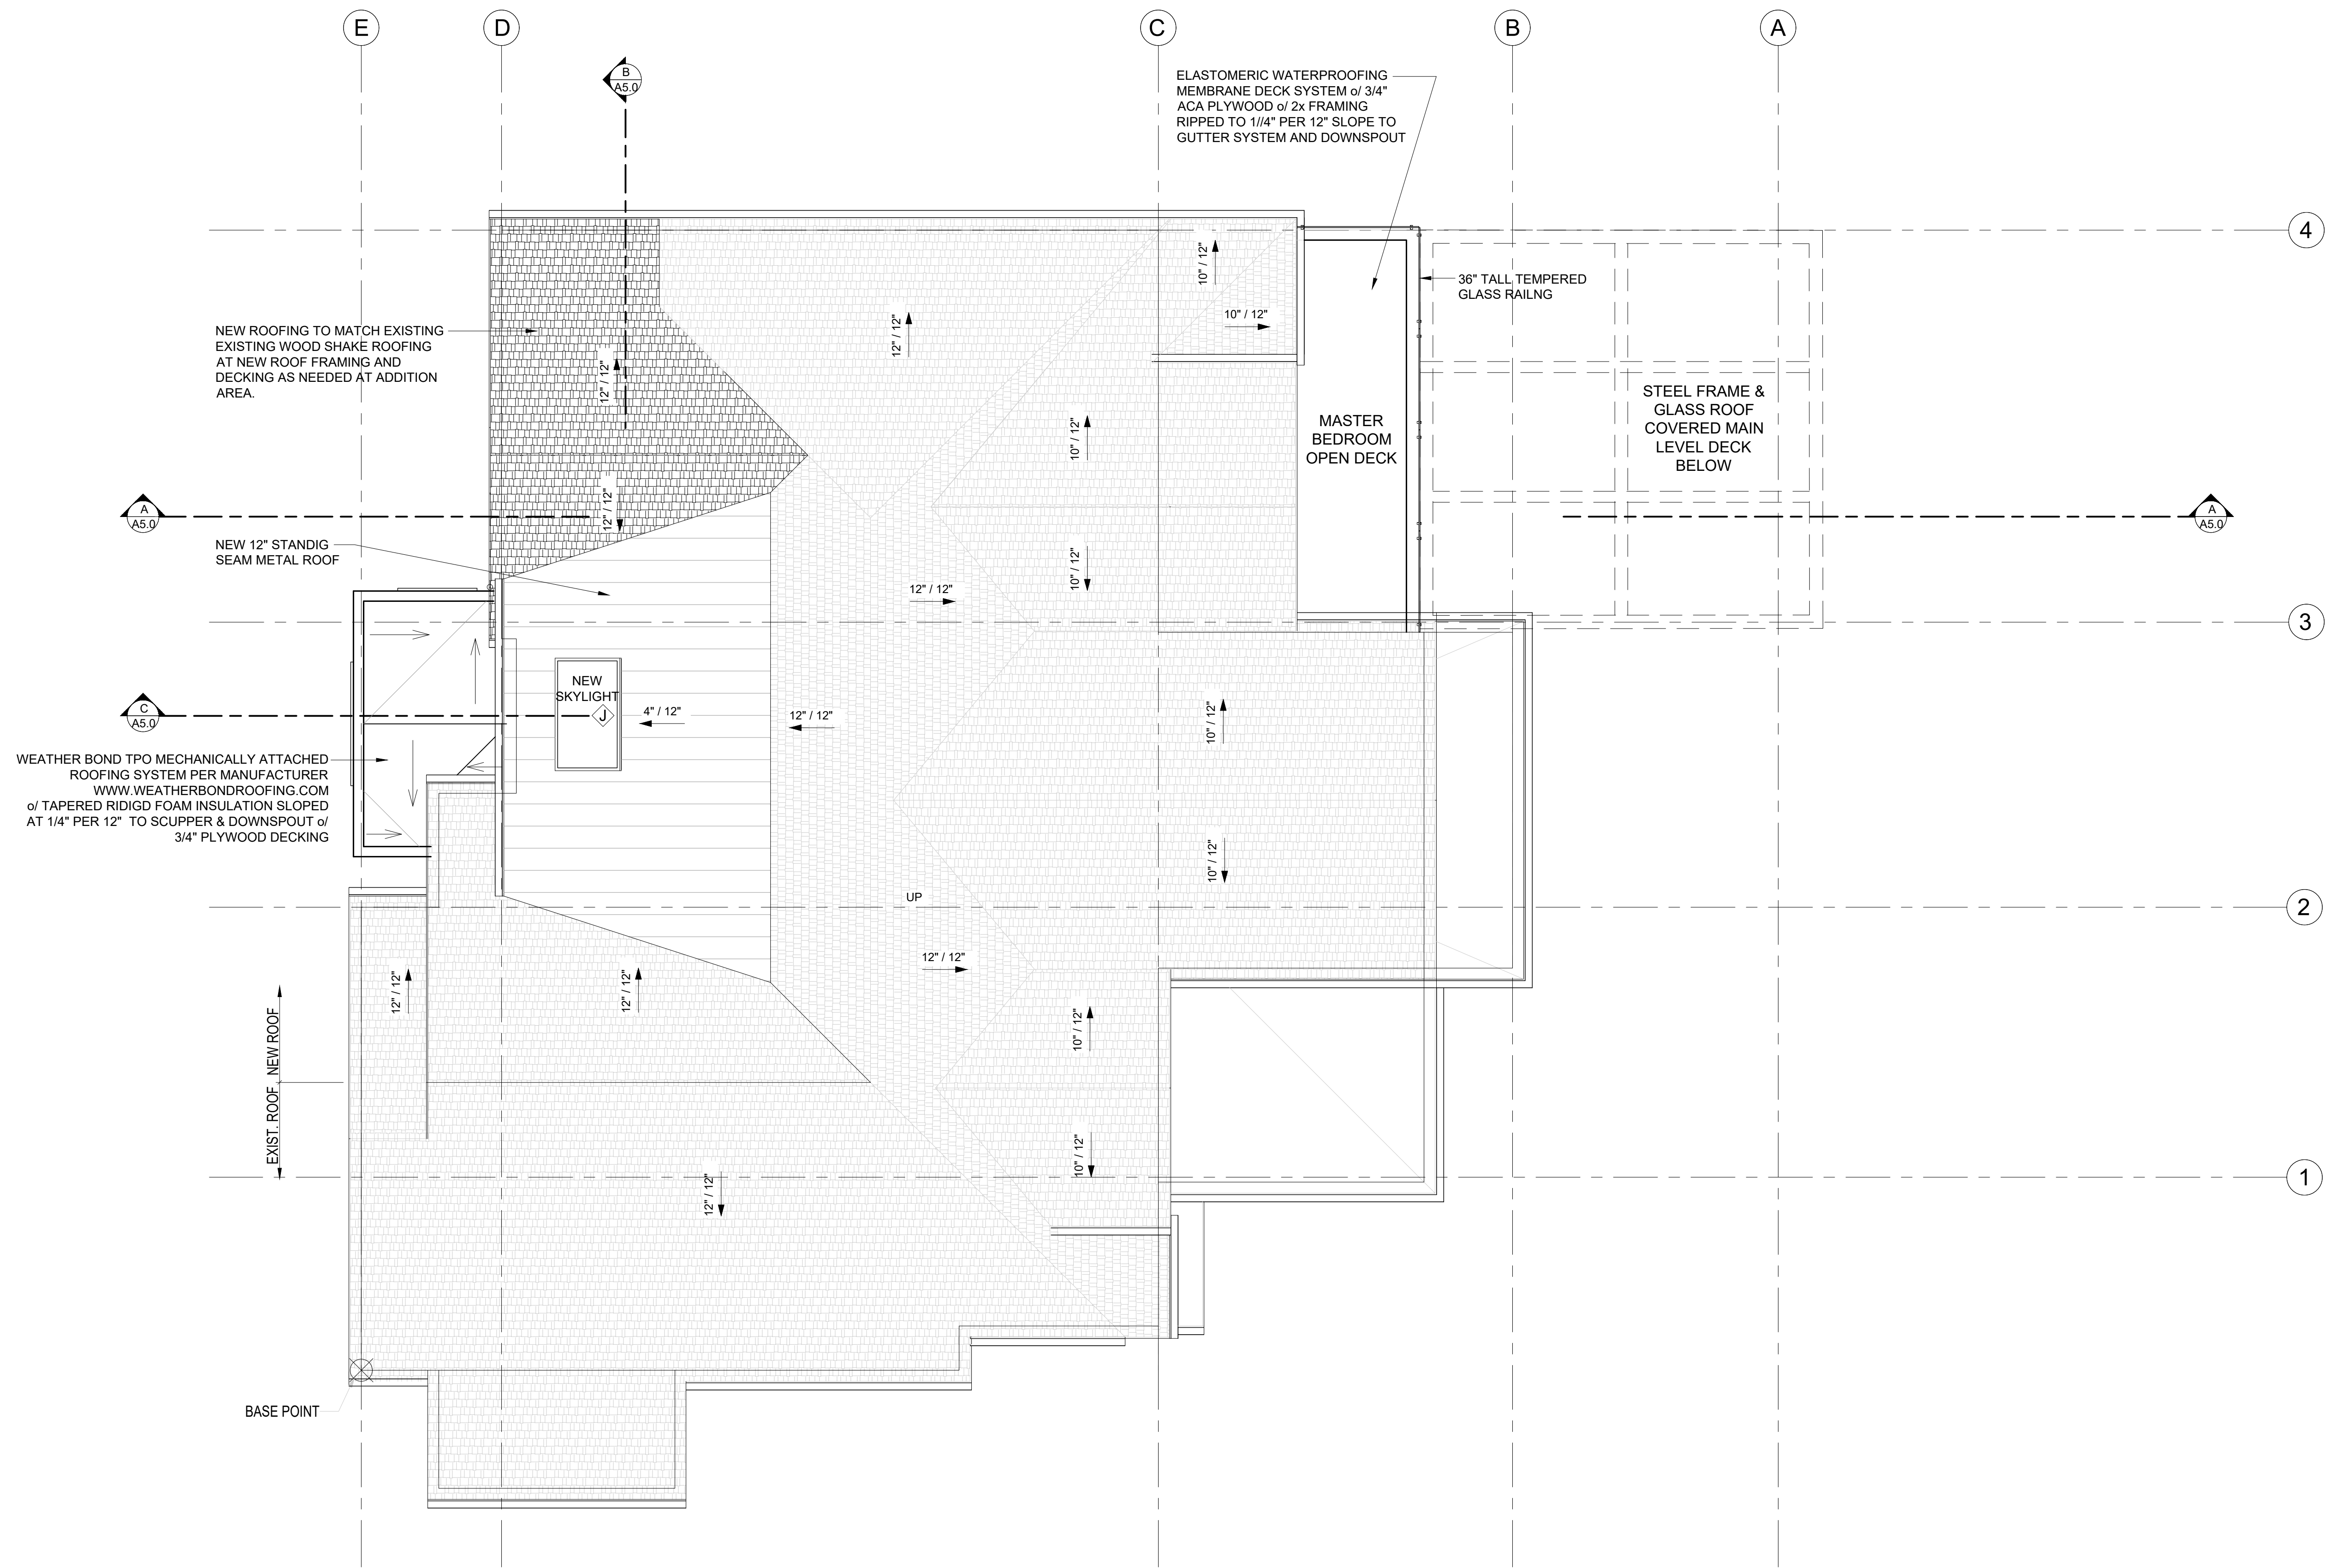
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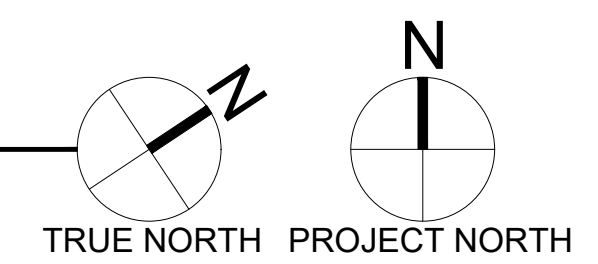
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JOB ADDRESS:

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MERCER ISLAND, WA 98040  
**PARCEL # 082405-9027**



**ROOF PLAN**  
SCALE: 1/4" = 1'-0"

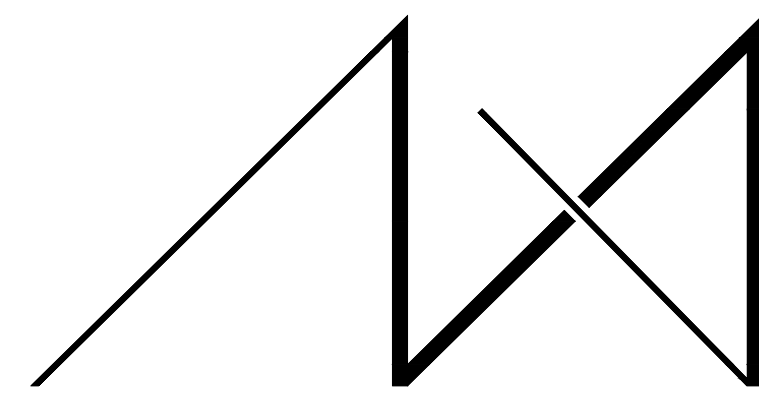

ROOF - VENTILATION CALCULATION				
Stick built Roof Construction:				
Roof Area:	356.7	s.f.		
Ventilation Required:	356.7	s.f. x 144 s.i. / 300"=	171.2	s.i. Req'd
Proposed Ventilation :				
SmartVent Shingle vent (upper or ridge)	4.5	s.i. nfa / l.f.=	4.5	s.i. / l.f.
Provide :	20.0	l.f. Upper Ventilation =	90.0	s.i.
SmartVent Shingle vent (lower roof edge)	4.5	s.i. nfa / l.f. =	4.5	s.i.
Provide:	20.0	l.f. Eave Edge Ventilation =	90.0	s.i.
Total Ventilation Provided	180.0	s.i. IS GREATER THAN	171.2	s.i. Req'd

DRAWING NAME:

**ROOF PLAN**

Drawn By: JMG, RB  
Checked By: EB  
Owner Approval:

PHASE:

**CONSTRUCTION DOCUMENTS**


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**A3.0**



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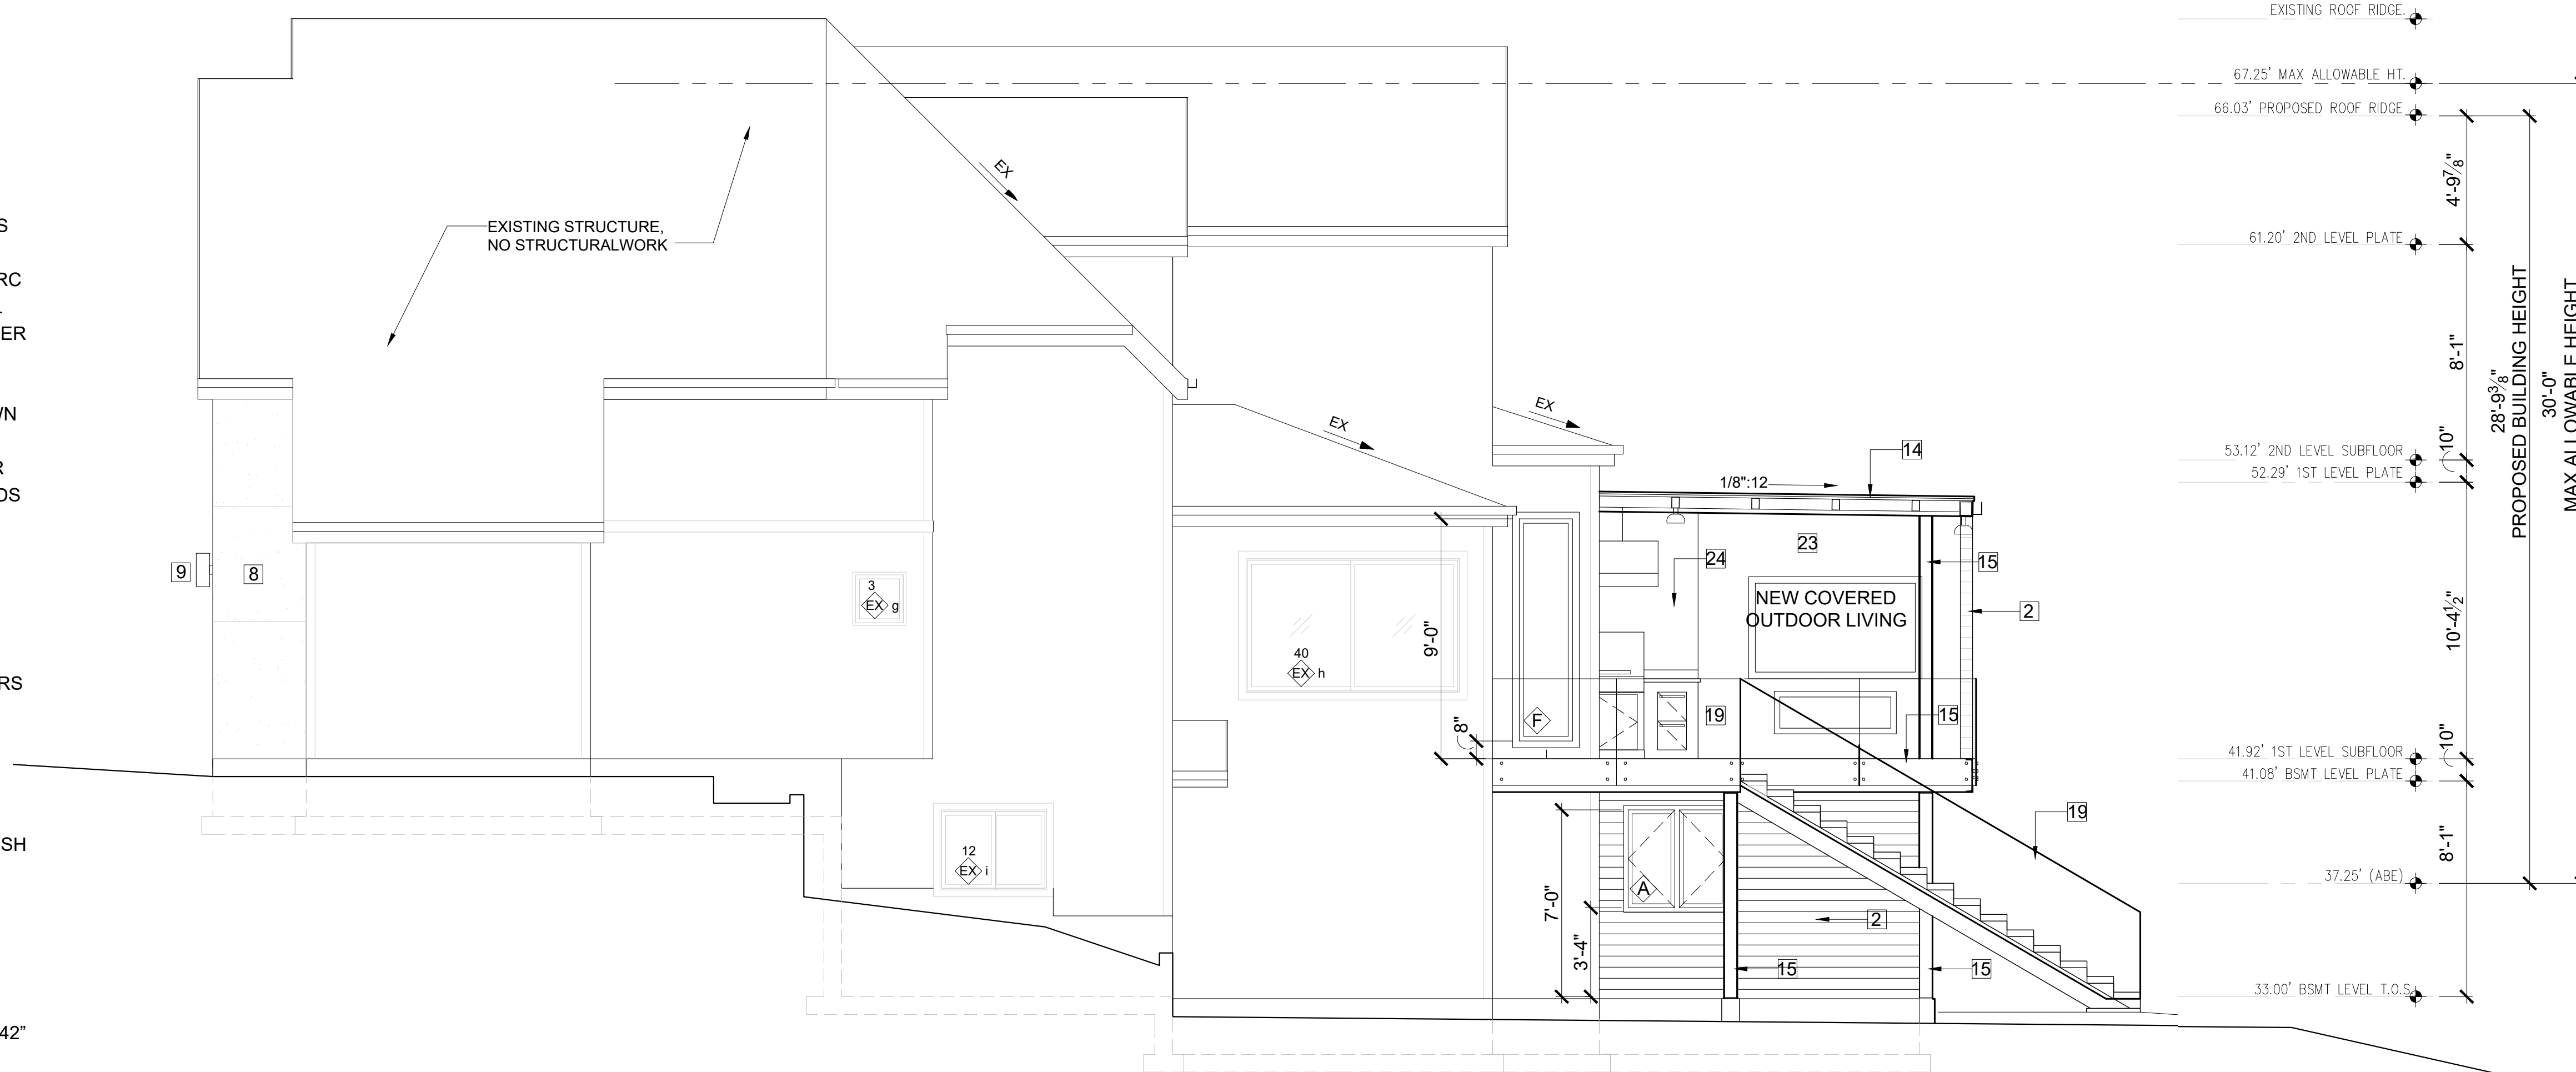
### ELEVATIONS NOTES & KEY NOTES:

- VERIFY SHEAR WALL NAILING & HOLDDOWNS PER STRUCTURAL PLAN & SCHEDULE PRIOR TO INSTALLING SIDING.
- MATCH EXISTING CEDAR SIDING PROFILE AND EXPOSURE, PAINT TO MATCH. INTERWEAVE NEW CEDAR SIDING TO OLD AND EXTEND VAPOR BARRIER MINIMUM OF 6 INCHES. TRANSITIONS TO BE SEAMLESS.
- CAULK ALL EXTERIOR JOINTS & PENETRATIONS.
- AT NEW AND REMODELED CONSTRUCTION AREAS PROVIDE APPROVED CORROSION RESISTANT FLASHING AT EXTERIOR WALL ENVELOPE PER I.R.C. R703.4.
- AT NEW AND REMODELED CONSTRUCTION AREAS PROVIDE FLASHING AT ROOF PENETRATIONS PER I.R.C. R903.2 & R903.2.1.
- AT NEW AND REMODELED CONSTRUCTION AREAS PROVIDE PRE FINISHED CONTINUOUS ALUMINUM GUTTERS, SCUPPER AND DOWN SPOUTS - COLOR TO MATCH ADJACENT EXTERIOR MATERIAL FINISH. ROOF DRAINS AND SCUPPERS SHALL BE INSTALLED PER IRC SECTION R903.4. PROVIDE EMERGENCY OVERFLOW PER IRC SECTION 1503.4.1. TYPICAL SEE ROOF PLAN SHEET A3.0. DIRECT CONNECT FOOTING DRAINS AND DOWN SPOUTS PER CIVIL DRAWINGS.
- SEE SHEET A0.1 FOR ADDITIONAL NOTES.
- STUCCO VENEER: 3-COAT PORTLAND CEMENT STUCCO SHALL HAVE A SCRATCH, BROWN AND FINISH COATS OF PORTLAND CEMENT EXTERIOR PLASTER PER IRC SECTION R703.6.2. SAND FINISH COAT WITH INTEGRAL COLOR, OVER EXTERIOR METAL LATH PER IRC SECTION R703.6.1. TOTAL THICKNESS APPROXIMATELY 7/8". PROVIDE WEEP SCREEDS PER IRC SECTION R703.6.2.1
- LIGHTING AT EXTERIOR DOORS, TYP.
- POWDER COATED COPING
- TPO ROOFING: MECHANICALLY ATTACHED ROOFING SYSTEM, LIGHT GREY. SCRIM-REINFORCED THERMOPLASTIC POLYOLEFIN (TPO) MEMBRANE. PERIMETER SHEETS ARE INSTALLED ALONG THE BUILDING EDGES AND FIELD MEMBRANE SHEETS ARE MECHANICALLY ATTACHED TO THE ROOF DECK WITH THE APPROPRIATE FASTENERS AND FASTENING PLATES. ADJOINING SHEETS OF MEMBRANE ARE OVERLAPPED AND JOINED TOGETHER WITH A MINIMUM 1-1/2" WIDE HOT AIR WELD. INSTALL PER MANUFACTURER.
- MATCH EXISTING SHAKE ROOF AND FINISH TO MATCH, INSTALL PER INDUSTRY STANDARDS.
- 12" STANDING SEAM METAL ROOFING, INSTALL PER INDUSTRY STANDARDS. COLOR FINISH TO BE SELECTED BY OWNER.
- POWDER COATED STEEL FRAME FOR INSTALLATION OF TEMPERED LAMINATED GLASS ROOF CANOPY, INSTALL BY ROOF CANOPY MANUFACTURER.
- POWDER COATED STEEL COLUMN OR C-CHANNEL PER STRUCTURAL.
- FIRE PLACE VENT
- HOOD VENT OVER BARBEQUE.
- FRONT ENTRY DOOR: FRONT ENTRY DOOR SHALL BE ALUMINUM, MINIMUM 1-3/4" THICK, 42" WIDE SINGLE SOLID DOOR WITH ONE SIDELIGHT AND TRANSOM WINDOW ABOVE. DOUBLE-GLAZED SAFETY GLASS, WITH LOW-E. PROVIDE ANODIZED METAL THRESHOLD, CYLINDER ENTRY LOCK ACCESS AND DEADBOLT DRILLING. U-VALUE OF DOORS TO BE 0.30 (2015 WSEC) OR BETTER. PROVIDE EUTHERM ALUMINUM DOOR OR EQUAL AS APPROVED BY ARCHITECT.
- GLASS RAILING HANDRAIL: SIDE MOUNTED FRAMELESS GLASS RAIL SYSTEM WITH NON-GLARE TEMPERED GLASS PANELS.
- WINDOWS: (CLIMATE ZONE 4C OF THE 2015 WSEC TABLE R402.1.1) ALL WINDOWS SHALL BE DOUBLE-PANED MINIMUM PERFORMANCE AND CONSTRUCTION TO CONFORM WITH IRC SECTION R612. HARDWARE FINISH SHALL MATCH DOOR HARDWARE. ALL CASEMENT OPENINGS SHALL HAVE ROTO HARDWARE. ALL OPENINGS WEATHER-STRIPPED BY MANUFACTURER; GENERAL CONTRACTOR SHALL INSTALL "Z"-FLASHING AT HEADS OF ALL WINDOWS AND SEAL WINDOW PERIMETER PER MANUFACTURER'S SPECIFICATIONS.
- PORCELAIN PAVERS DECK SYSTEM INSTALL PER POCELANOSA MANUFACTURER INSTRUCTIONS.
- WOOD DECKING OVER RIPPED CEDAR DECK JOIST OVER 3/4" MARINE BOARD WATER MEMBRANE ROOFING PER IRC. R905.13 AND CLOSED CELL SPAY FOAM R-38.
- STONE TILE VENEER.
- BLACKEN STAINLESS STEEL
- A STEEL, METAL FLASHING AND COPING TO BE POWDER COATED.

NOTE:  
REQUIRED GUARDS SHALL NOT HAVE OPENINGS FROM THE WALKING SURFACE TO THE REQUIRE GUARD HEIGHT WHICH ALLOW PASSAGE OF A SPHERE 4 INCHES IN DIAMETER.

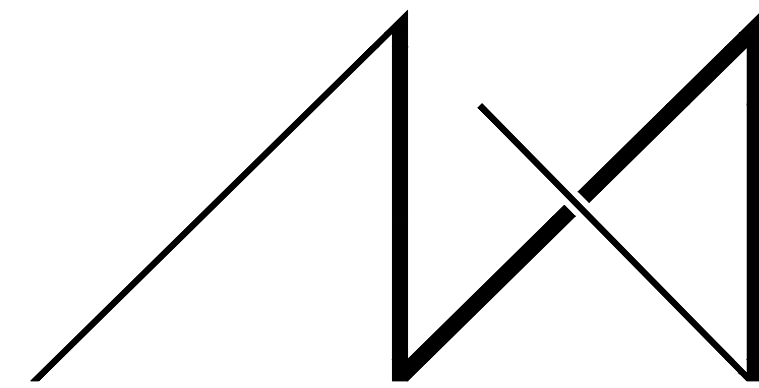
PER IRC - 301.5 CONCENTRATED LOAD. HANDRAILS AND GUARDS SHALL BE ABLE TO RESIST A SINGLE CONCENTRATED LOAD OF 200 POUNDS, APPLIED IN ANY DIRECTION AT ANY POINT ALONG THE TOP, AND TO TRANSFER THIS LOAD THROUGH THE SUPPORTS TO THE STRUCTURE.

R312.2.1 - WINDOW SILLS. IN DWELLING UNITS, WHERE THE OPENING OF AN OPERABLE WINDOW IS LOCATED MORE THAN 7" ABOVE THE FINISHED GRADE OR SURFACE BELOW, THE LOWEST PART OF THE CLEAR OPENING OF THE WINDOW SHALL BE A MINIMUM OF 24" ABOVE THE FINISHED FLOOR OF THE ROOM IN WHICH THE WINDOW IS LOCATED. OPERABLE SECTION OF WINDOWS SHALL NOT PERMIT OPENINGS THAT ALLOW PASSAGE OF A 4" DIAMETER SPHERE WHERE SUCH OPENINGS ARE LOCATED WITHIN 24" OF THE FINISHED FLOOR.



**SOUTH ELEVATION**

SCALE: 1/4" = 1'-0"

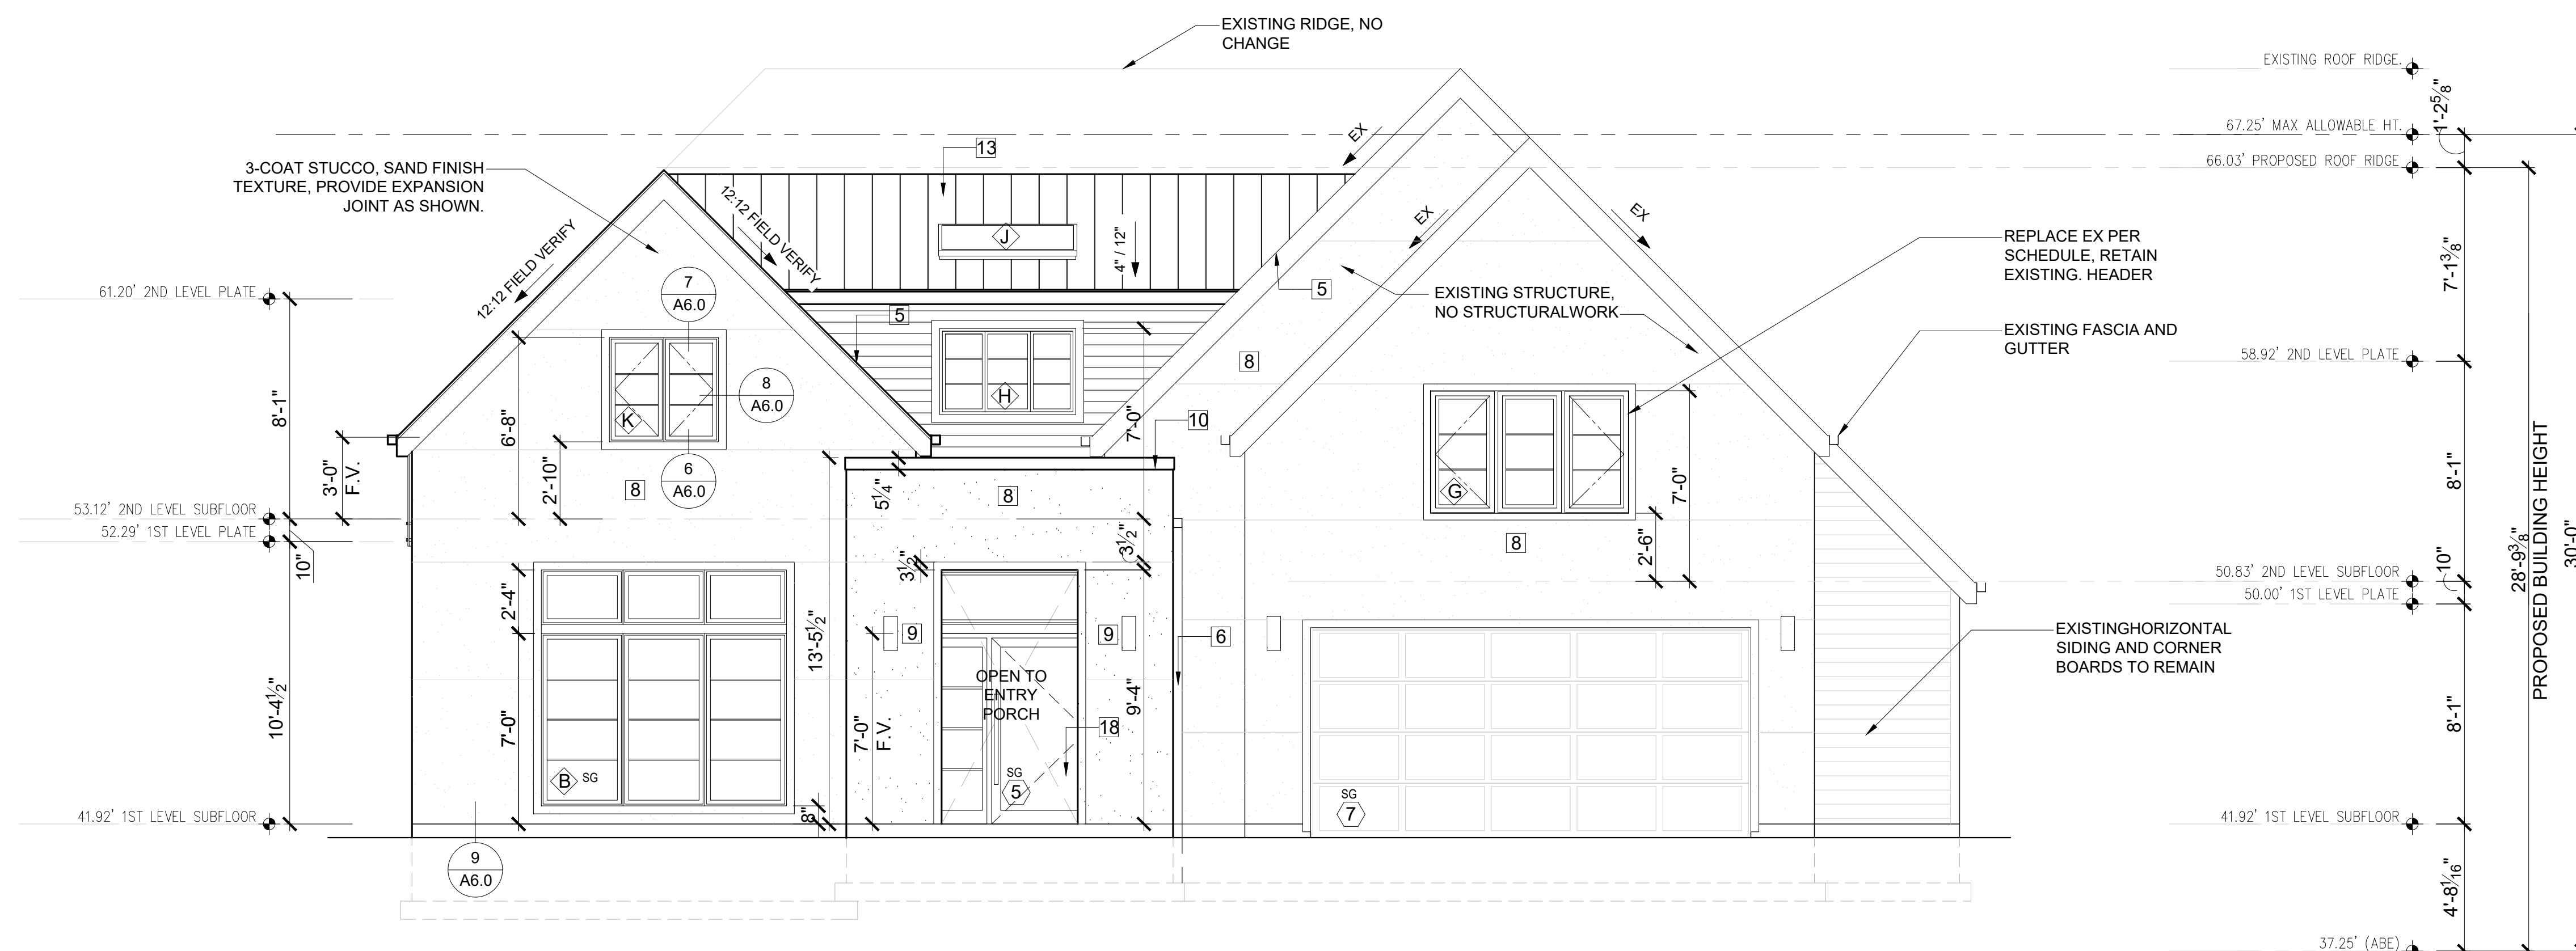

**WEST ELEVATION**

SCALE: 1/4" = 1'-0"

DRAWING NAME:

### ELEVATIONS

Drawn By: JMG, RB

Checked By: EB

Owner Approval:

PHASE:

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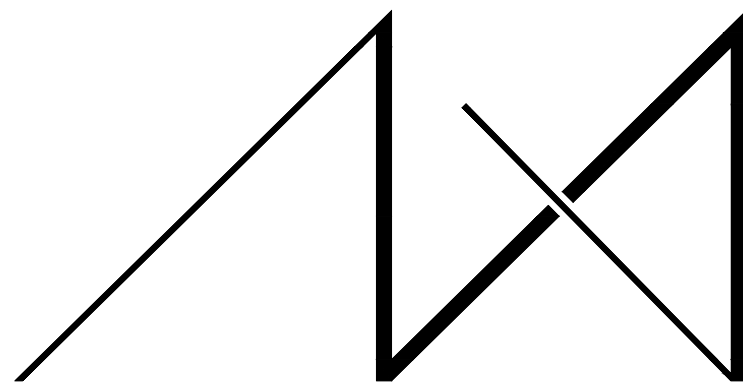
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**A4.0**




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REVISIONS: DATE:

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PROJECT / CLIENT:

**9820 SE 35TH PLACE**

ACHIN & MARY CHEN  
9820 SE 35TH PLACE  
MERCER ISLAND, WA 98040

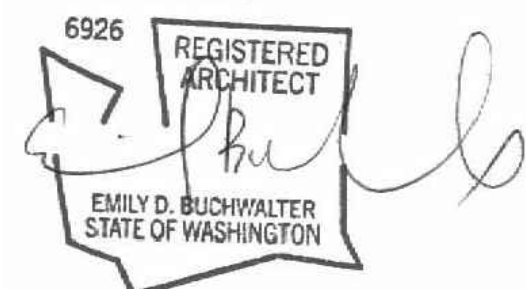JOB ADDRESS:

9820 SE 35TH PLACE  
MERCER ISLAND, WA 98040  
**PARCEL # 082405-9027**

DRAWING NAME:

ELEVATIONS

Drawn By: JMG, RB

Checked By: EB

Owner Approval:

PHASE:

CONSTRUCTION DOCUMENTS

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APPROVED FOR CONSTRUCTION:

PROJECT No.: 2020 007

DATE: 12-22-2020

PLOT SCALE: 1:1

A4.1


### ELEVATIONS NOTES & KEY NOTES:

- VERIFY SHEAR WALL NAILING & HOLDOWNS PER STRUCTURAL PLAN & SCHEDULE PRIOR TO INSTALLING SIDING.
- MATCH EXISTING CEDAR SIDING PROFILE AND EXPOSURE, PAINT TO MATCH. INTERWEAVE NEW CEDAR SIDING TO OLD AND EXTEND VAPOR BARRIER MINIMUM OF 6 INCHES. TRANSITIONS TO BE SEAMLESS.
- CAULK ALL EXTERIOR JOINTS & PENETRATIONS.
- AT NEW AND REMODELED CONSTRUCTION AREAS PROVIDE APPROVED CORROSION RESISTANT FLASHING AT EXTERIOR WALL ENVELOPE PER I.R.C. R703.4.
- AT NEW AND REMODELED CONSTRUCTION AREAS PROVIDE FLASHING AT ROOF PENETRATIONS PER I.R.C. R903.2 & R903.2.1.
- AT NEW AND REMODELED CONSTRUCTION AREAS PROVIDE PRE FINISHED CONTINUOUS ALUMINUM GUTTERS, SCUPPER AND DOWN SPOUTS - COLOR TO MATCH ADJACENT EXTERIOR MATERIAL FINISH. ROOF DRAINS AND SCUPPERS SHALL BE INSTALLED PER IRC SECTION R903.4. PROVIDE EMERGENCY OVERFLOW PER IRC SECTION 1503.4.1. TYPICAL SEE ROOF PLAN SHEET A3.0. DIRECT CONNECT FOOTING DRAINS AND DOWN SPOUTS PER CIVIL DRAWINGS.
- SEE SHEET A0.1 FOR ADDITIONAL NOTES.
- STUCCO VENEER: 3-COAT PORTLAND CEMENT STUCCO SHALL HAVE A SCRATCH, BROWN AND FINISH COATS OF PORTLAND CEMENT EXTERIOR PLASTER PER IRC SECTION R703.6.2. SAND FINISH COAT WITH INTEGRAL COLOR, OVER EXTERIOR METAL LATH PER IRC SECTION R703.6.1. TOTAL THICKNESS APPROXIMATELY 7/8". PROVIDE WEEP SCREEDS PER IRC SECTION R703.6.2.1
- LIGHTING AT EXTERIOR DOORS, TYP.
- POWDER COATED COPING
- TPO ROOFING: MECHANICALLY ATTACHED ROOFING SYSTEM, LIGHT GRAY, SCRIM-REINFORCED THERMOPLASTIC POLYOLEFIN (TPO) MEMBRANE. PERIMETER SHEETS ARE INSTALLED ALONG THE BUILDING EDGES AND FIELD MEMBRANE SHEETS ARE MECHANICALLY ATTACHED TO THE ROOF DECK WITH THE APPROPRIATE FASTENERS AND FASTENING PLATES. ADJOINING SHEETS OF MEMBRANE ARE OVERLAPPED AND JOINED TOGETHER WITH A MINIMUM 1-1/2" WIDE HOT AIR WELD. INSTALL PER MANUFACTURER.
- MATCH EXISTING SHAKE ROOF AND FINISH TO MATCH, INSTALL PER INDUSTRY STANDARDS.
- 12" STANDING SEAM METAL ROOFING, INSTALL PER INDUSTRY STANDARDS. COLOR FINISH TO BE SELECTED BY OWNER.
- POWDER COATED STEEL FRAME FOR INSTALLATION OF TEMPERED LAMINATED GLASS ROOF CANOPY, INSTALL BY ROOF CANOPY MANUFACTURER.
- POWDER COATED STEEL COLUMN OR C-CHANNEL PER STRUCTURAL.
- FIRE PLACE VENT
- HOOD VENT OVER BARBEQUE.
- FRONT ENTRY DOOR: FRONT ENTRY DOOR SHALL BE ALUMINUM, MINIMUM 1-3/4" THICK, 42" WIDE SINGLE SOLID DOOR WITH ONE SIDELIGHT AND TRANSOM WINDOW ABOVE, DOUBLE-GLAZED SAFETY GLASS, WITH LOW-E. PROVIDE ANODIZED METAL THRESHOLD, CYLINDER ENTRY LOCK ACCESS AND DEADBOLT DRILLING. U-VALUE OF DOORS TO BE 0.30 (2015 WSEC) OR BETTER. PROVIDE EUTHERM ALUMINUM DOOR OR EQUAL AS APPROVED BY ARCHITECT.
- GLASS RAILING HANDRAIL: SIDE MOUNTED FRAMELESS GLASS RAIL SYSTEM WITH NON-GLARE TEMPERED GLASS PANELS.
- WINDOWS: (CLIMATE ZONE 4C OF THE 2015 WSEC TABLE R402.1.1) ALL WINDOWS SHALL BE DOUBLE-PANED MINIMUM, PERFORMANCE AND CONSTRUCTION TO CONFORM WITH IRC SECTION R612. HARDWARE FINISH SHALL MATCH DOOR HARDWARE. ALL CASEMENT OPENINGS SHALL HAVE ROTO HARDWARE. ALL OPENINGS WEATHER-STRIPPED BY MANUFACTURER; GENERAL CONTRACTOR SHALL INSTALL "Z"-FLASHING AT HEADS OF ALL WINDOWS AND SEAL WINDOW PERIMETER PER MANUFACTURER'S SPECIFICATIONS.
- PORCELAIN PAVERS DECK SYSTEM INSTALL PER PORCELANOSA MANUFACTURER INSTRUCTIONS.
- WOOD DECKING OVER RIPPED CEDAR DECK JOIST OVER 3/4" MARINE BOARD WATER MEMBRANE ROOFING PER IRC. R905.13 AND CLOSED CELL SPAY FOAM R-38.
- STONE TILE VENEER.
- BLACKEN STAINLESS STEEL


NOTE:  
REQUIRED GUARDS SHALL NOT HAVE OPENINGS FROM THE WALKING SURFACE TO THE REQUIRE GUARD HEIGHT WHICH ALLOW PASSAGE OF A SPHERE 4 INCHES IN DIAMETER.

PER IRC - 301.5 CONCENTRATED LOAD, HANDRAILS AND GUARDS SHALL BE ABLE TO RESIST A SINGLE CONCENTRATED LOAD OF 200 POUNDS, APPLIED IN ANY DIRECTION AT ANY POINT ALONG THE TOP, AND TO TRANSFER THIS LOAD THROUGH THE SUPPORTS TO THE STRUCTURE.

R312.2.1 - WINDOW SILLS. IN DWELLING UNITS, WHERE THE OPENING OF AN OPERABLE WINDOW IS LOCATED MORE THAN 72" ABOVE THE FINISHED GRADE OR SURFACE BELOW, THE LOWEST PART OF THE CLEAR OPENING OF THE WINDOW SHALL BE A MINIMUM OF 24" ABOVE THE FINISHED FLOOR OF THE ROOM IN WHICH THE WINDOW IS LOCATED. OPERABLE SECTION OF WINDOWS SHALL NOT PERMIT OPENINGS THAT ALLOW PASSAGE OF A 4" DIAMETER SPHERE WHERE SUCH OPENINGS ARE LOCATED WITHIN 24" OF THE FINISHED FLOOR.

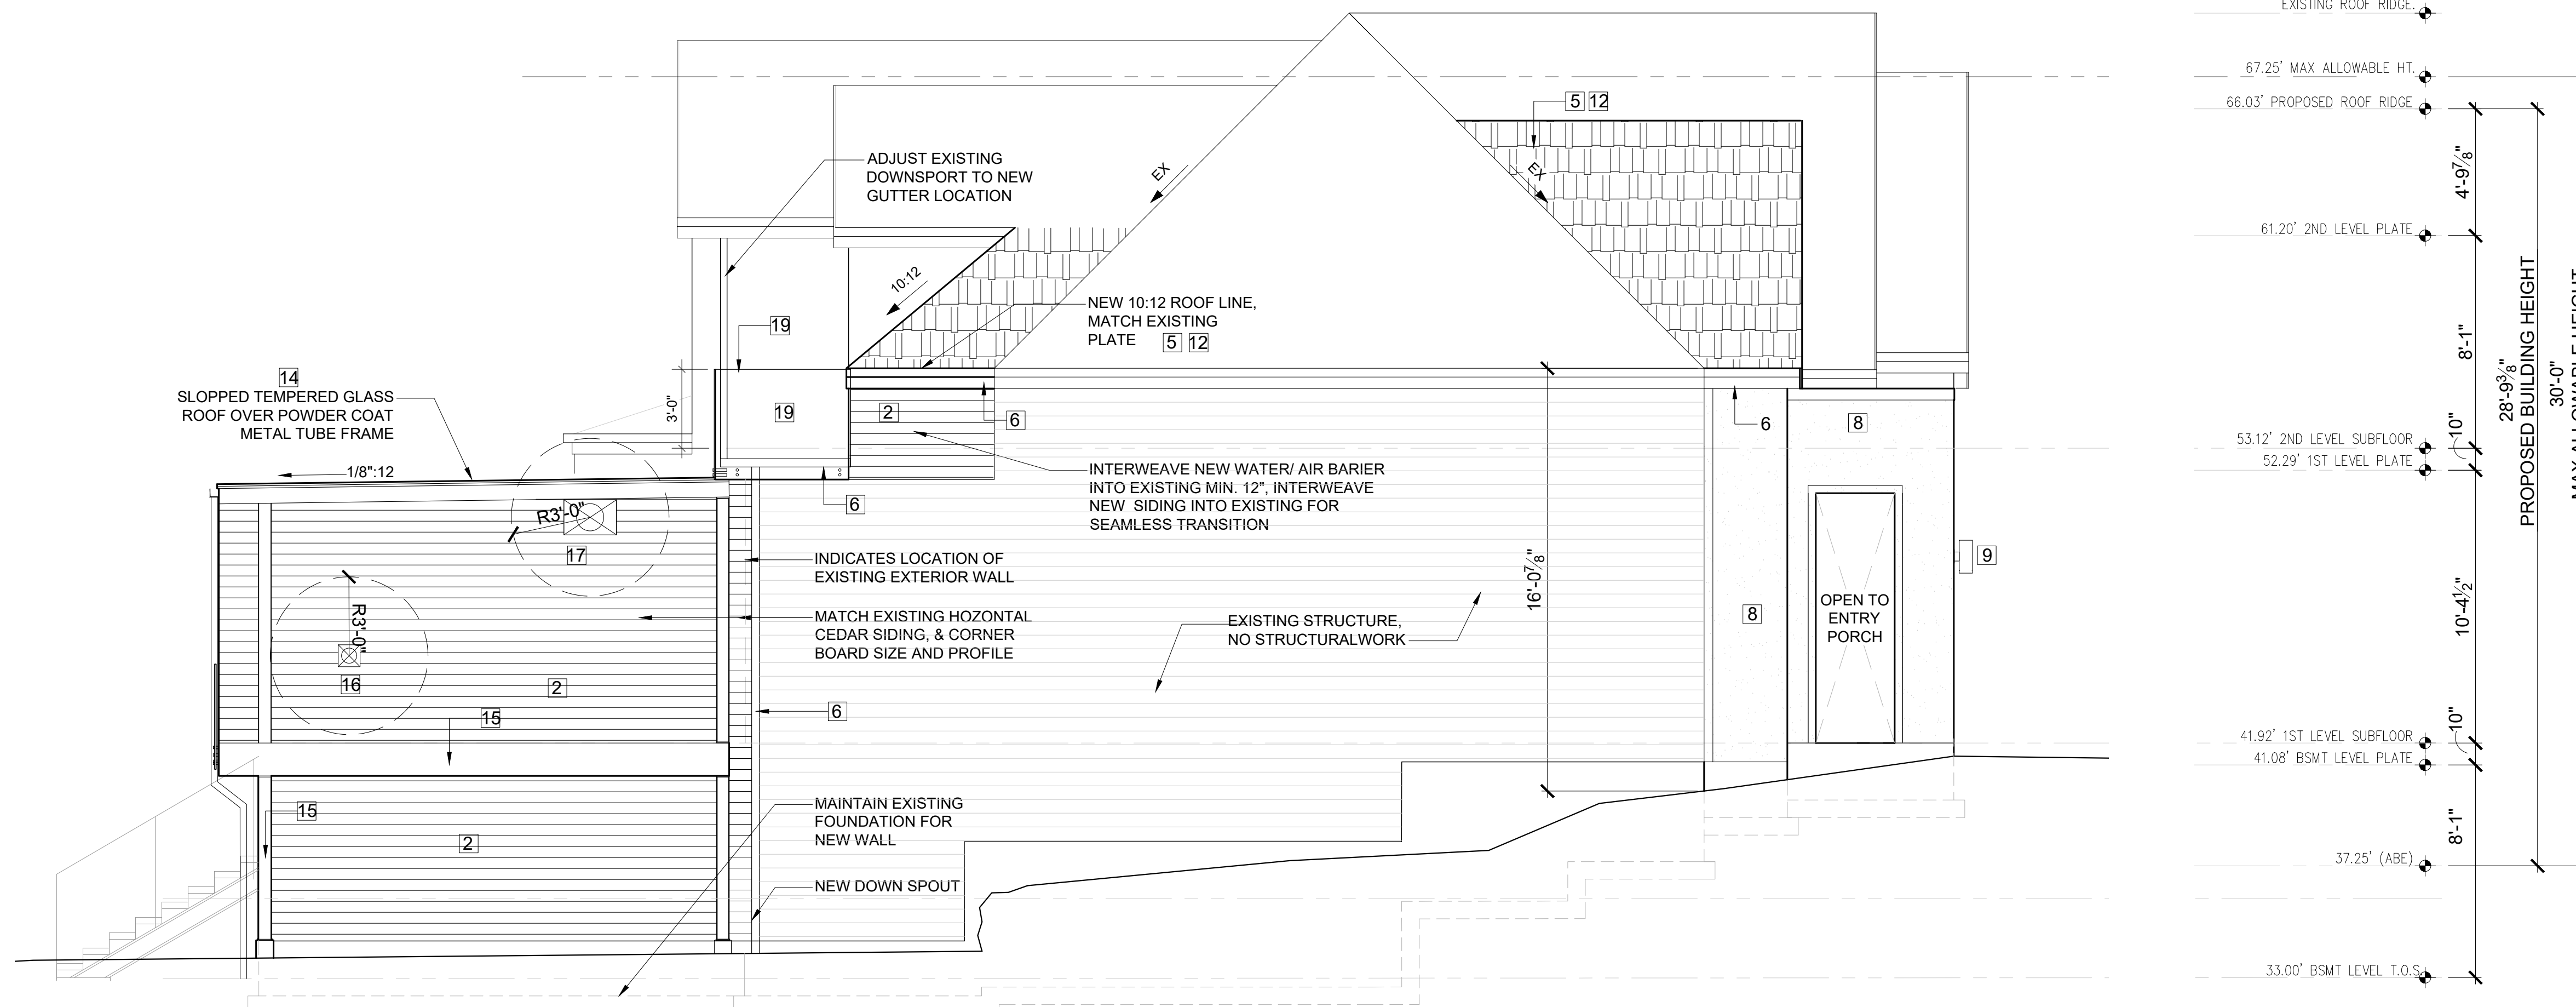


**NORTH ELEVATION**  
SCALE: 1/4" = 1'-0"

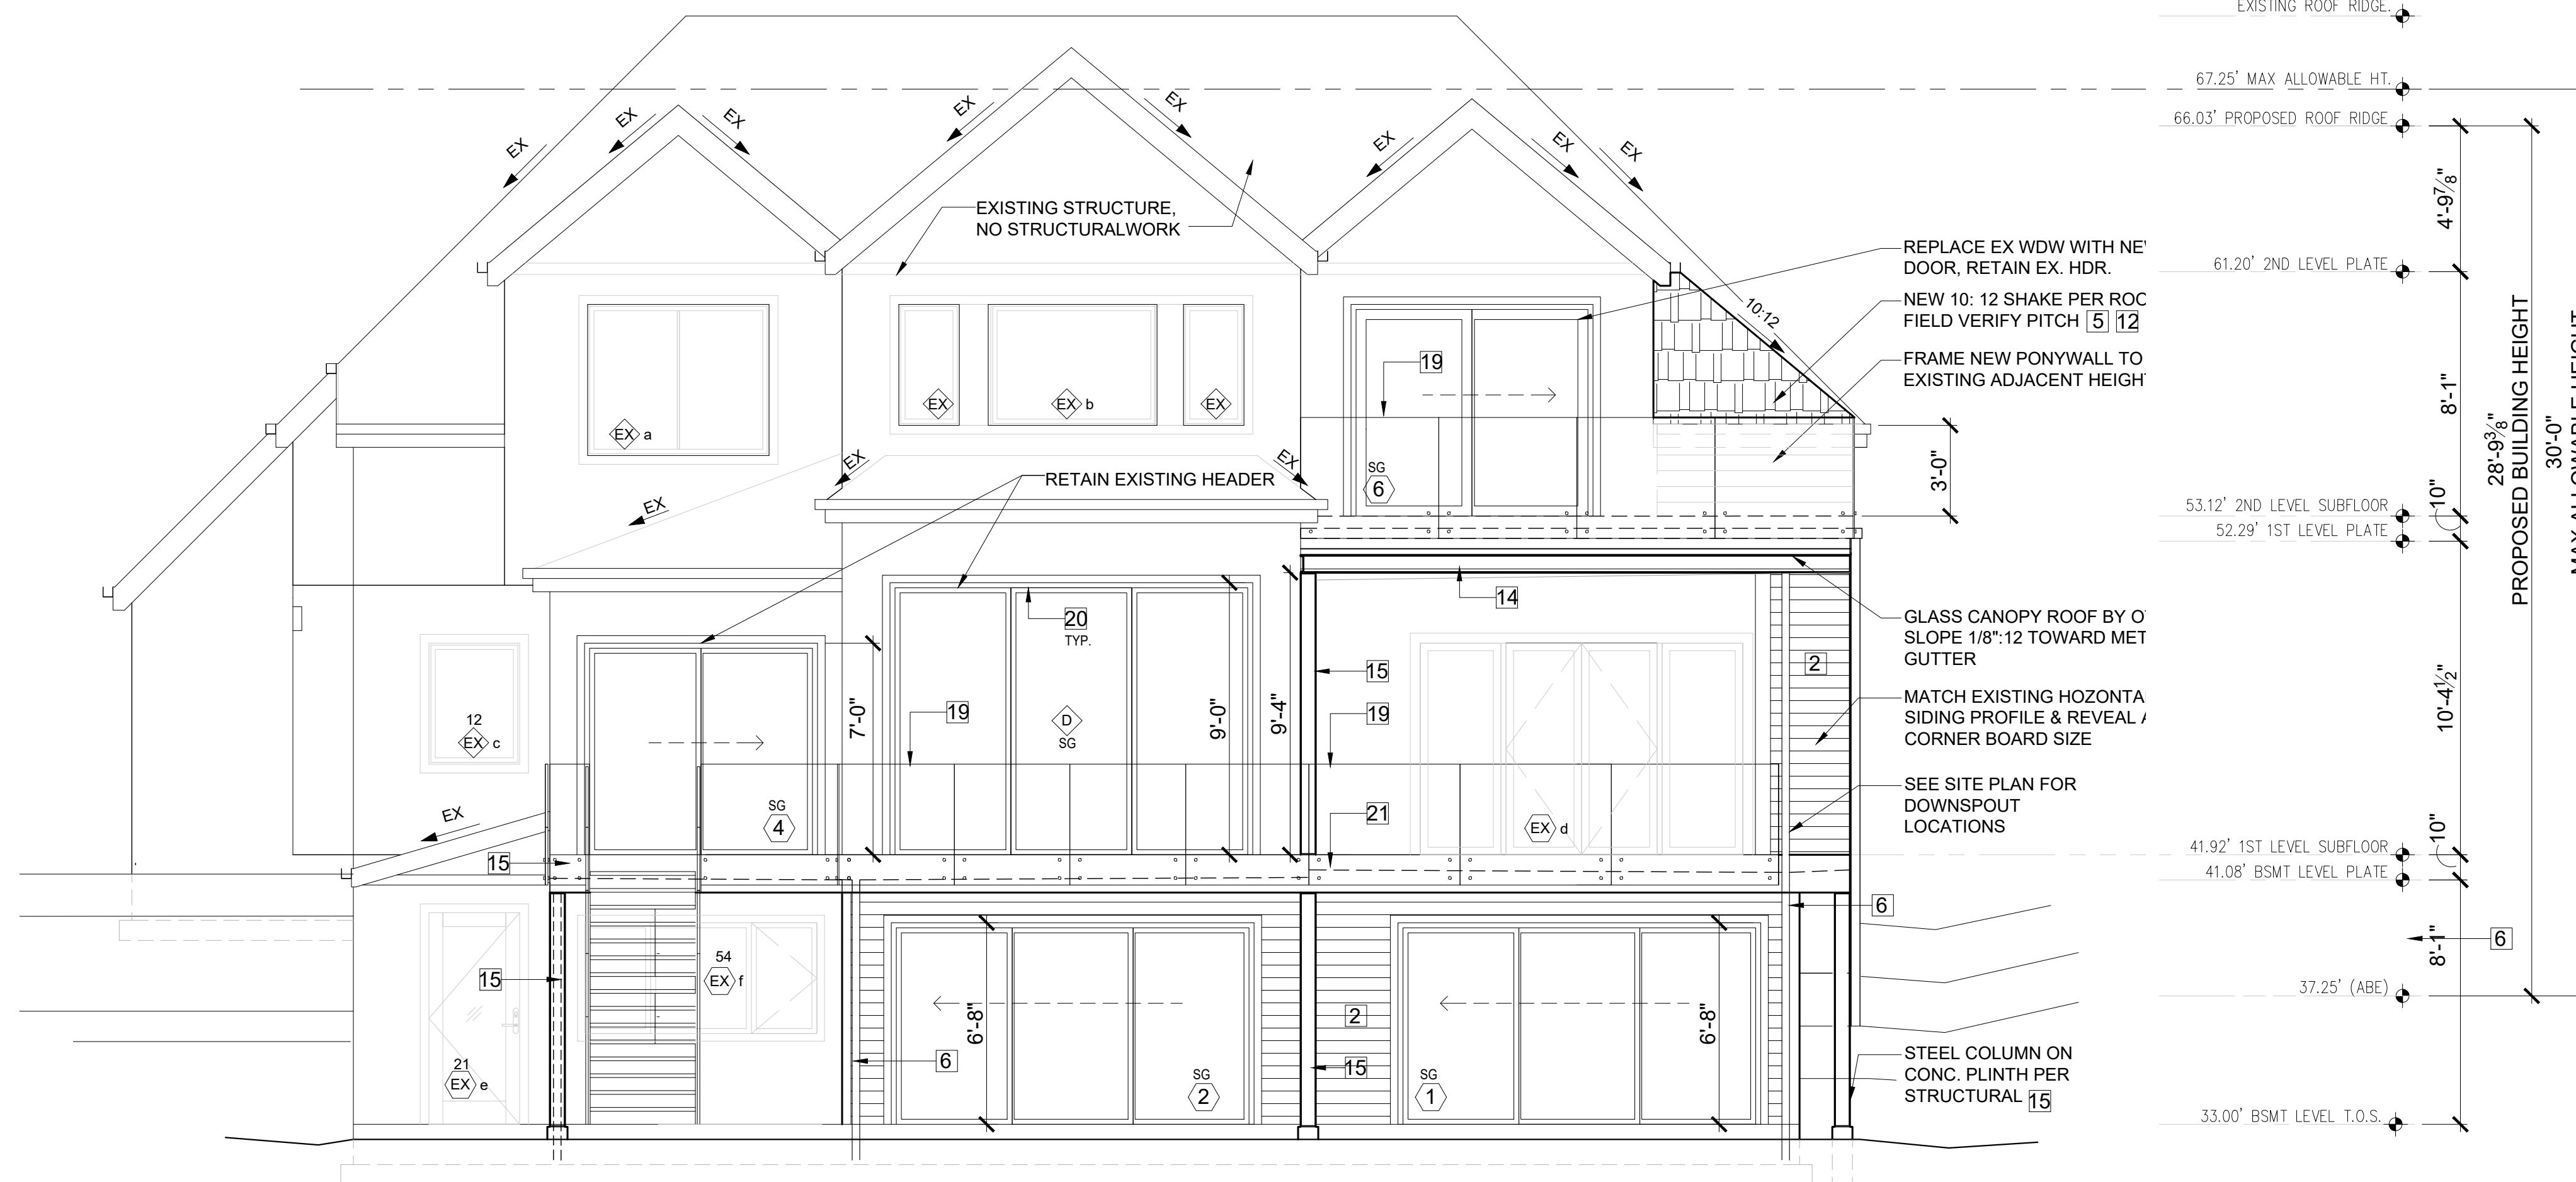

**EAST ELEVATION**  
SCALE: 1/4" = 1'-0"



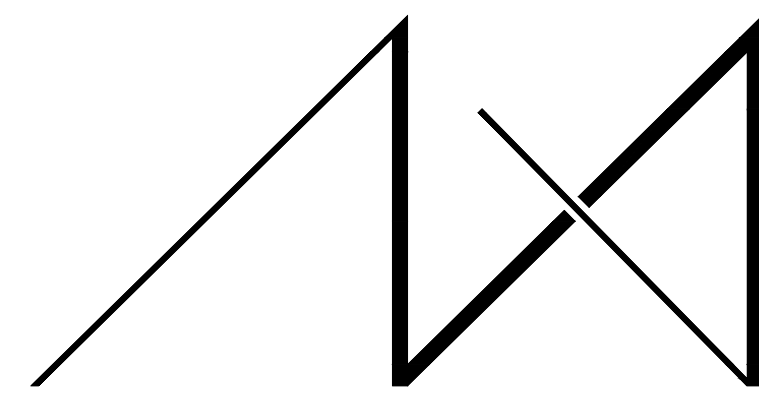

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**PARCEL # 082405-9027**

DRAWING NAME:

SECTIONS

Drawn By: JMG, RB

Checked By: EB

Owner Approval:

PHASE:

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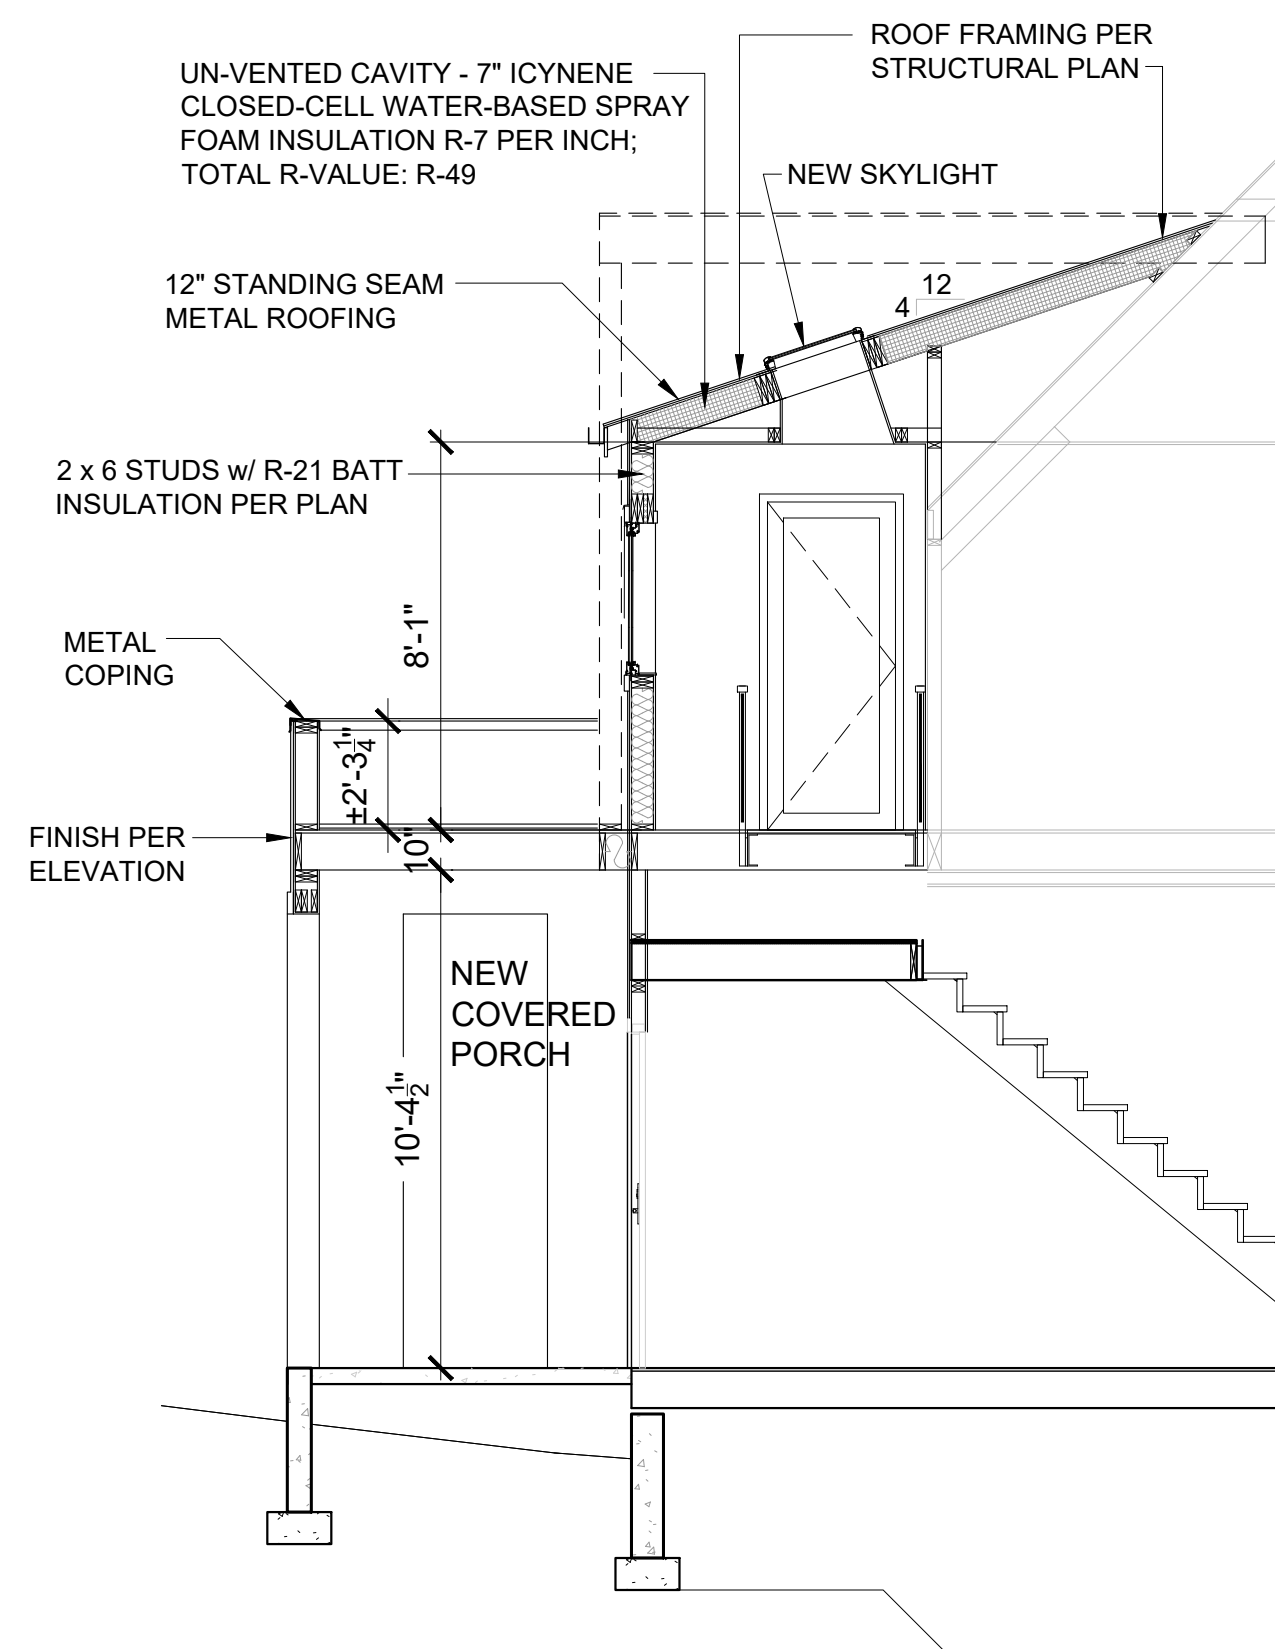
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PROJECT No.: 2020 007

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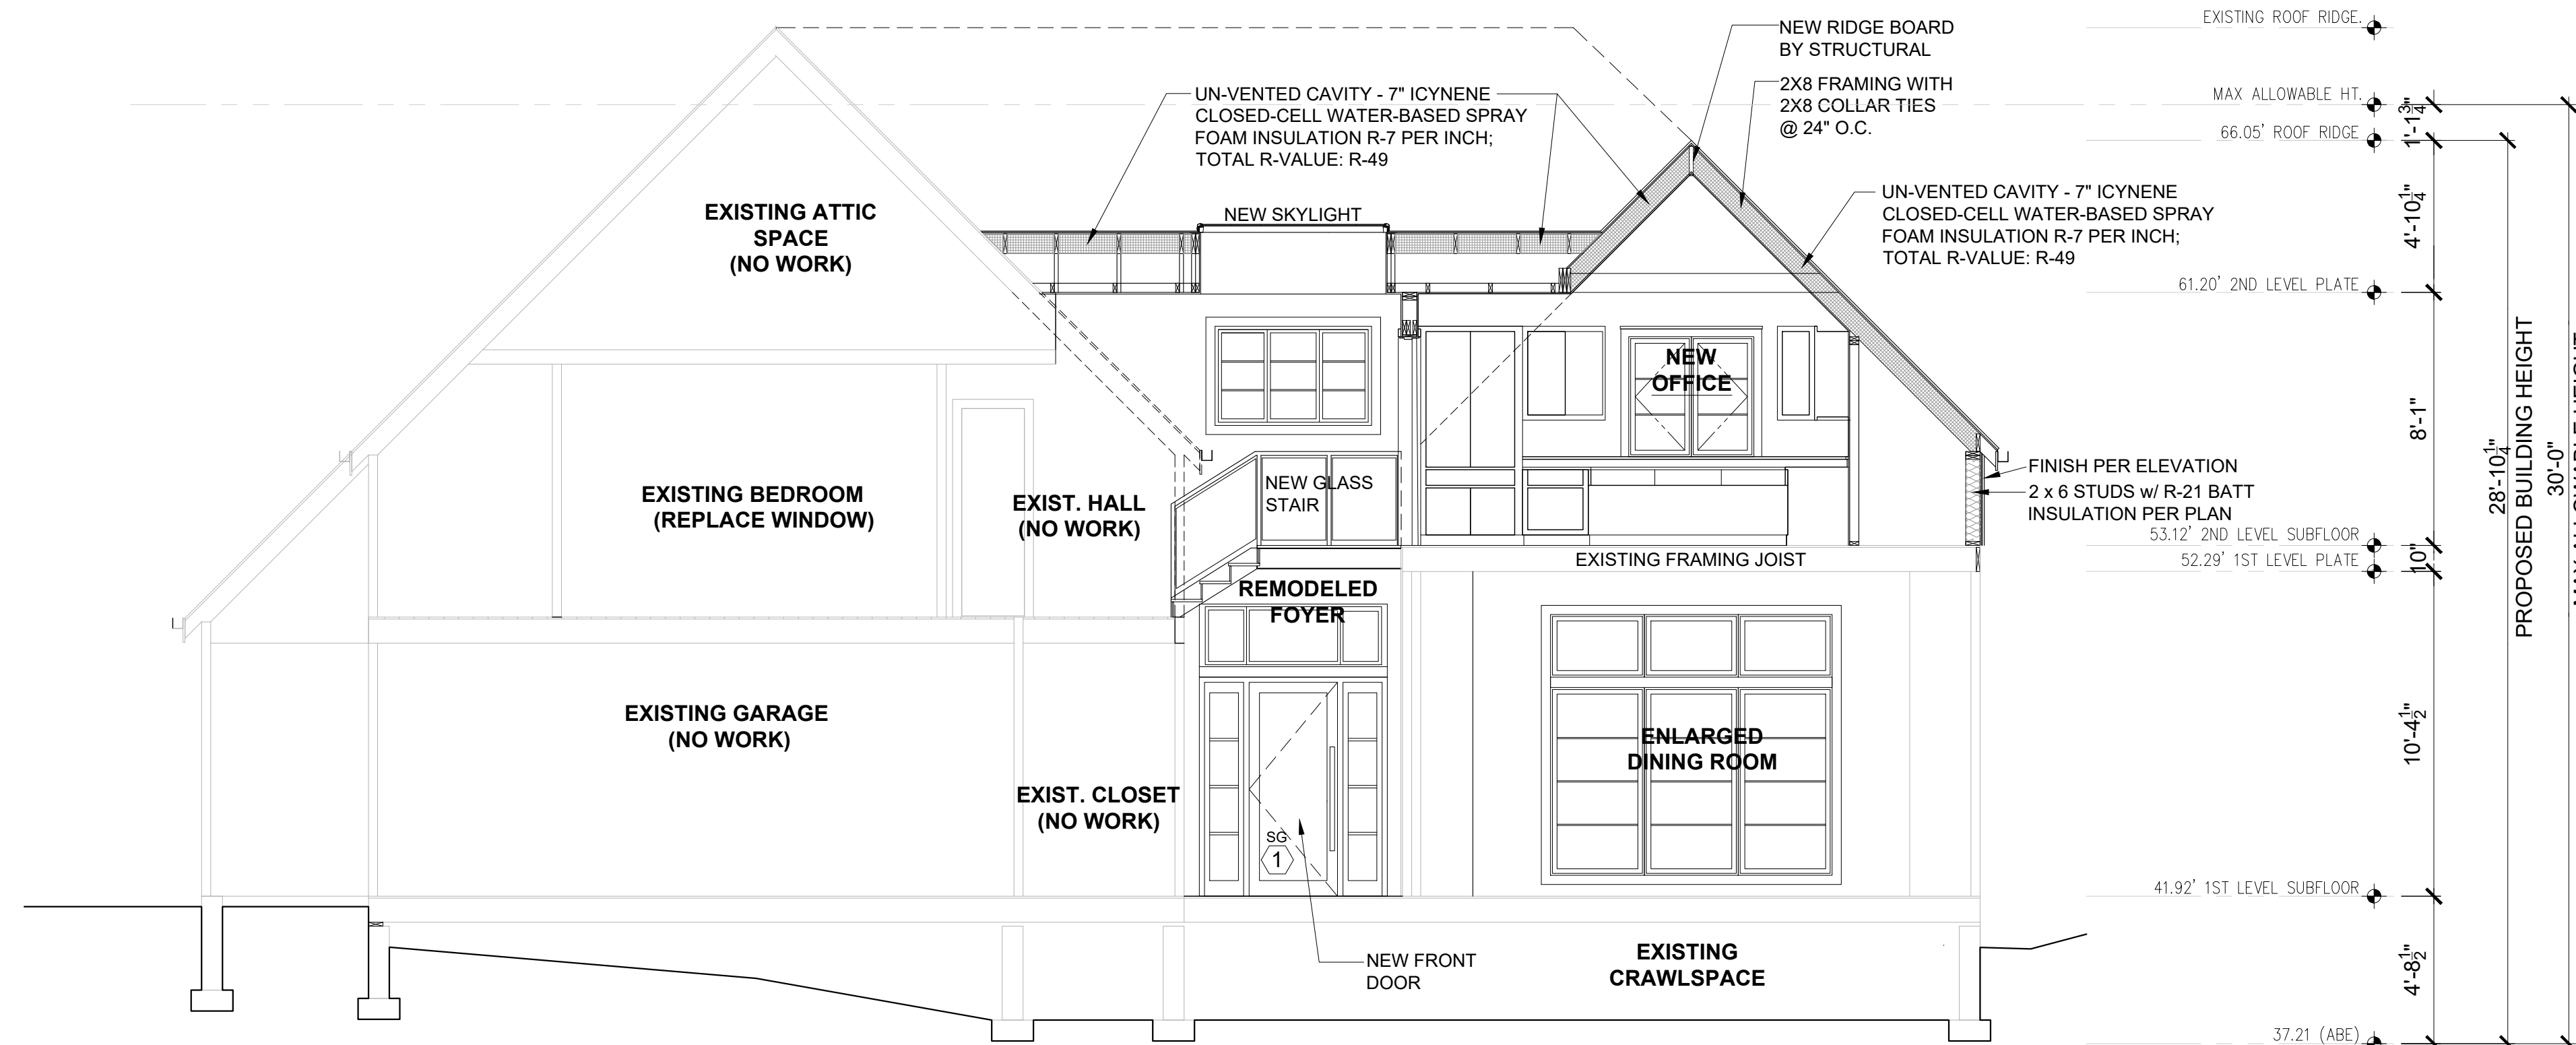
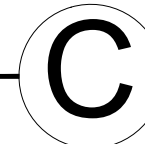
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A5.0




FOYER STAIR SECTION C

SCALE: 1/4" = 1'-0"




EAST-WEST SECTION BB

SCALE: 1/4" = 1'-0"

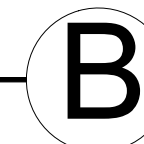



- THERMAL INSULATION:**
- Walls (below-grade, exterior): R-10 rigid insulation
  - Walls (below-grade, interior): R-21 batt or rigid insulation
  - Walls (above-grade): R-21 batt or rigid insulation
  - Headers: R-10 rigid insulation
  - Ceilings (advanced framing): R-38 batt
  - Ceilings (standard framing): R-49 batt
  - Ceilings (vaulted): Icynene with min R-49
  - Floors: R-30 batt or rigid insulation
  - Slab: R-10 water-resistant rigid insulation
  - Solid doors: U-value of .20 or better
  - Windows & doors with glazing: U-value of .30 or better
  - Skylights: U-value of .50 or better

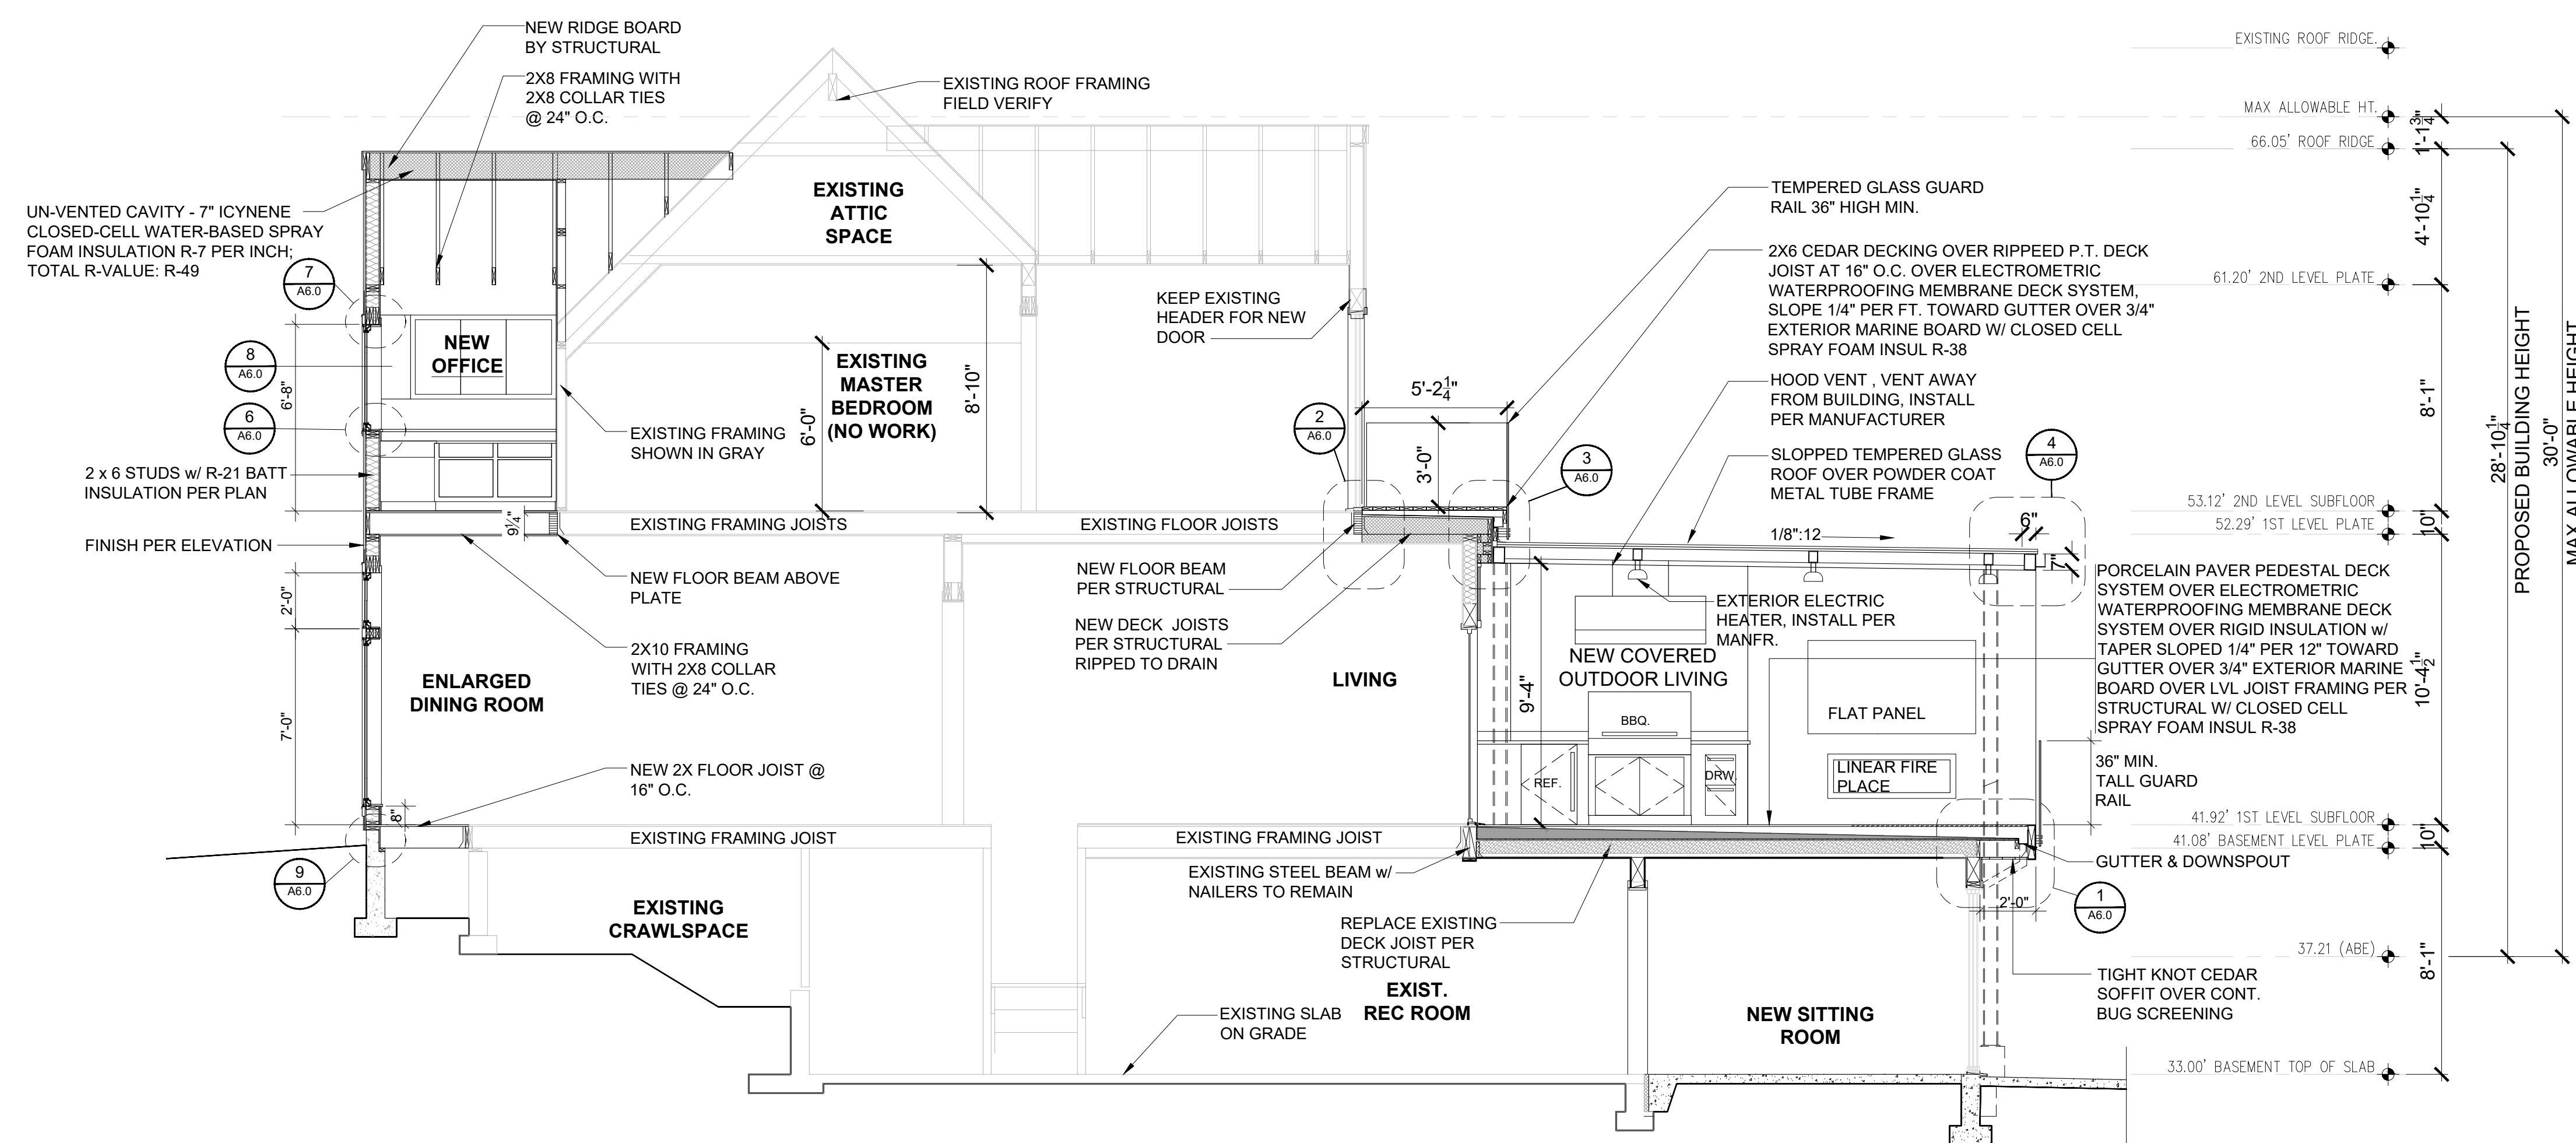

NORTH-SOUTH SECTION AA

SCALE: 1/4" = 1'-0"

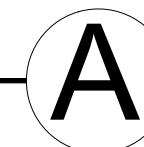

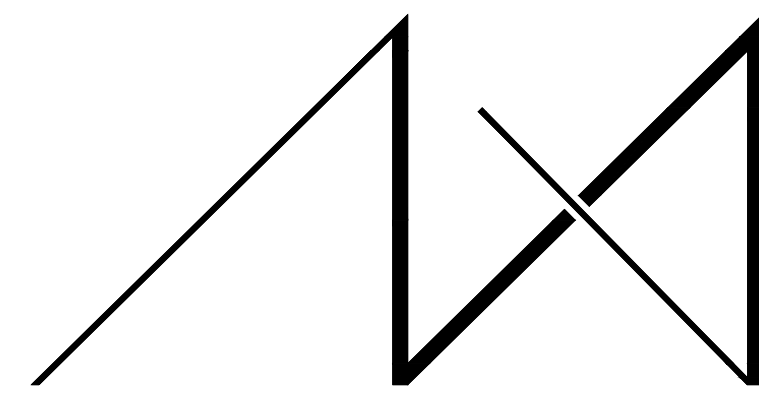


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**PARCEL # 082405-9027**

DRAWING NAME:

**DETAILS**

Drawn By: JMG, RB  
Checked By: EB  
Owner Approval:
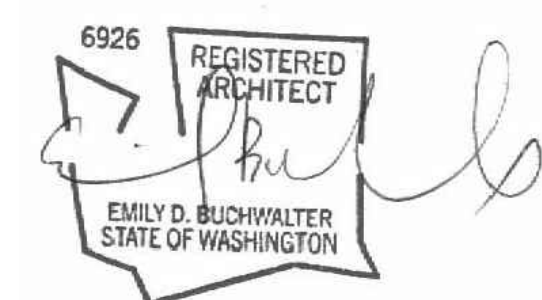
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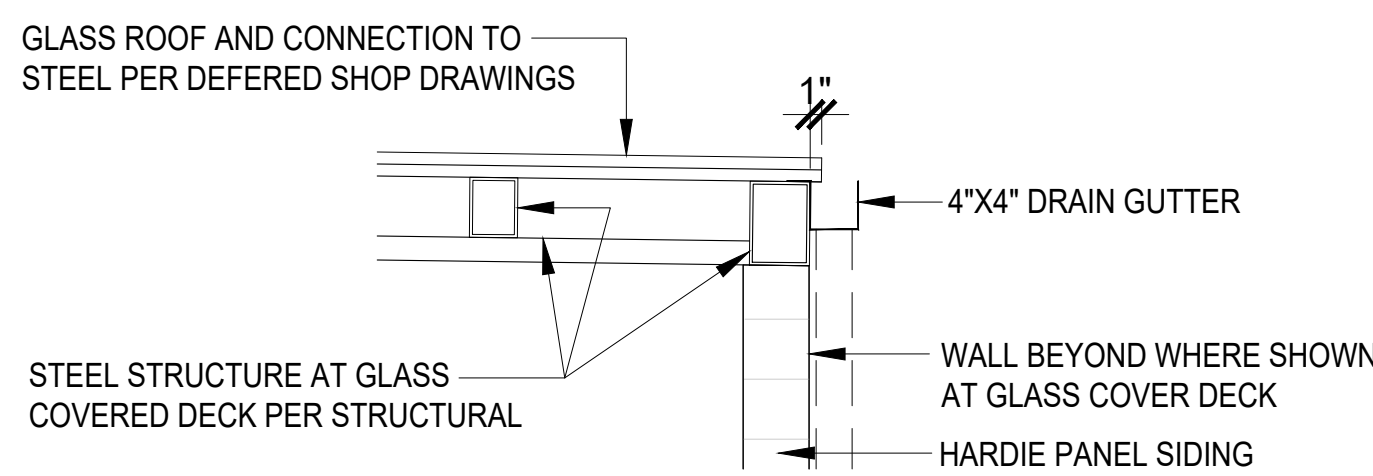
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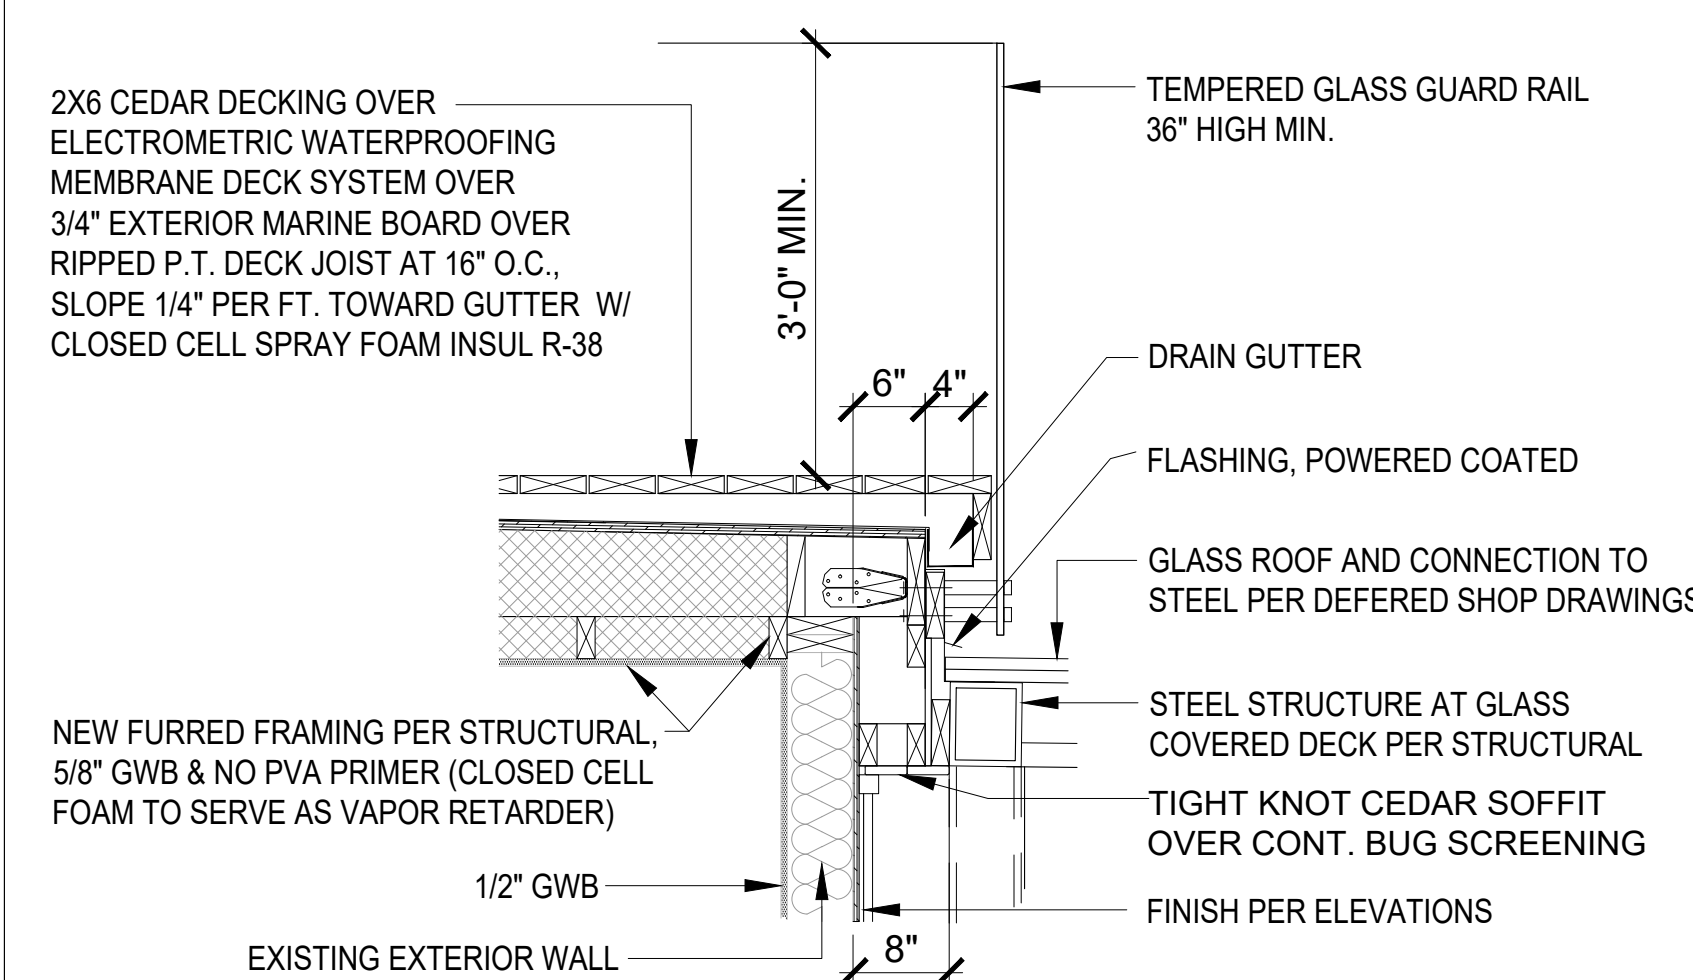
DATE: 12-22-2020

PLOT SCALE: 1:1


**A6.0**




**4 GLASS COVERED DECK STRUCTURE DETAIL**  
SCALE: 3/4" = 1'-0"




**3 MASTER BEDROOM DECK / GLASS COVERED DECK**  
SCALE: 3/4" = 1'-0"

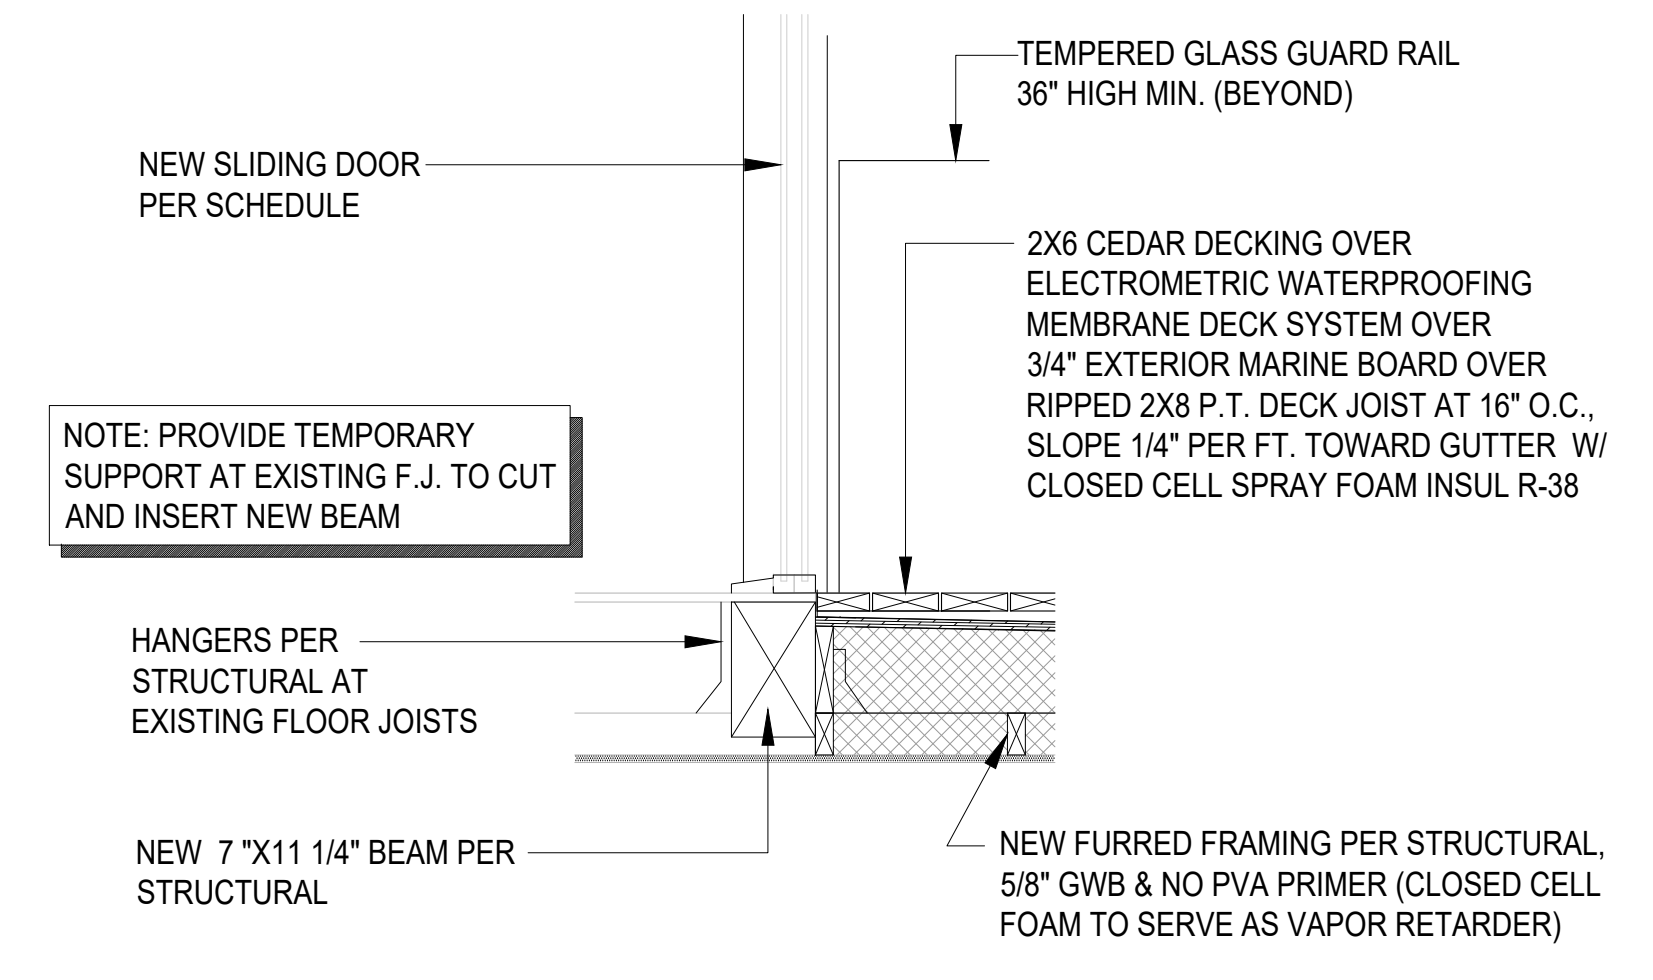


**2 MASTER BEDROOM WALK OUT DECK**  
SCALE: 3/4" = 1'-0"

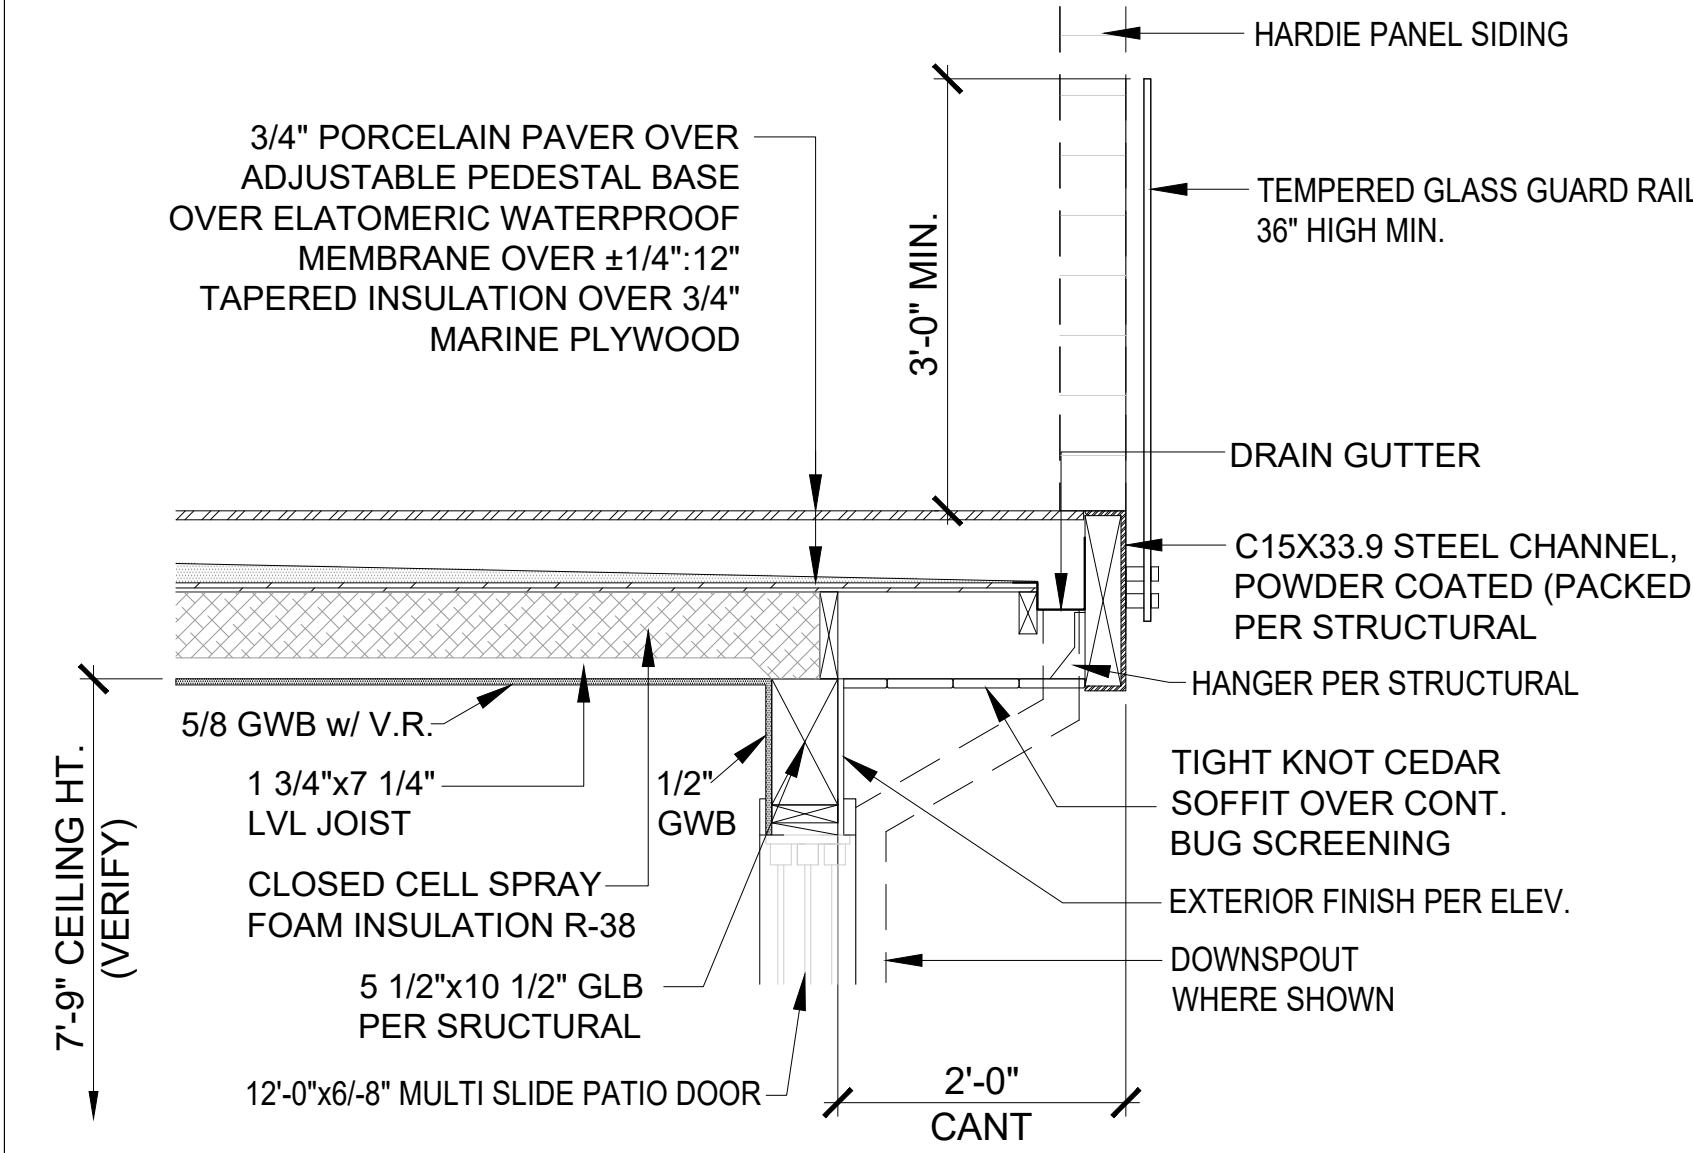


**1 1st FLOOR DECK & RAILING**  
SCALE: 3/4" = 1'-0"

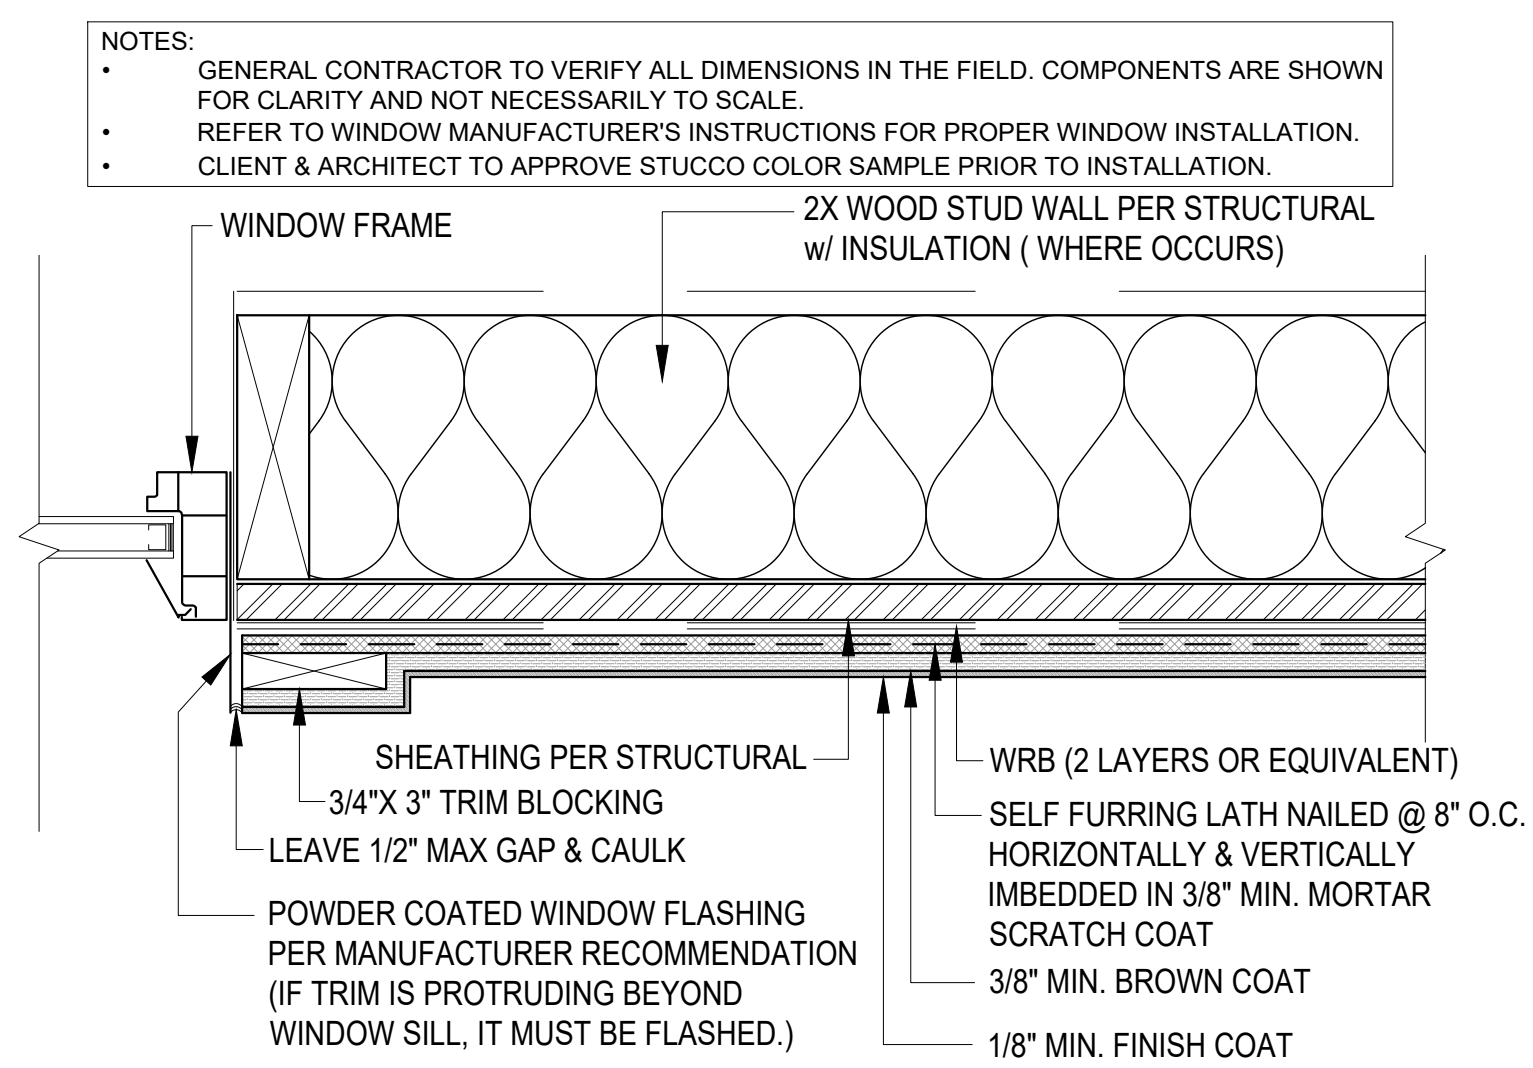


**8 WINDOW JAMB @ STUCCO**  
SCALE: 3" = 1'-0"

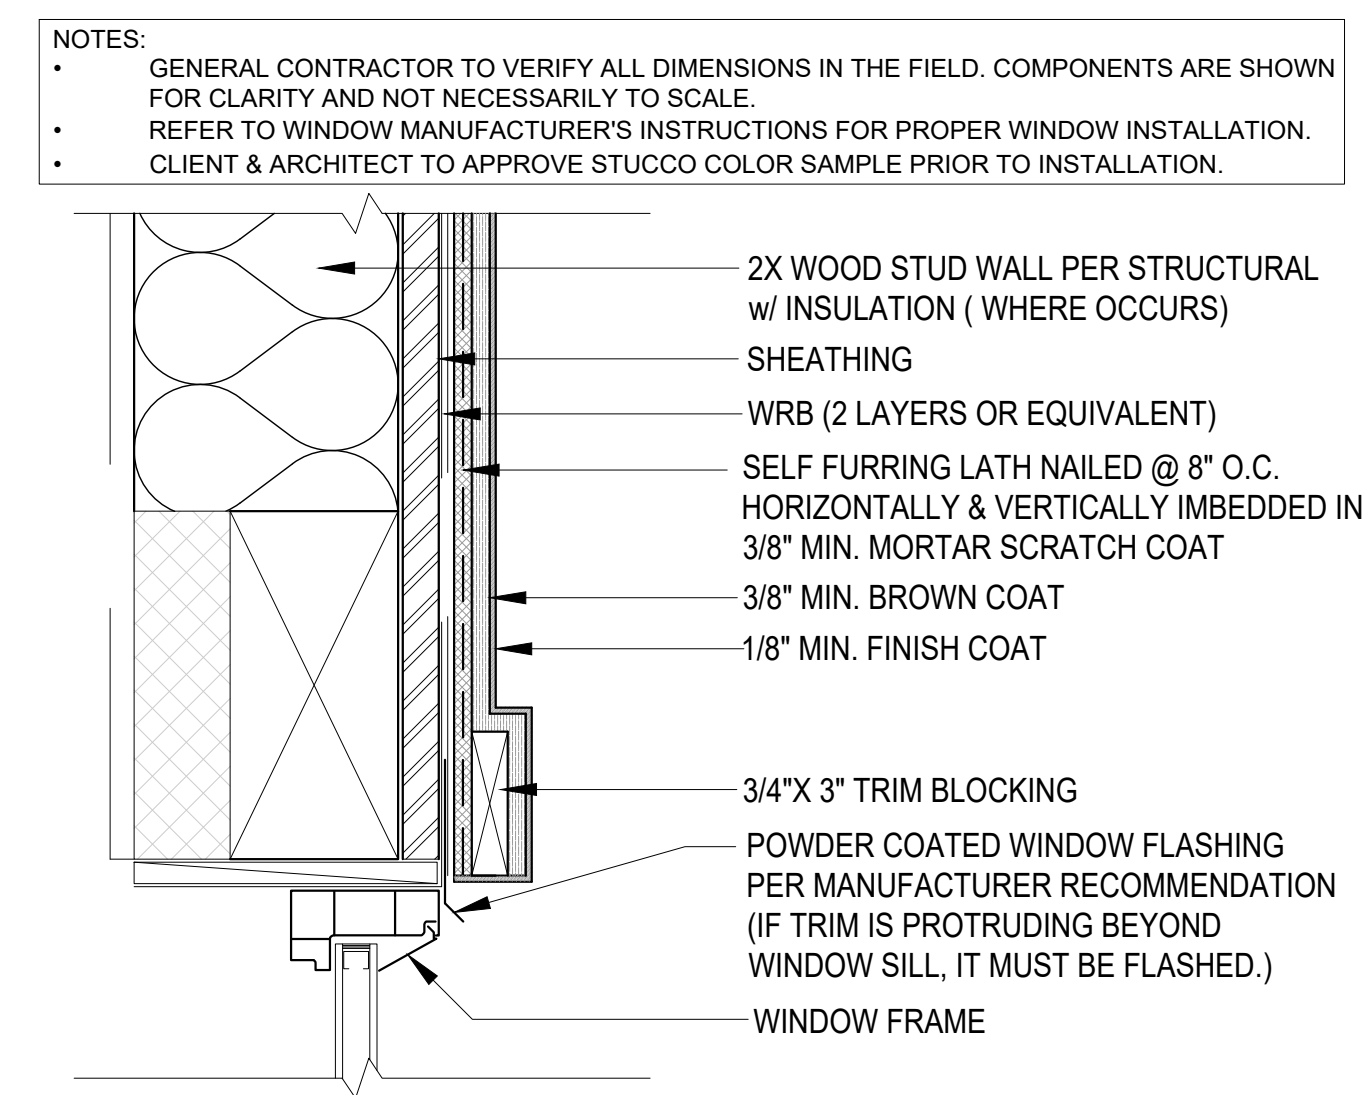


**7 WINDOW HEAD @ STUCCO**  
SCALE: 3" = 1'-0"

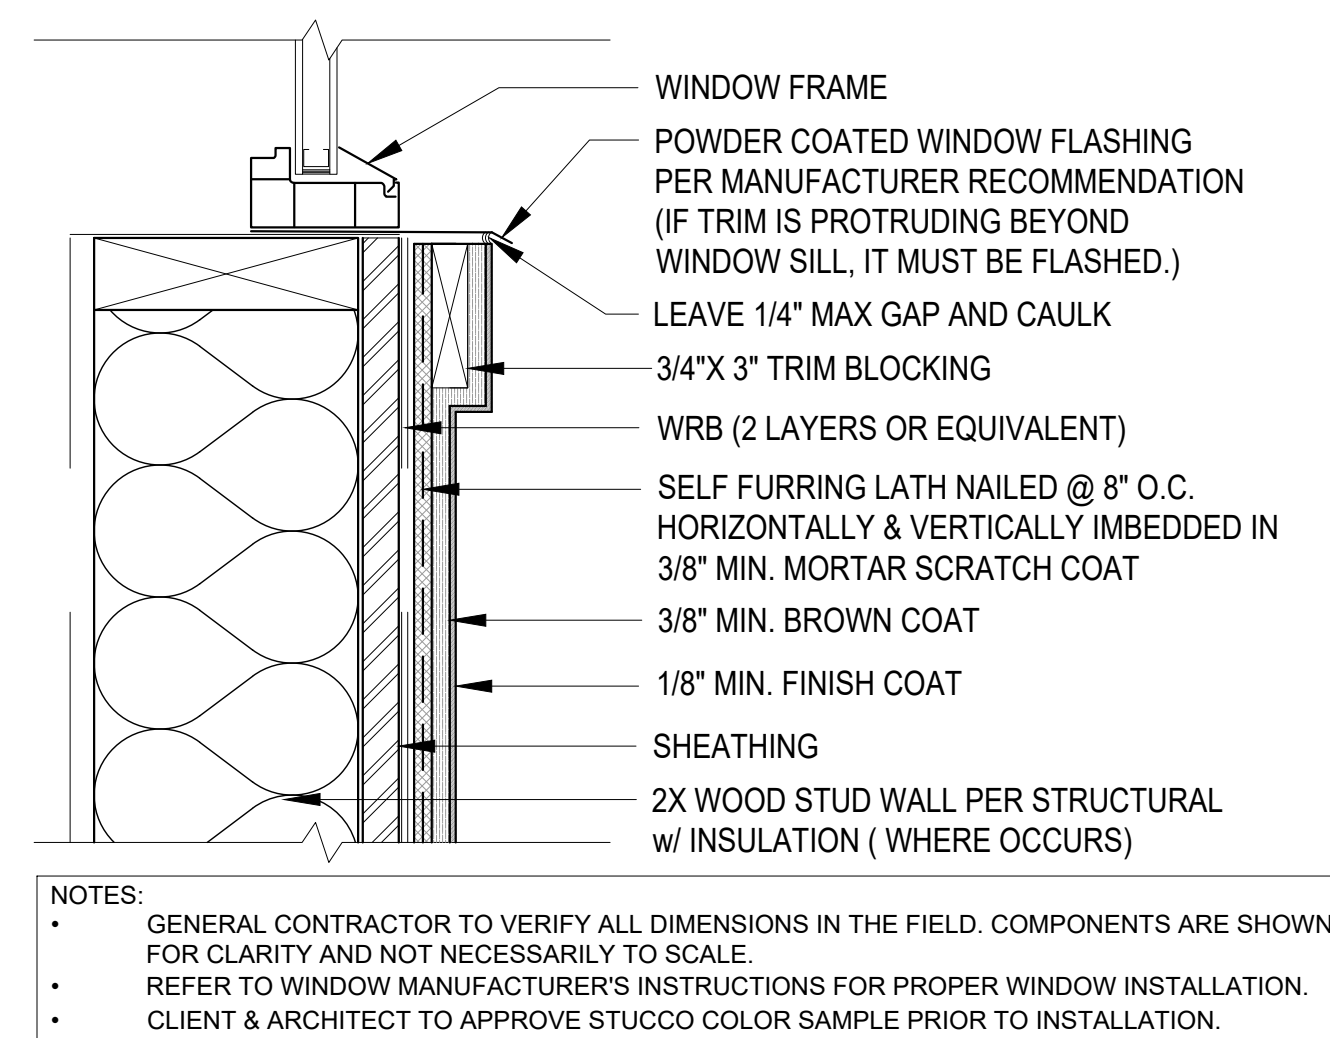

**6 WINDOW SILL @ STUCCO**  
SCALE: 3" = 1'-0"

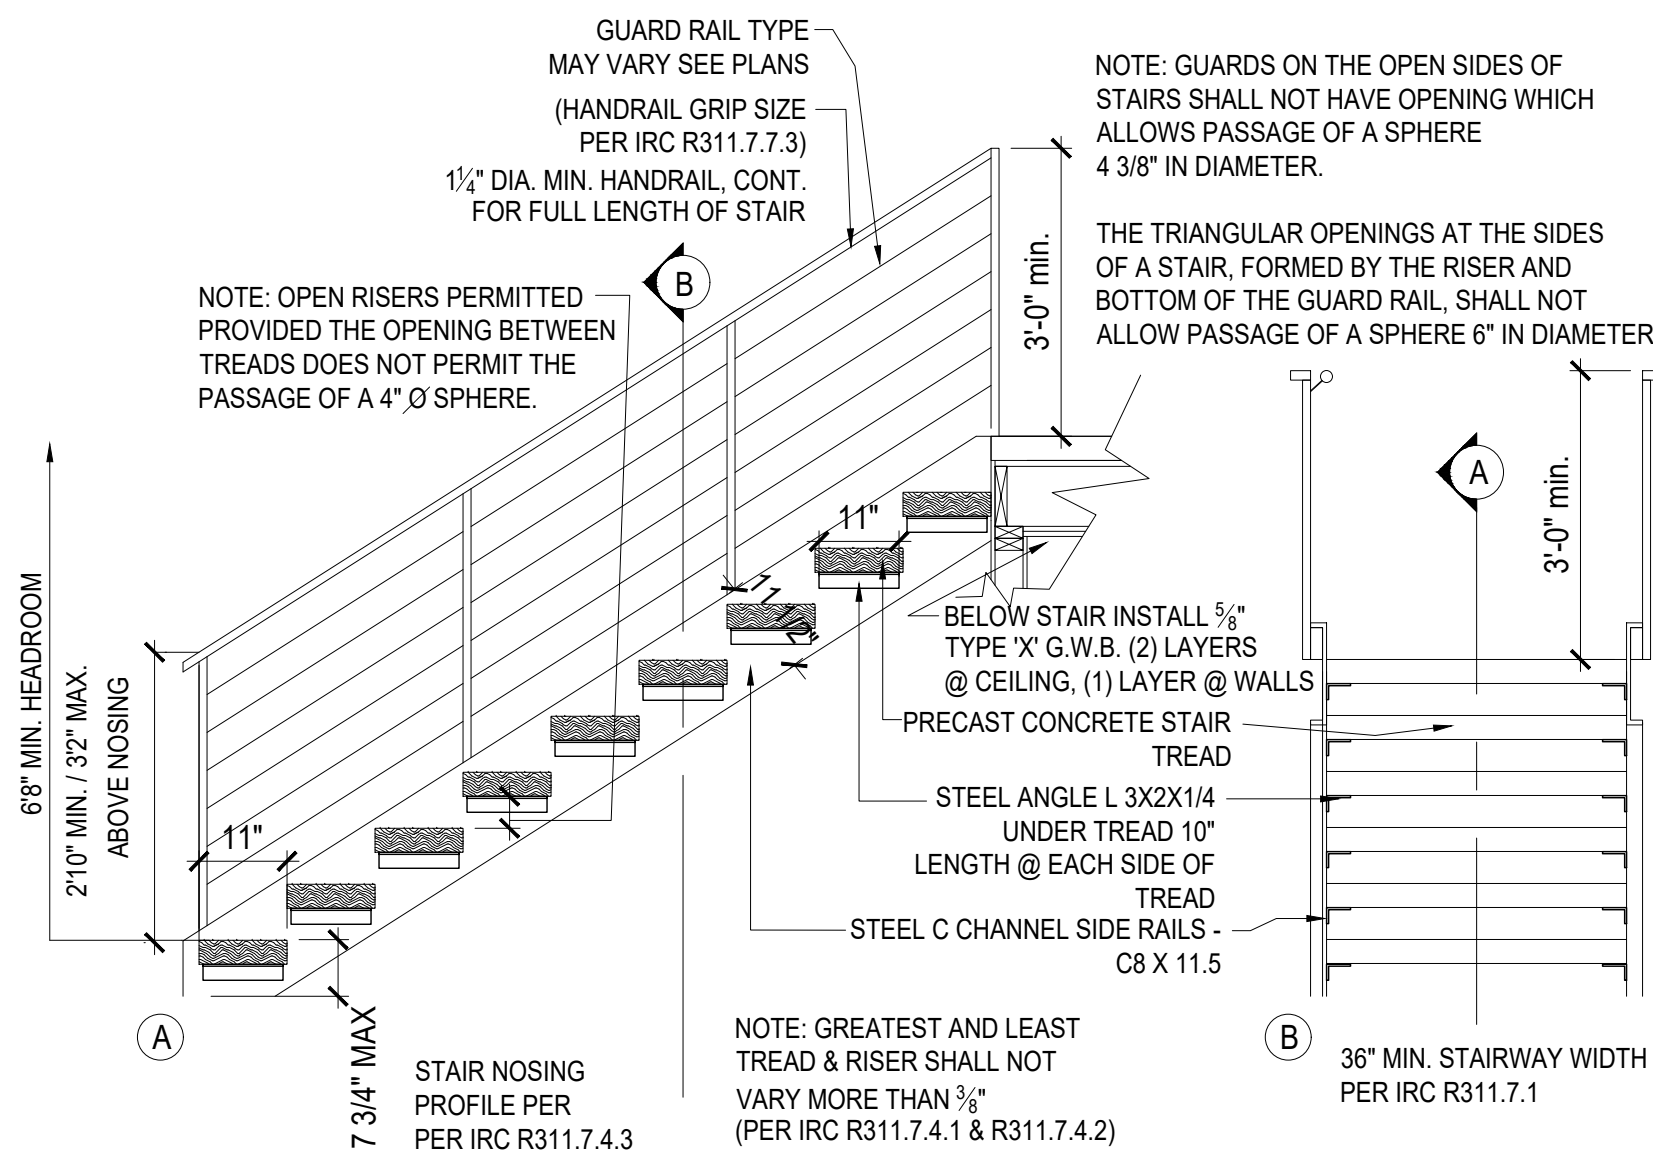

**5 STAIRS @ EXTERIOR DECK**  
SCALE: 1/2" = 1'-0"

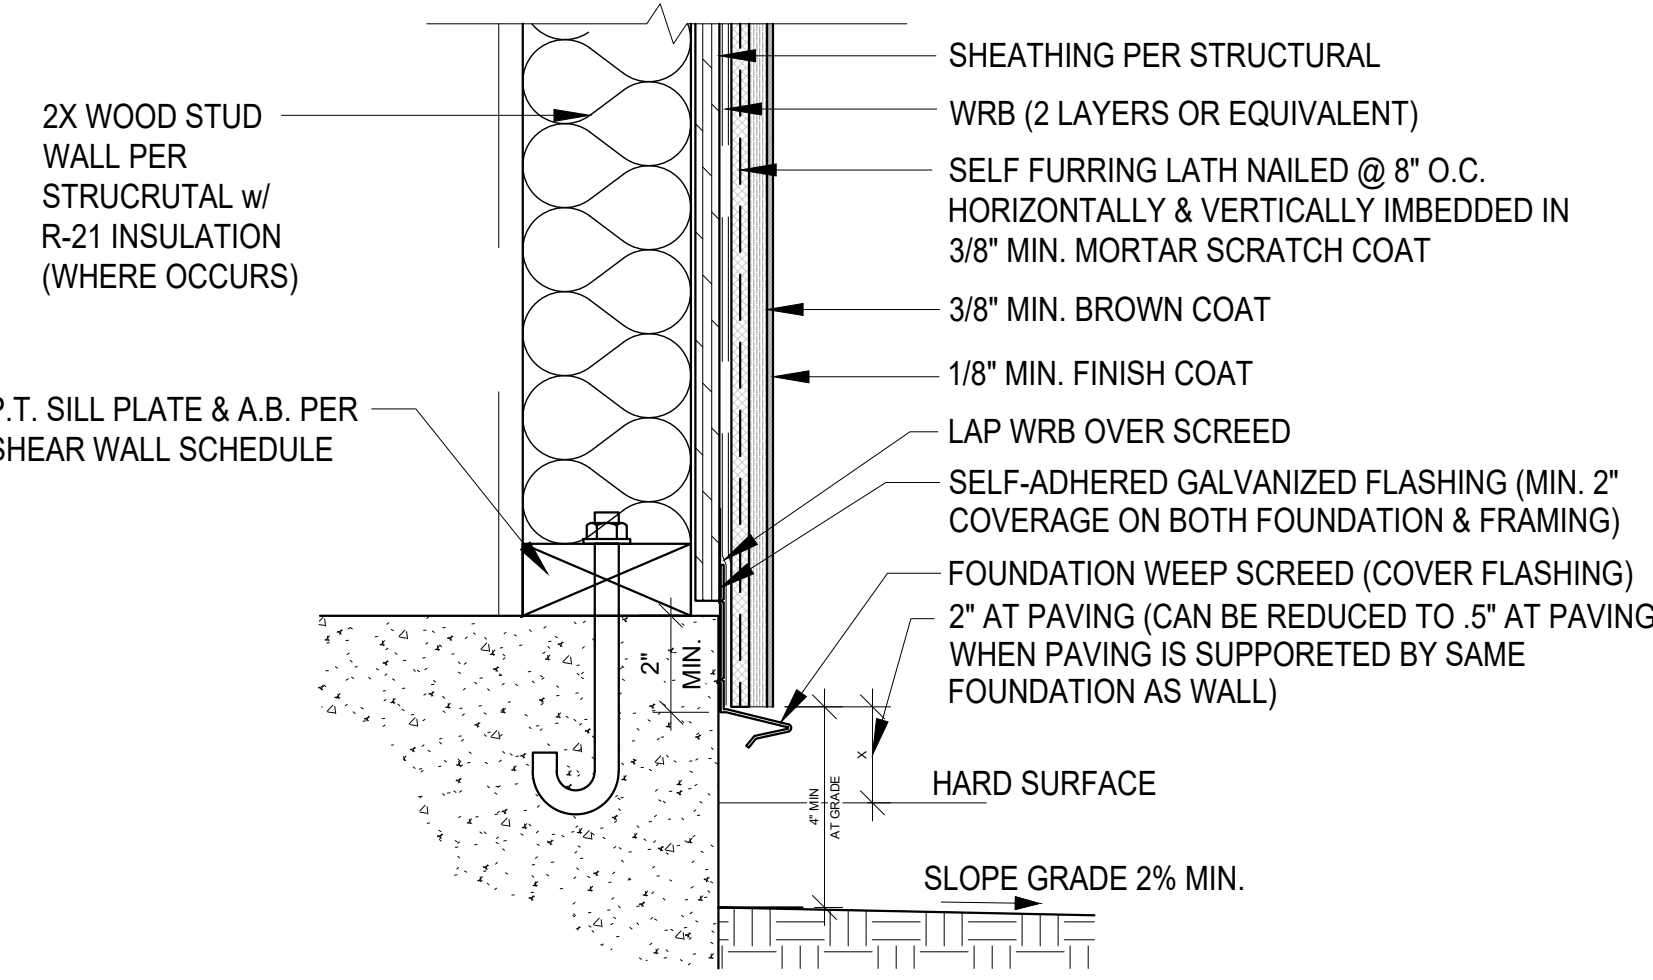

**9 STUCCO @ FOUNDATION**  
SCALE: 3" = 1'-0"

**12 XXX**  
SCALE: 1" = 1'-0"

**11 XXX**  
SCALE: 1" = 1'-0"

**10 XXX**  
SCALE: 1" = 1'-0"

**9 STUCCO @ FOUNDATION**  
SCALE: 3" = 1'-0"

**16 XXX**  
SCALE: 1" = 1'-0"

**15 XXX**  
SCALE: 1" = 1'-0"

**14 XXX**  
SCALE: 1" = 1'-0"

**13 XXX**  
SCALE: 1" = 1'-0"

**8 WINDOW JAMB @ STUCCO**  
SCALE: 3" = 1'-0"

**7 WINDOW HEAD @ STUCCO**  
SCALE: 3" = 1'-0"

**6 WINDOW SILL @ STUCCO**  
SCALE: 3" = 1'-0"


**5 STAIRS @ EXTERIOR DECK**  
SCALE: 1/2" = 1'-0"

**4 GLASS COVERED DECK STRUCTURE DETAIL**  
SCALE: 3/4" = 1'-0"

**3 MASTER BEDROOM DECK / GLASS COVERED DECK**  
SCALE: 3/4" = 1'-0"

**2 MASTER BEDROOM WALK OUT DECK**  
SCALE: 3/4" = 1'-0"

**1 1st FLOOR DECK & RAILING**  
SCALE: 3/4" = 1'-0"

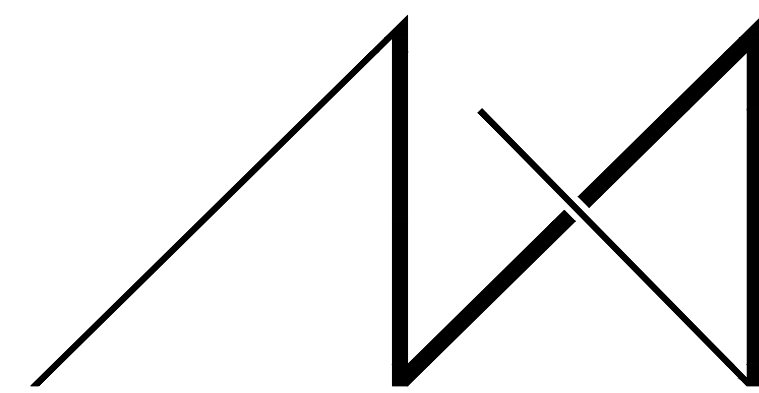

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**PARCEL # 082405-9027**

DRAWING NAME:

**DETACHED GARAGE CONSTRUCTION PLAN**

Drawn By: JMG, RB  
Checked By: EB  
Owner Approval:

PHASE:

**CONSTRUCTION DOCUMENTS**

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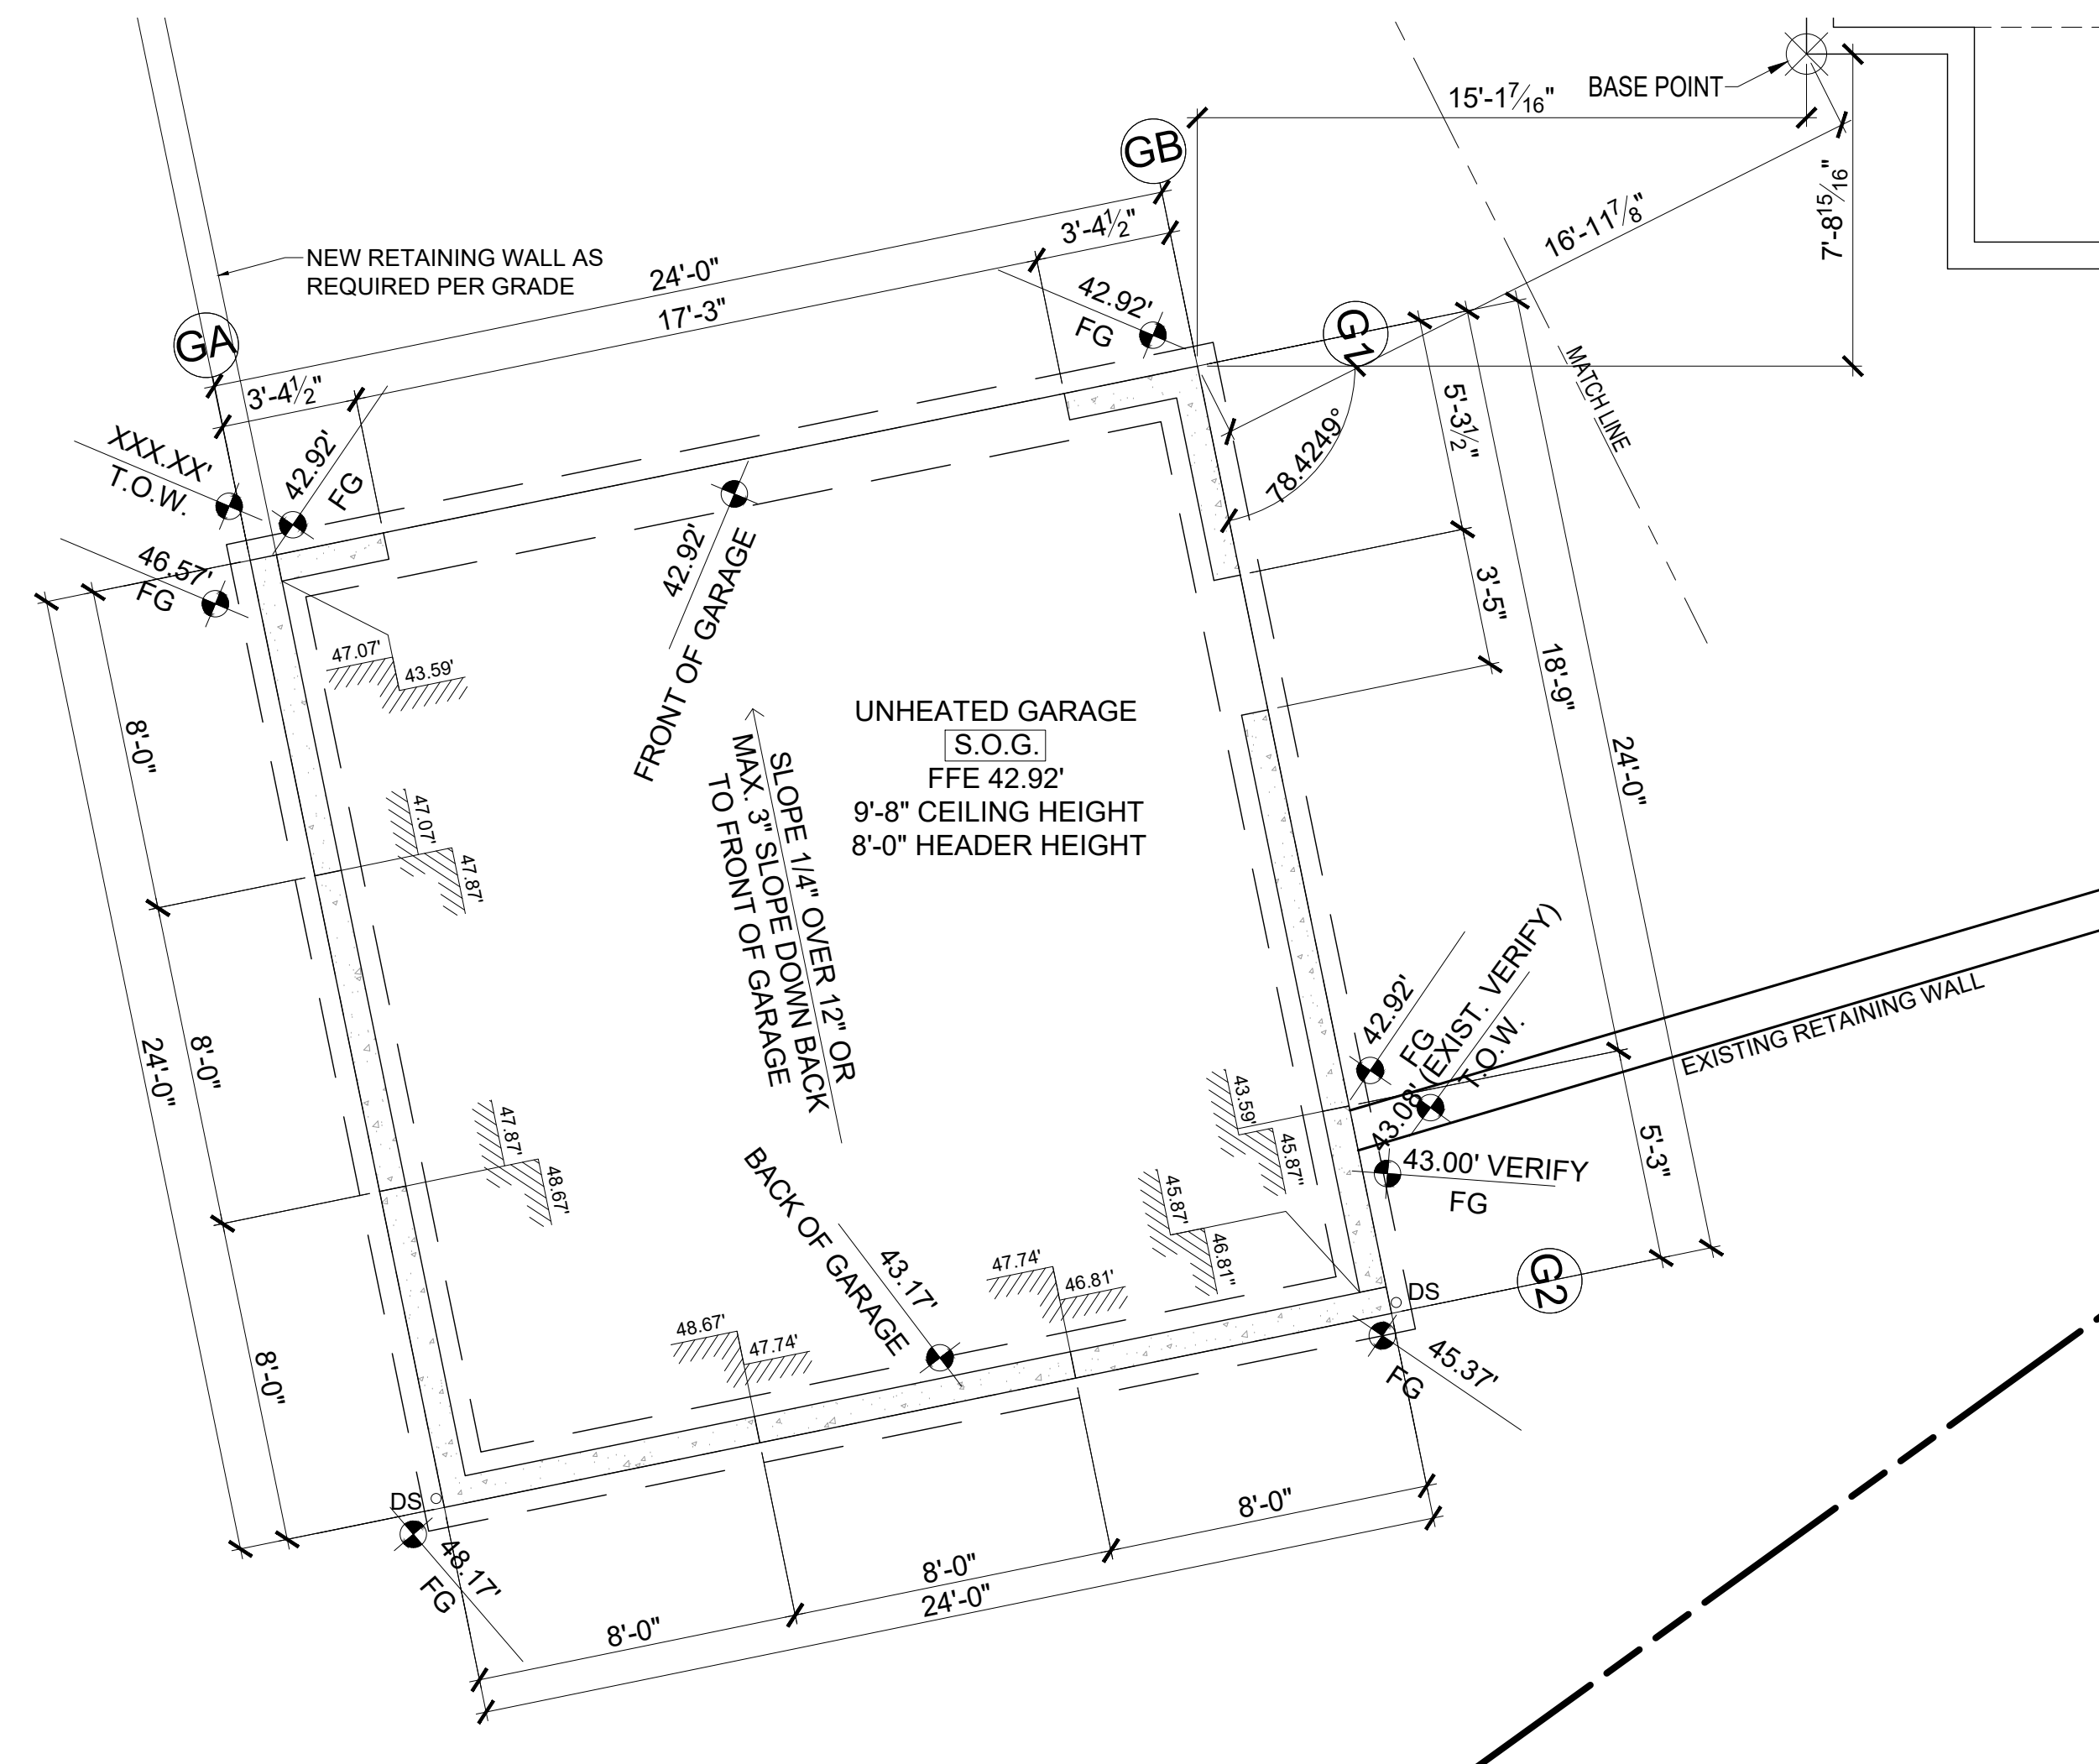
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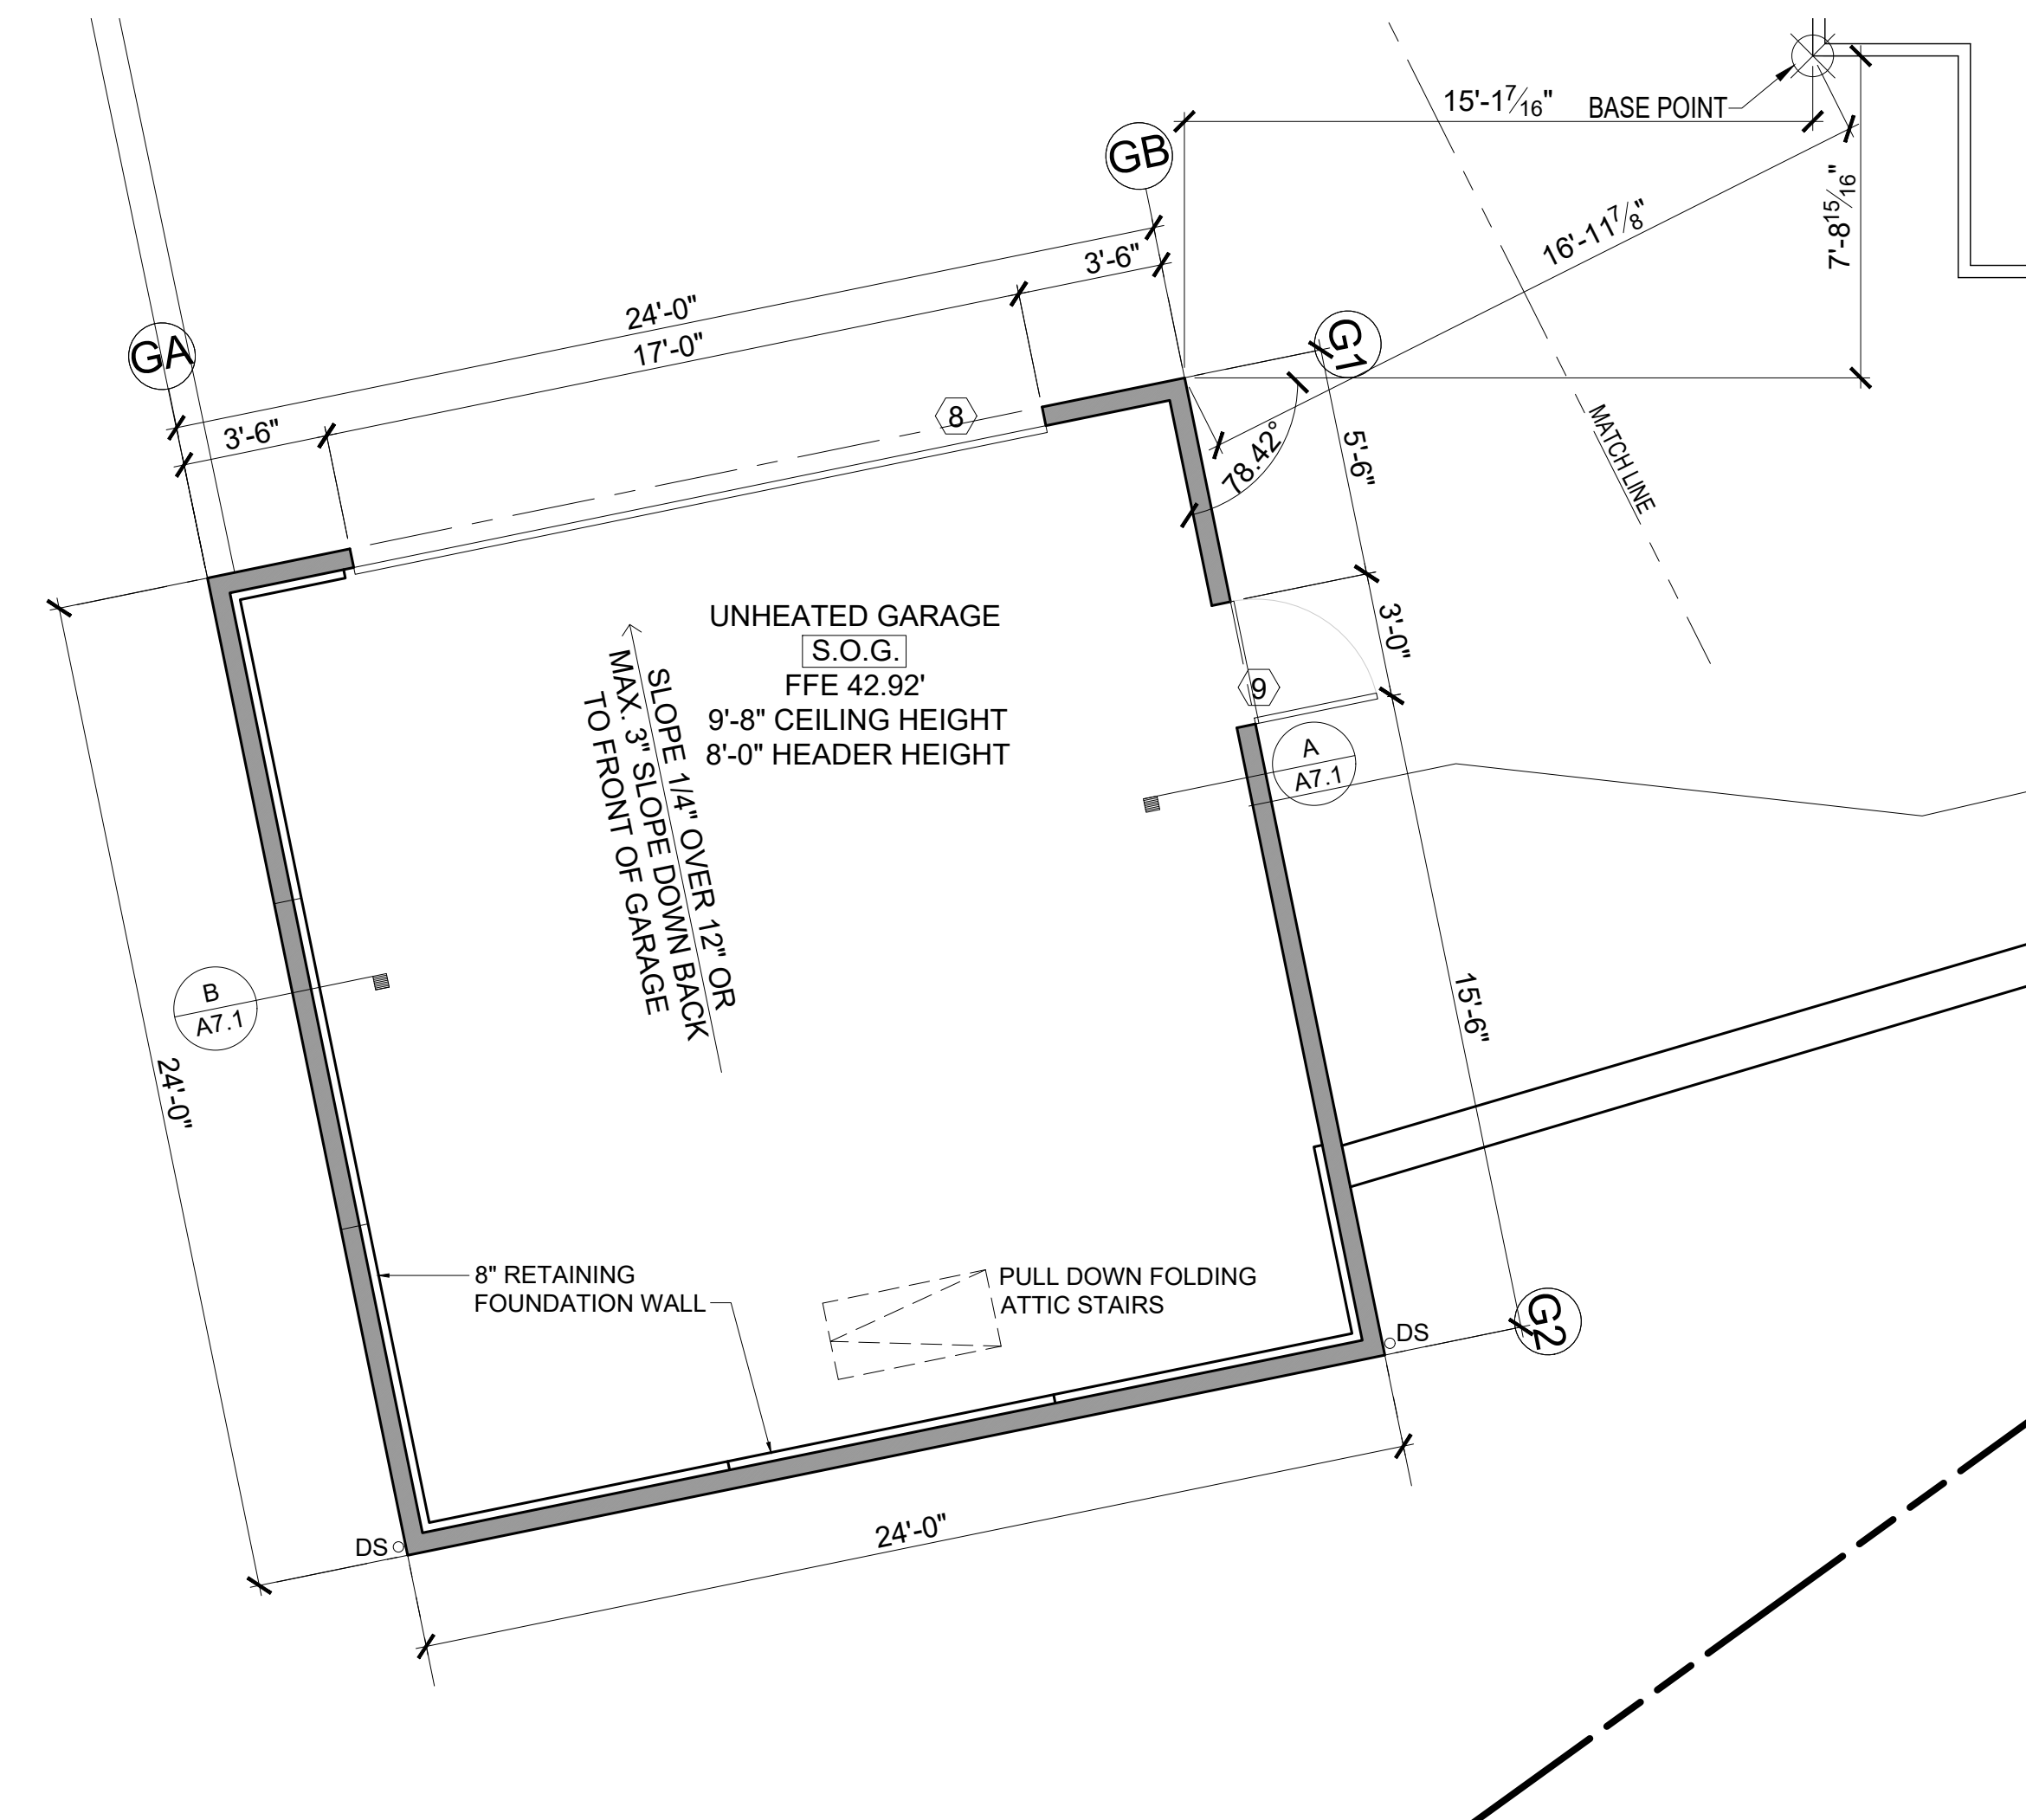
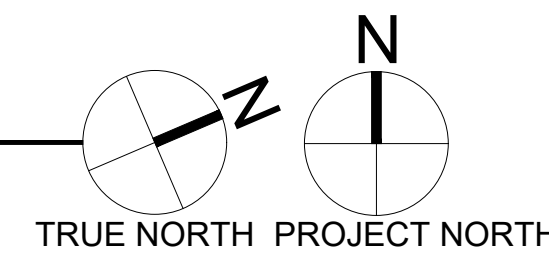
PLOT SCALE: 1:1

**A7.0**





**DETACHED GARAGE FOUNDATION PLAN**

SCALE: 1/4" = 1'-0"




**DETACHED GARAGE FLOOR PLAN**

SCALE: 1/4" = 1'-0"

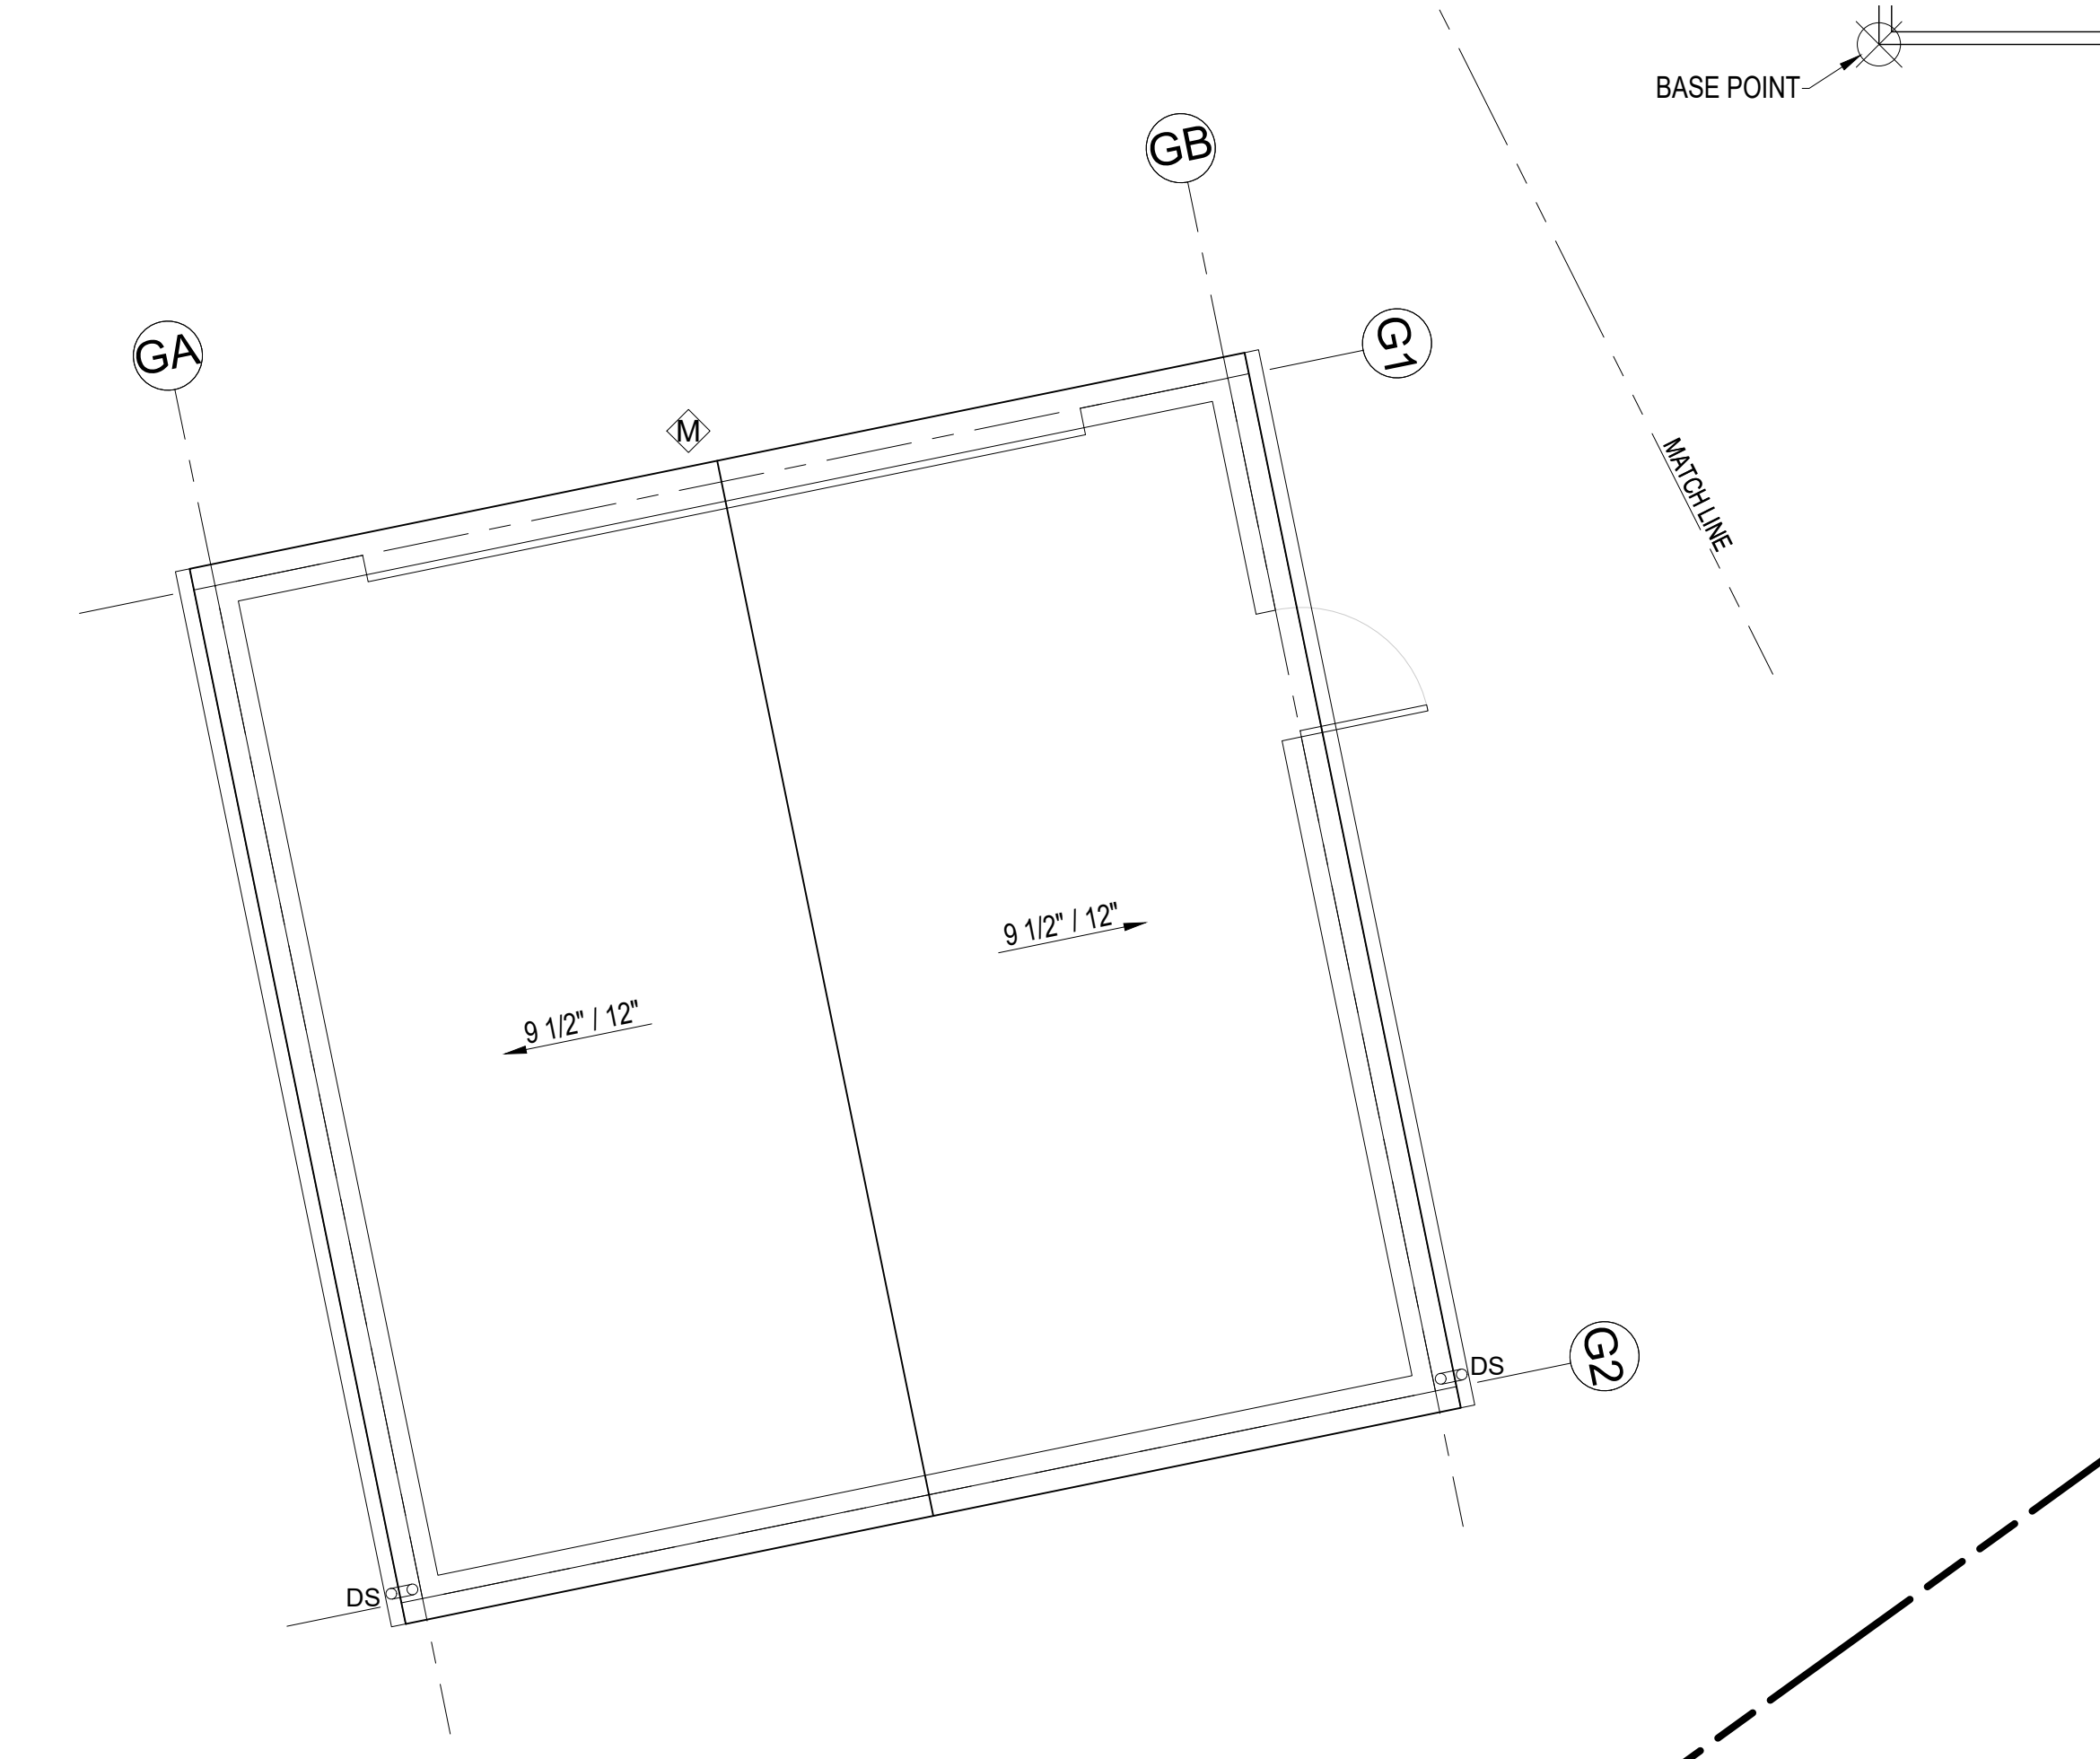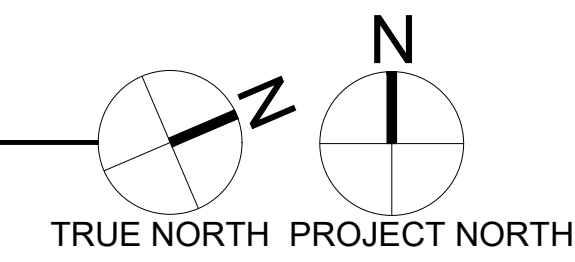

**DETACHED GARAGE ROOF PLAN**

SCALE: 1/4" = 1'-0"

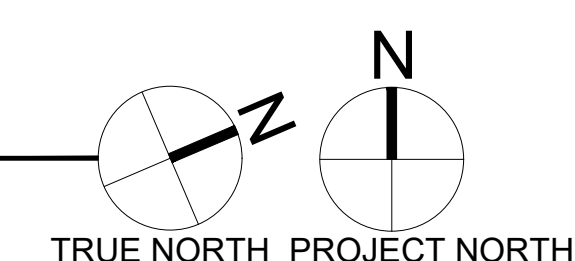

ROOF - VENTILATION CALCULATION				
Detached Garage - Roof trusses				
Roof Area:	533.0	s.f.		
Ventilation Required:	533.0	s.f. x 144 s.i. / 300"=	255.8	s.i. Req'd
Proposed Ventilation :				
SmartVent Shingle vent (upper or ridge)	4.5	s.i. nfa / l.f.=	4.5	s.i. / l.f.
Provide :	28.0	l.f. Upper Ventilation =	126.0	s.i.
SmartVent Shingle vent (lower roof edge)	4.5	s.i. nfa / l.f. =	4.5	s.i.
Provide:	30.0	l.f. Eave Edge Ventilation =	135.0	s.i.
Total Ventilation Provided	261.0	s.i. IS GREATER THAN	255.8	s.i. Req'd

**FLOOR PLAN NOTES**


1. CONTRACTOR SHALL VERIFY ALL NOTES, DIMENSIONS & CONDITIONS PRIOR TO CONSTRUCTION.
2. ALL POSTS, BEAMS & HEADERS SEE STRUCTURAL DRAWINGS.
3. WINDOWS & DOORS ARE SHOWN & NOTED AS NOMINAL SIZES. REFER TO SHEET A4.0 WINDOW AND DOOR SIZES.
4. DOOR JAMB 4.5" U.N.O.
5. SEE ELEVATIONS SHEETS A7.1 FOR WINDOW & DOOR HEADER HEIGHTS ABOVE FINISHED FLOOR.
6. ALL WOOD IN CONTACT WITH CONCRETE TO BE PRESSURE TREATED.
7. EXTERIOR WALLS TO BE 2x4 STUDS @ 16" O.C. U.N.O.
8. INSTALL SIMPSON CONG. TO WOOD HOLD-DOWNS PER STRUCTURAL DRAWINGS, ALSO SEE MANUFACTURER'S SPECS.
9. SEE SHEET A0.1 FOR ADDITIONAL NOTES.
10. FIXTURES SHALL BE SPACED IN ACCORDANCE WITH FIGURE R307.1.

**SYMBOL LEGEND**


- SD SMOKE DETECTOR
- CO CARBON MONOXIDE DETECTOR
- 9 DOORS
- C WINDOWS
- 2X WALLS
- BRICK WALLS
- POST - VERIFY SIZE AND TYPE WITH STRUCTURAL PLAN

**ELEVATIONS NOTES & KEY NOTES:**


1. VERIFY SHEAR WALL NAILING & HOLD-DOWNS PER STRUCTURAL PLAN & SCHEDULE PRIOR TO INSTALLING SIDING.
2. STUCCO VENEER: 3-COAT PORTLAND CEMENT STUCCO SHALL HAVE A SCRATCH, BROWN AND FINISH COATS OF PORTLAND CEMENT EXTERIOR PLASTER PER IRC SECTION R703.6.2; SAND FINISH COAT WITH INTEGRAL COLOR, OVER EXTERIOR METAL LATH PER IRC SECTION R703.6.1. TOTAL THICKNESS APPROXIMATELY 7/8". PROVIDE WEEP SCREEDS PER IRC SECTION R703.6.2.1
3. CAULK ALL EXTERIOR JOINTS & PENETRATIONS.
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5. AT NEW AND REMODELED CONSTRUCTION AREAS PROVIDE FLASHING AT ROOF PENETRATIONS PER I.R.C. R903.2 & R903.2.1.
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7. SEE SHEET A0.1 FOR ADDITIONAL NOTES.
8. LIGHTING AT EXTERIOR DOORS, TYP.
9. MATCH EXISTING SHAKE ROOF AND FINISH TO MATCH, INSTALL PER INDUSTRY STANDARDS.
10. WINDOWS: (CLIMATE ZONE 4C OF THE 2015 WSEC TABLE R402.1.1) ALL WINDOWS SHALL BE DOUBLE-PANED MINIMUM, PERFORMANCE AND CONSTRUCTION TO CONFORM WITH IRC SECTION R612. HARDWARE FINISH SHALL MATCH DOOR HARDWARE. ALL CASEMENT OPENINGS SHALL HAVE ROTO HARDWARE. ALL OPENINGS WEATHER-STRIPPED BY MANUFACTURER; GENERAL CONTRACTOR SHALL INSTALL "Z"-FLASHING AT HEADS OF ALL WINDOWS AND SEAL WINDOW PERIMETER PER MANUFACTURER'S SPECIFICATIONS.

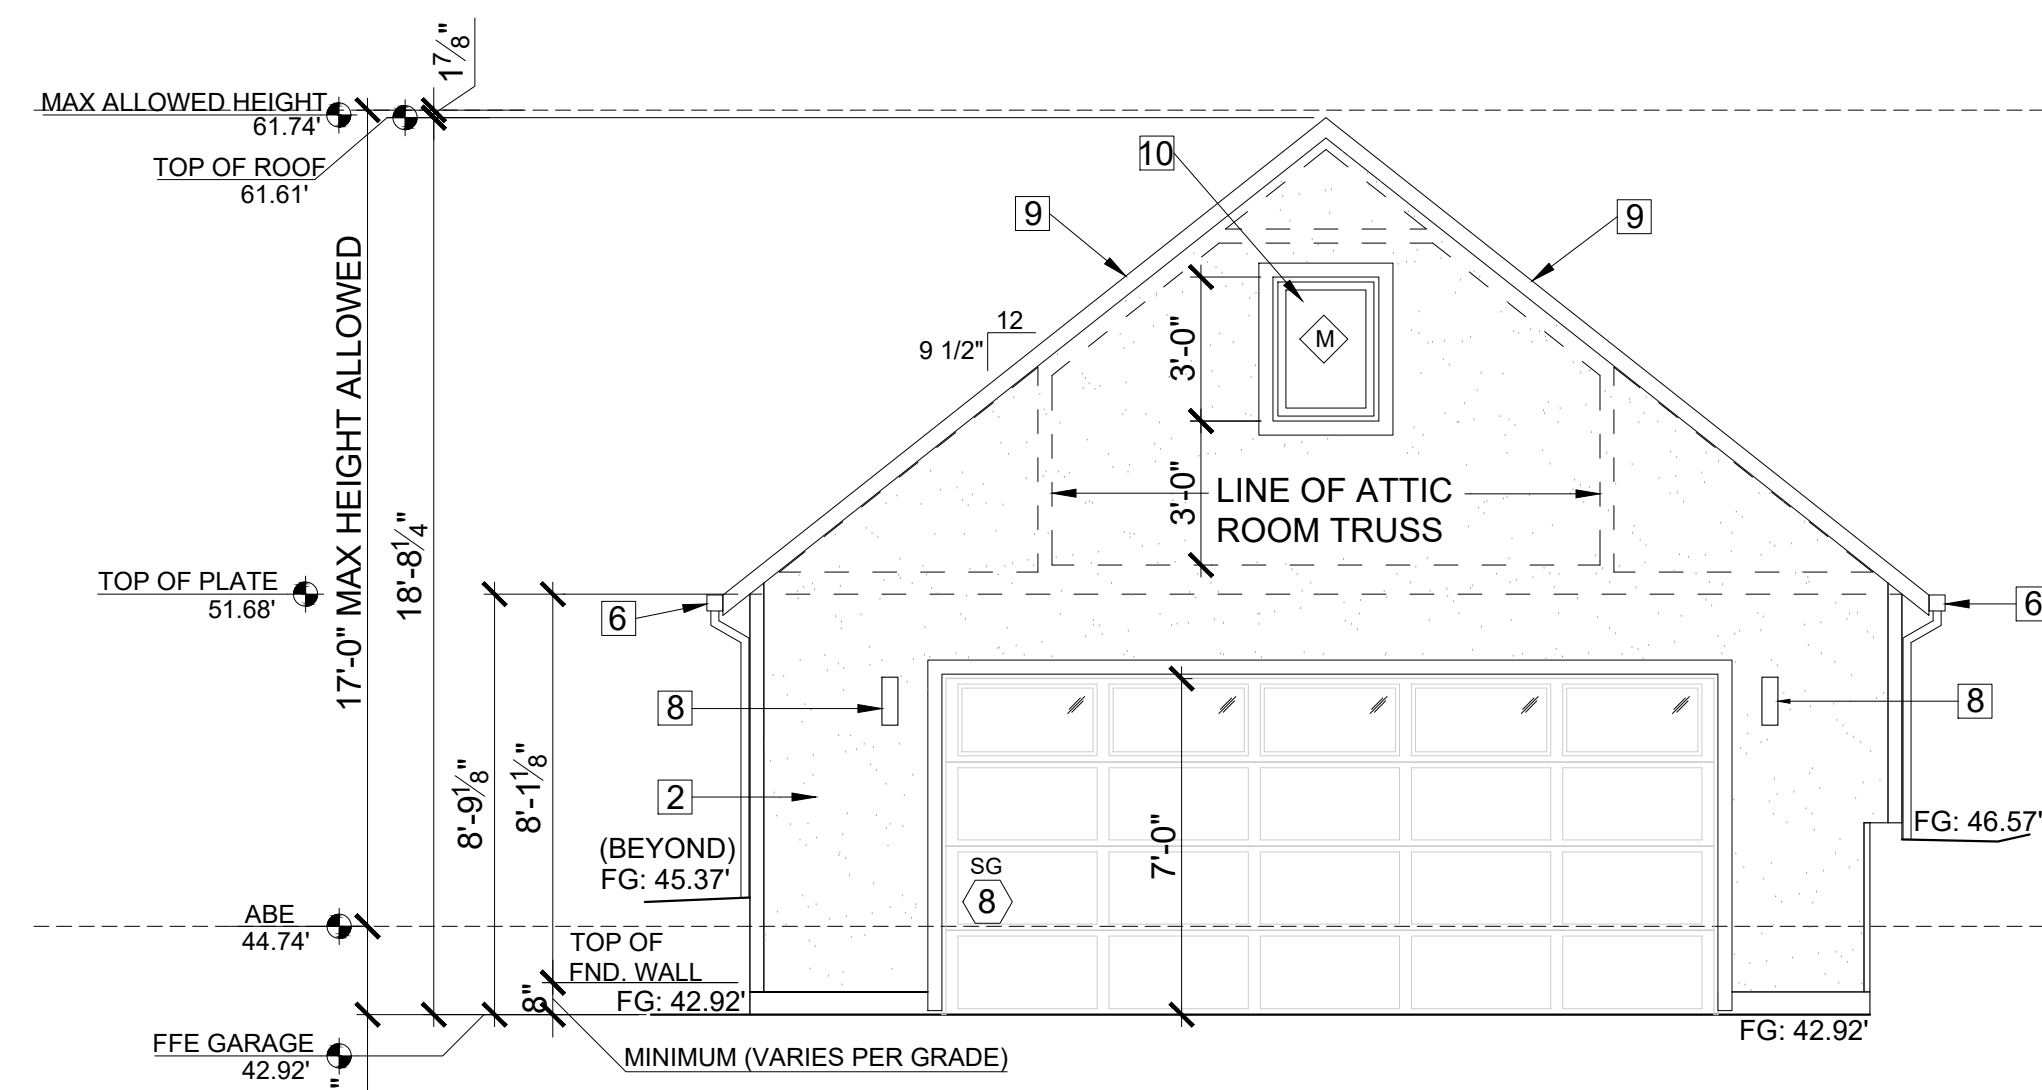


**DETACHED GARAGE PROJECT NORTH ELEVATION**  
SCALE: 1/4" = 1'-0"

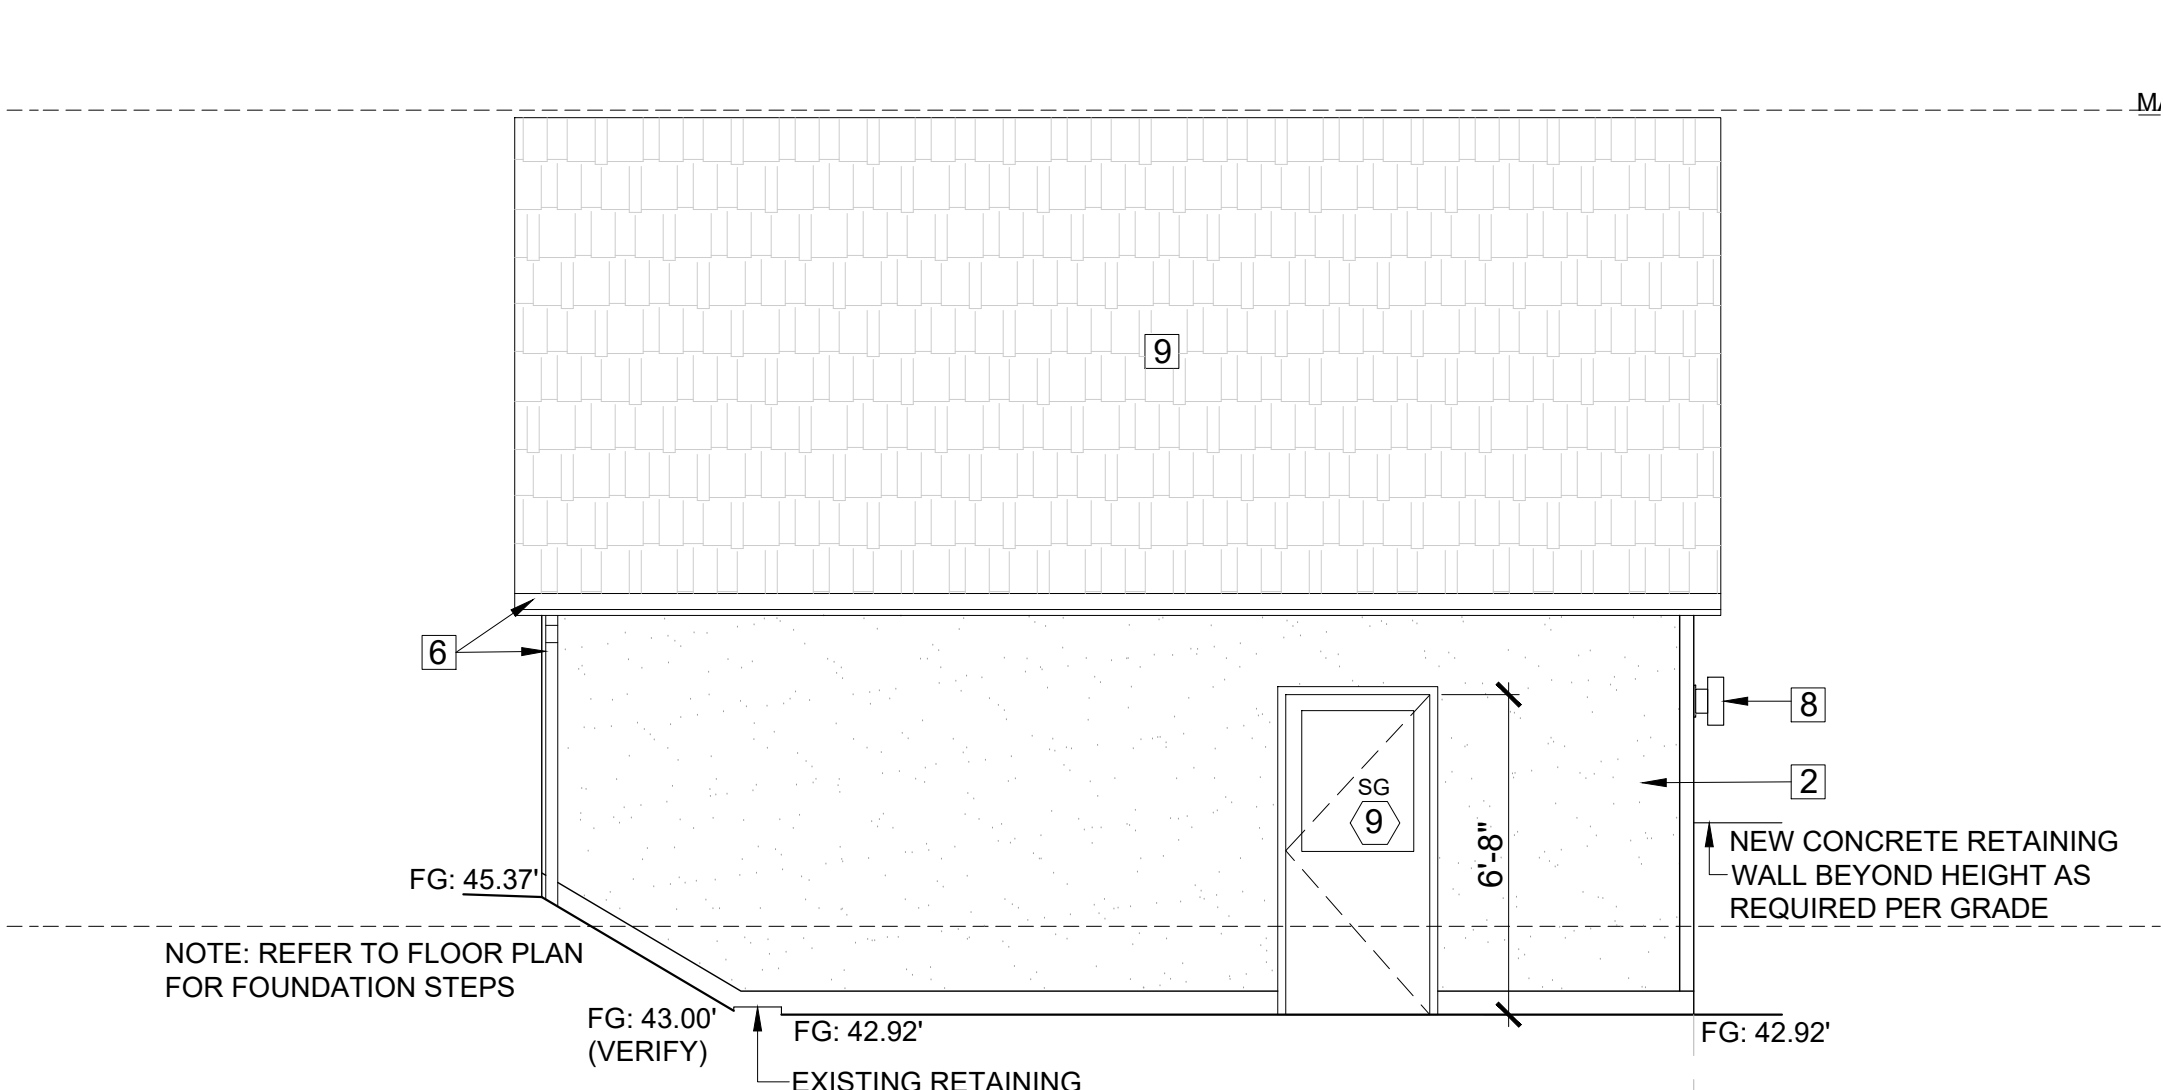


**DETACHED GARAGE PROJECT EAST ELEVATION**  
SCALE: 1/4" = 1'-0"

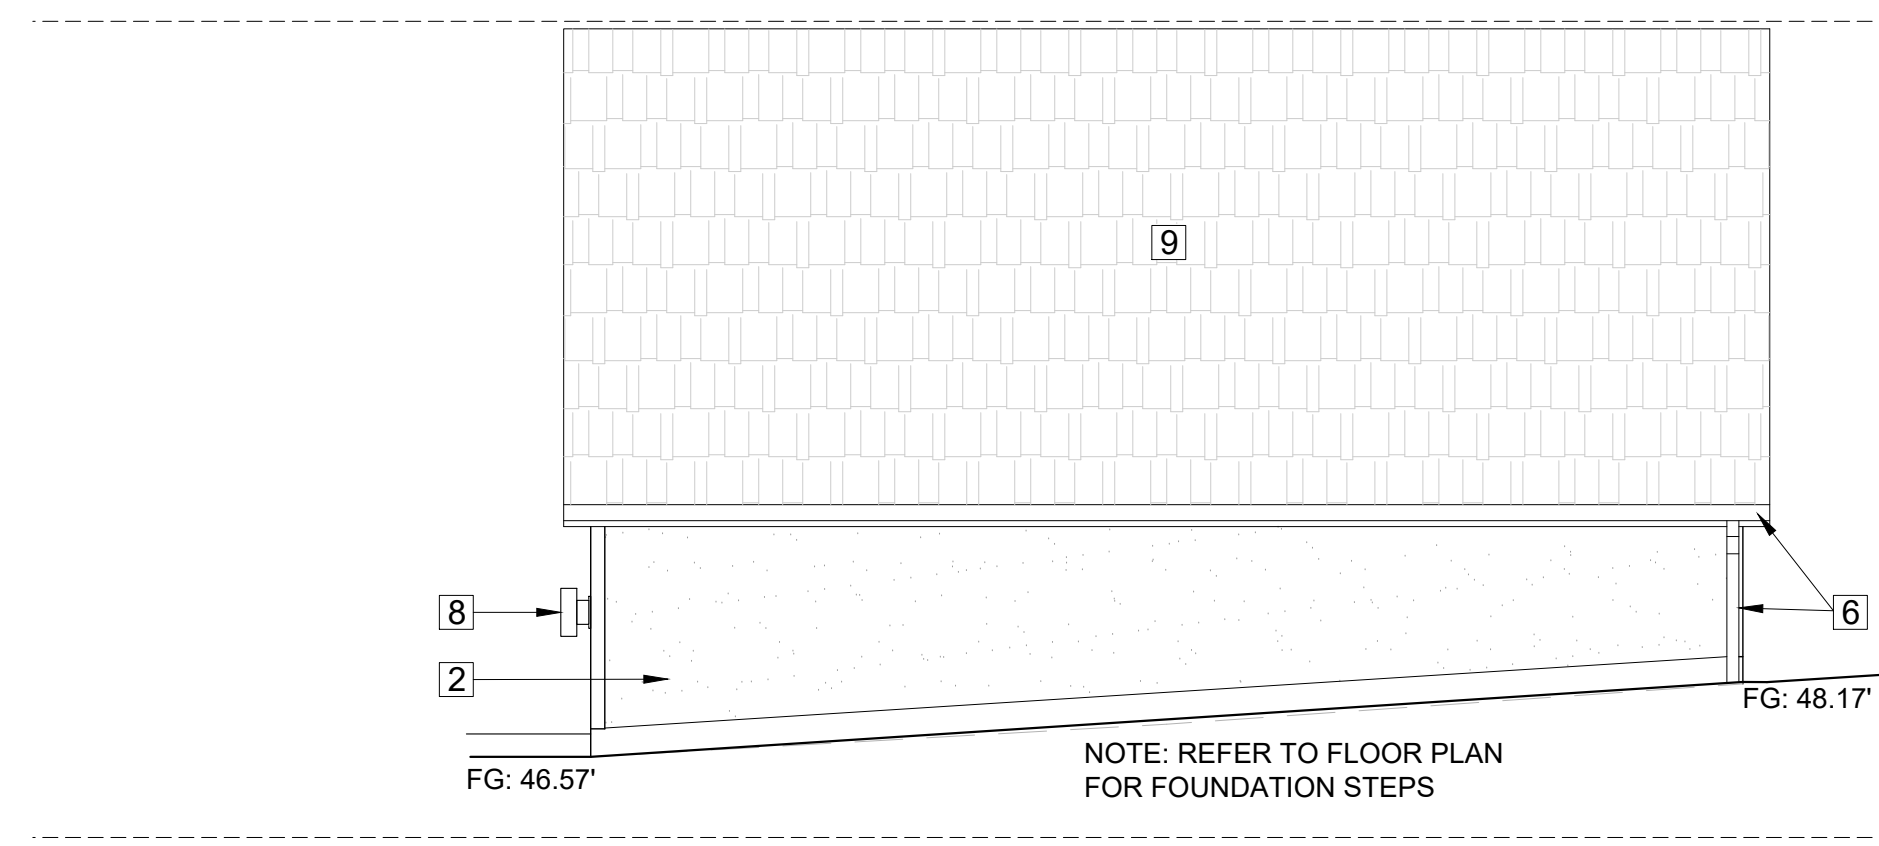


**DETACHED GARAGE PROJECT WEST ELEVATION**  
SCALE: 1/4" = 1'-0"

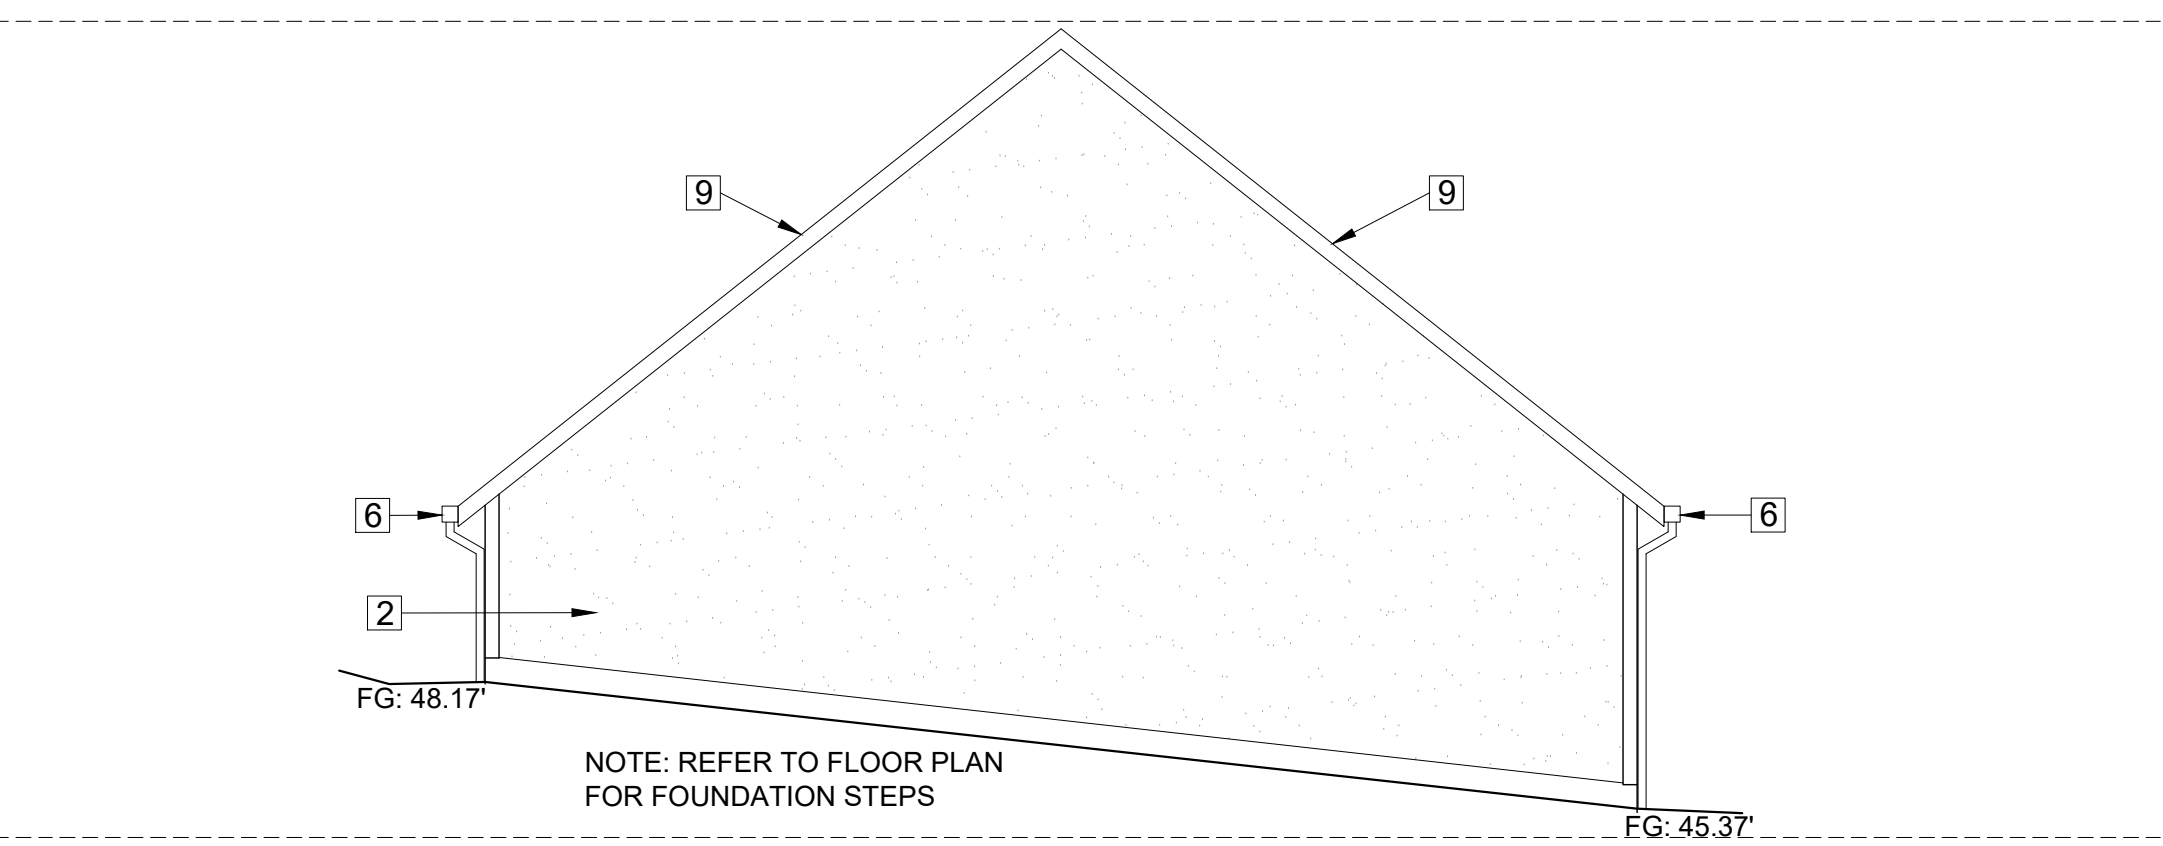


**DETACHED GARAGE PROJECT SOUTH ELEVATION**  
SCALE: 1/4" = 1'-0"

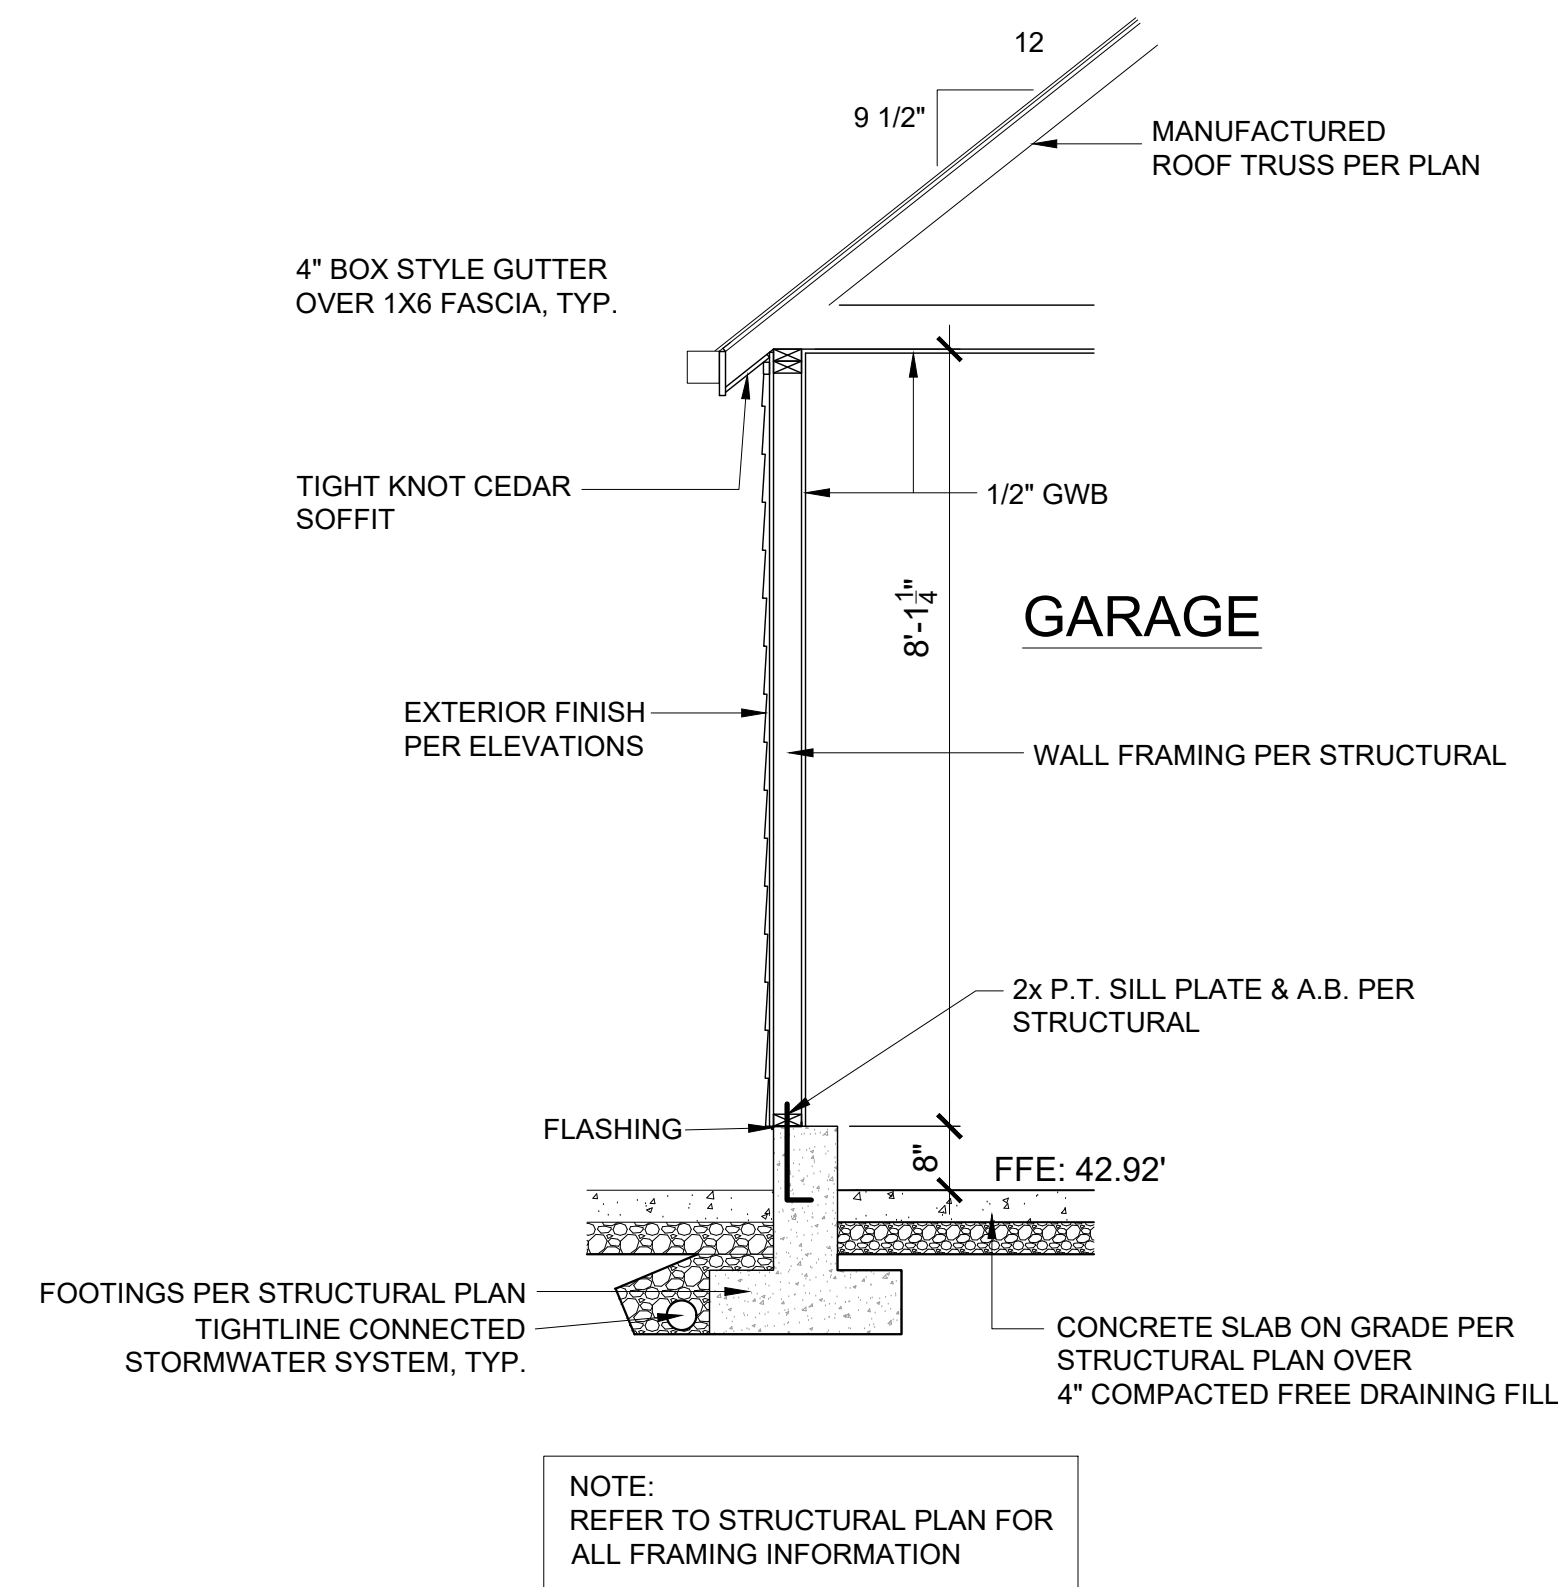

**A DETACHED GARAGE WALL SECTION**  
SCALE: 1/2" = 1'-0" @ FULL HEIGHT FRAMED WALL

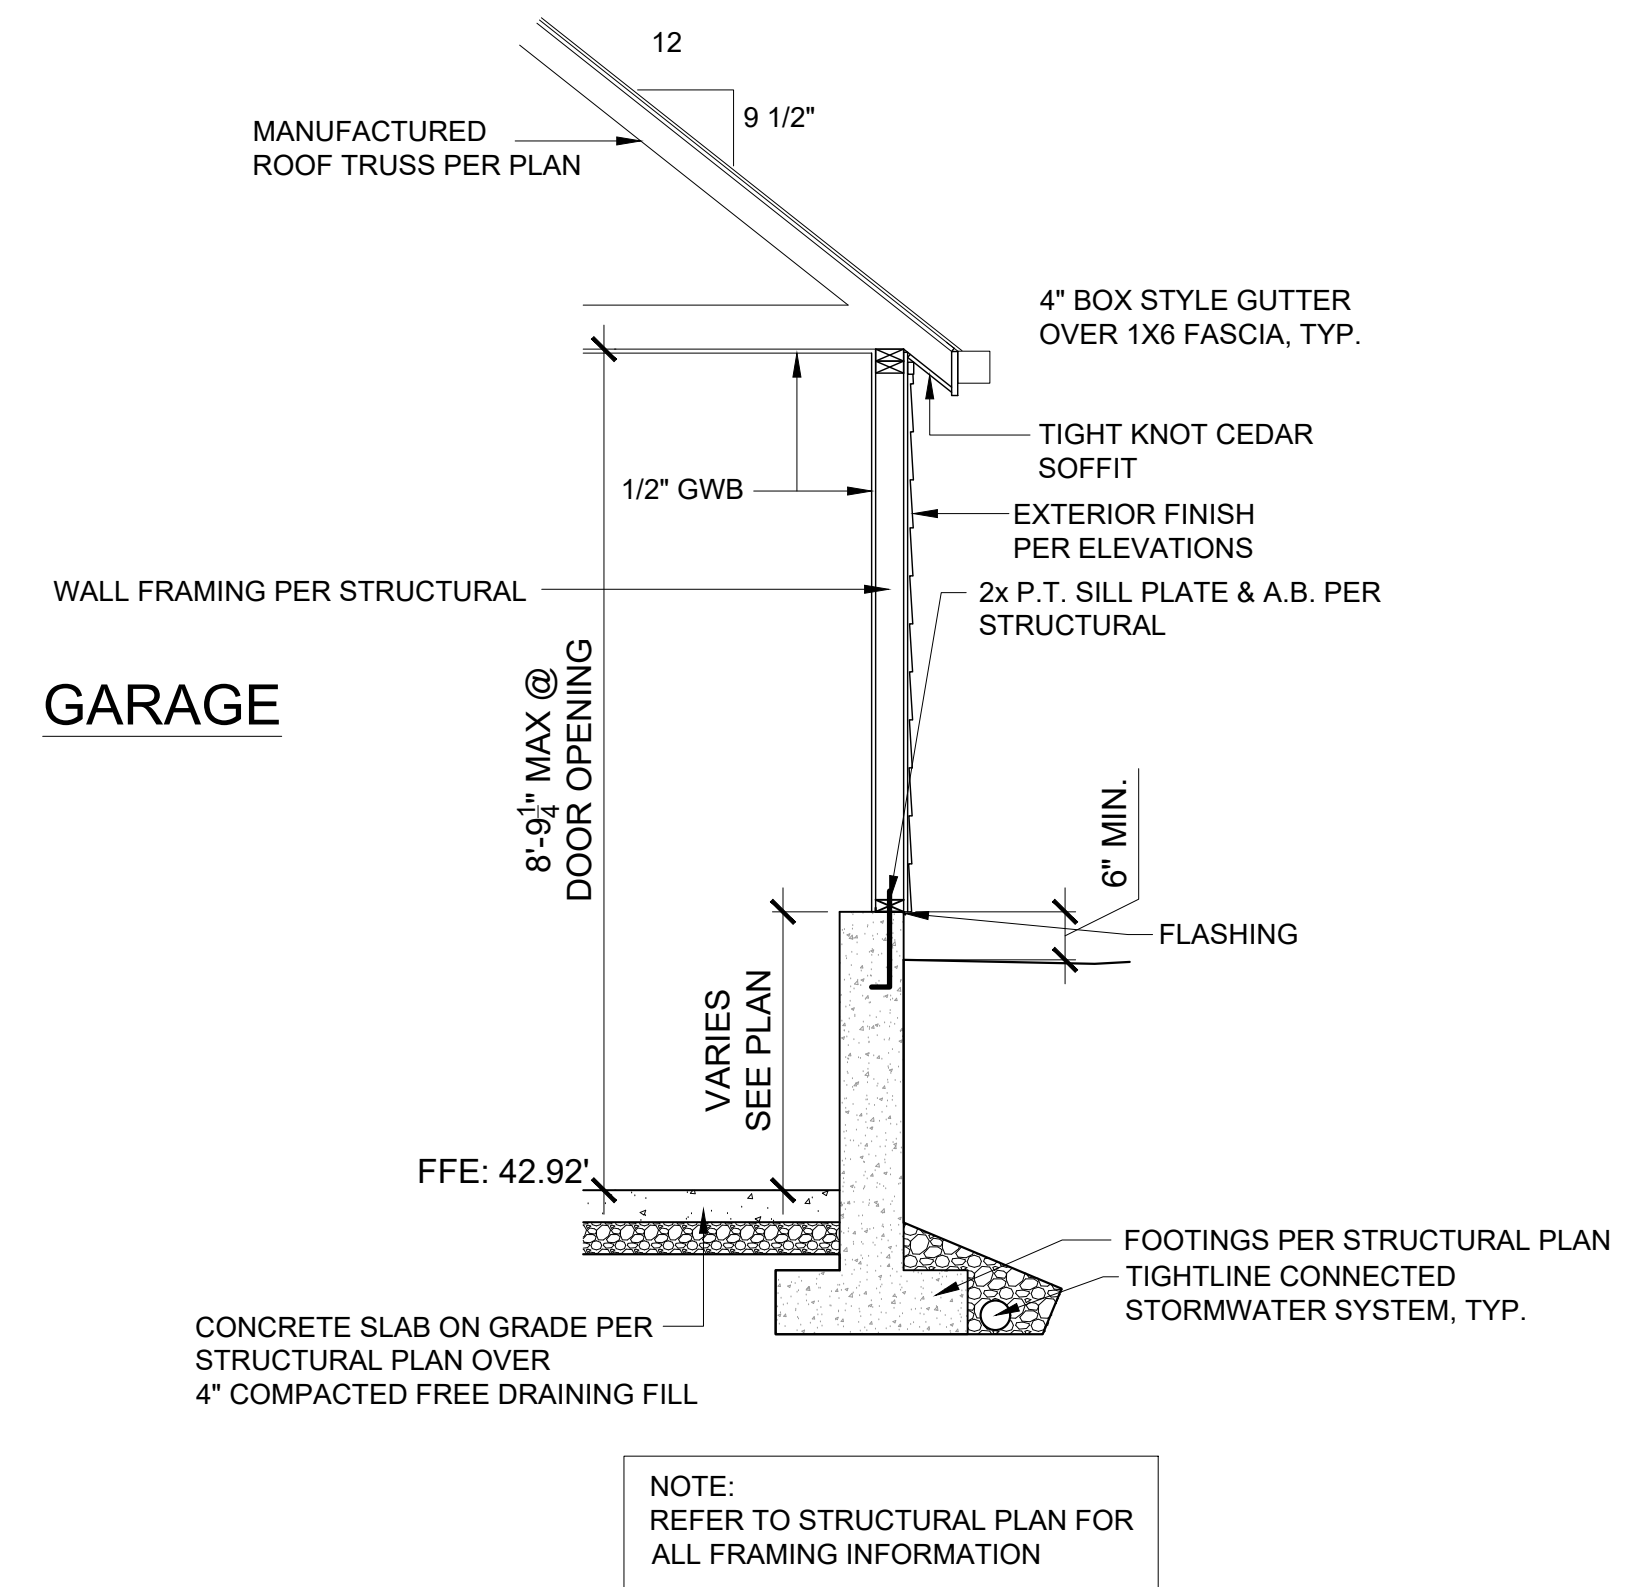

**B DETACHED GARAGE WALL SECTION**  
SCALE: 1/2" = 1'-0" @ RETAINING WALL FOUNDATION

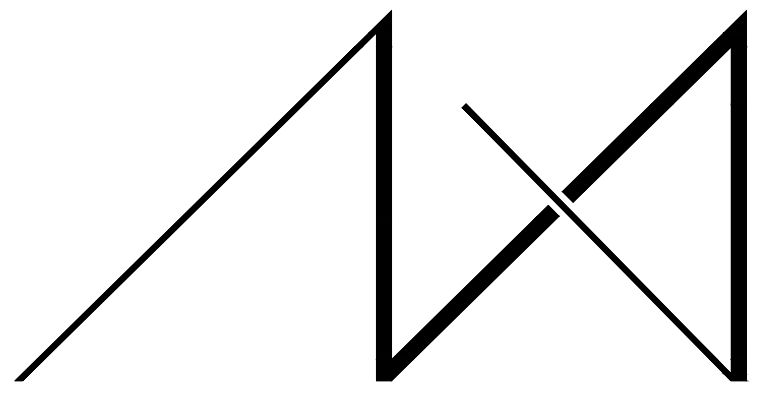

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REGISTRATION:



INTAKE: DATE:

REVISIONS:	DATE:
1.	
2.	
3.	
4.	
5.	

PROJECT / CLIENT:

**9820 SE 35TH PLACE**  
ACHIN & MARY CHEN  
9820 SE 35TH PLACE  
MERCER ISLAND, WA 98040

JOB ADDRESS:

9820 SE 35TH PLACE  
MERCER ISLAND, WA 98040  
**PARCEL # 082405-9027**

DRAWING NAME:

**DETACHED GARAGE ELEVATIONS**

Drawn By: JMG, RB  
Checked By: EB  
Owner Approval:

PHASE:

**CONSTRUCTION DOCUMENTS**

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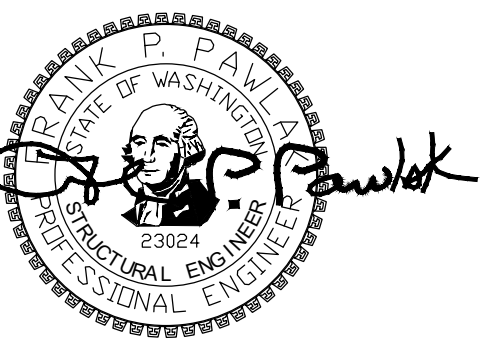
APPROVED FOR CONSTRUCTION:

PROJECT No.: 2020 007  
DATE: 12-22-2020

PLOT SCALE: 1:1


**A7.1**





PROJECT

9820 SE 35TH PLACE  
 ACHIN & MARY CHEN  
 9820 SE 35TH PL  
 MERCER ISLAND, WA 98040

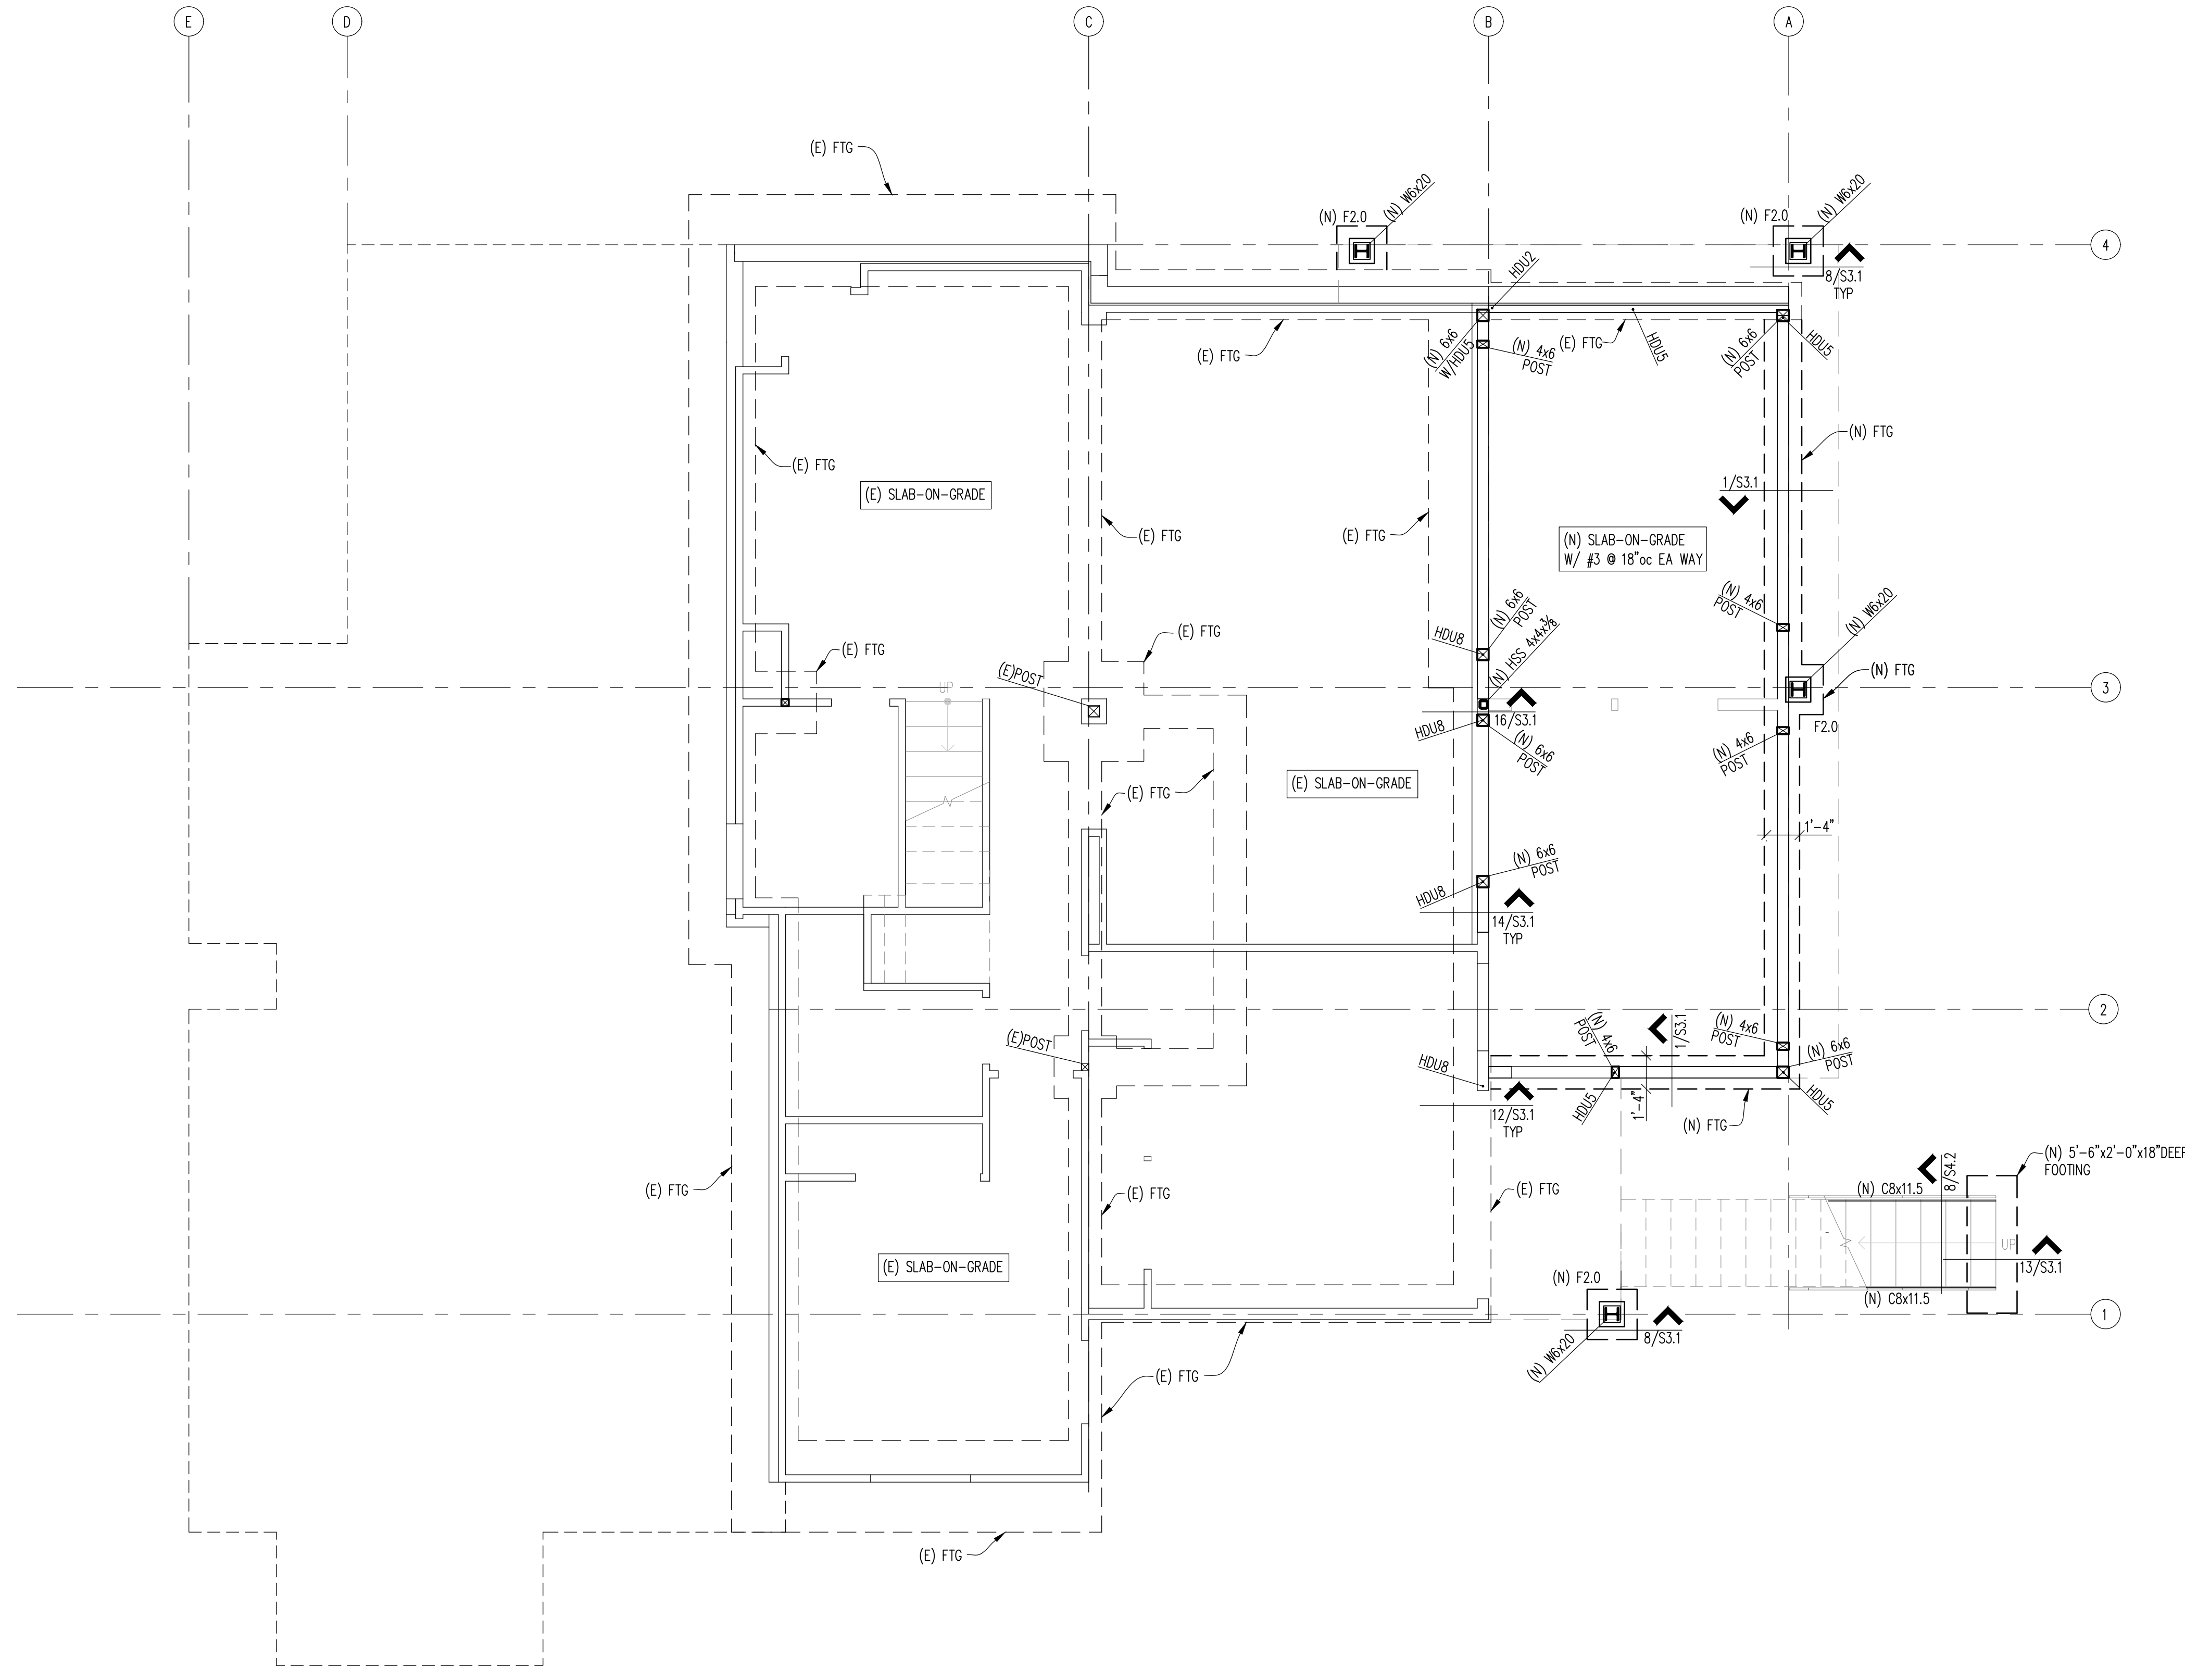

- NOTES:  
 1. F2.X DENOTES FOOTING SIZE - FOOTING SCHEDULE.  
 F2.0 IS 2'-0"x2'-0"x12" DEEP W/ (3) #5 EA WAY BOT  
 2. SEE ARCH FOR DIMENSIONS.  
 3. SEE ARCH FOR INSULATION BELOW SLAB-ON-GRADE, IF APPLICABLE.  
 4. WALLS SHOWN ARE BASEMENT LEVEL WALLS.  
 5. SEE SHEETS S3.X FOR CONCRETE DETAILS.  
 6. - INDICATES HOLD-DOWN TYPE, SEE 10/S4.1 FOR HOLD-DOWN SCHEDULE.  
 7. SEE SHEET S2.2 FOR BASEMENT SHEARWALL LOCATIONS.

REVISIONS	
NO.	DATE
1	11-4-20 PERMIT

11/4/20	20-129
DATE	JOB #
AM	FPP
DESIGN	CHECKED
LMS	AS NOTED
DRAWN	SCALE


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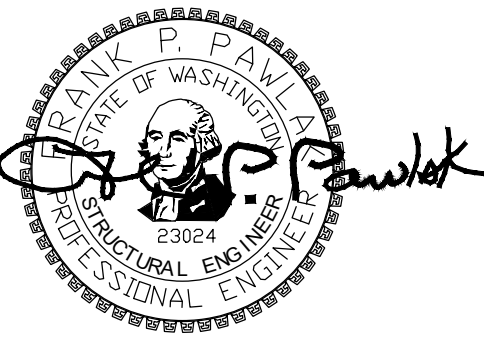
SHEET TITLE

FOUNDATION PLAN

SHEET NO.



S2.1



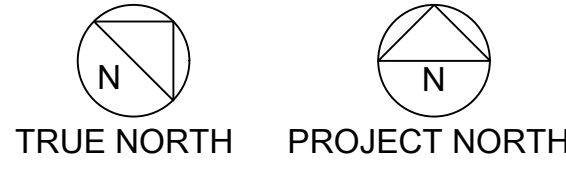

PROJECT

9820 SE 35TH PLACE  
 ACHIN & MARY CHEN  
 9820 SE 35TH PL  
 MERCER ISLAND, WA 98040

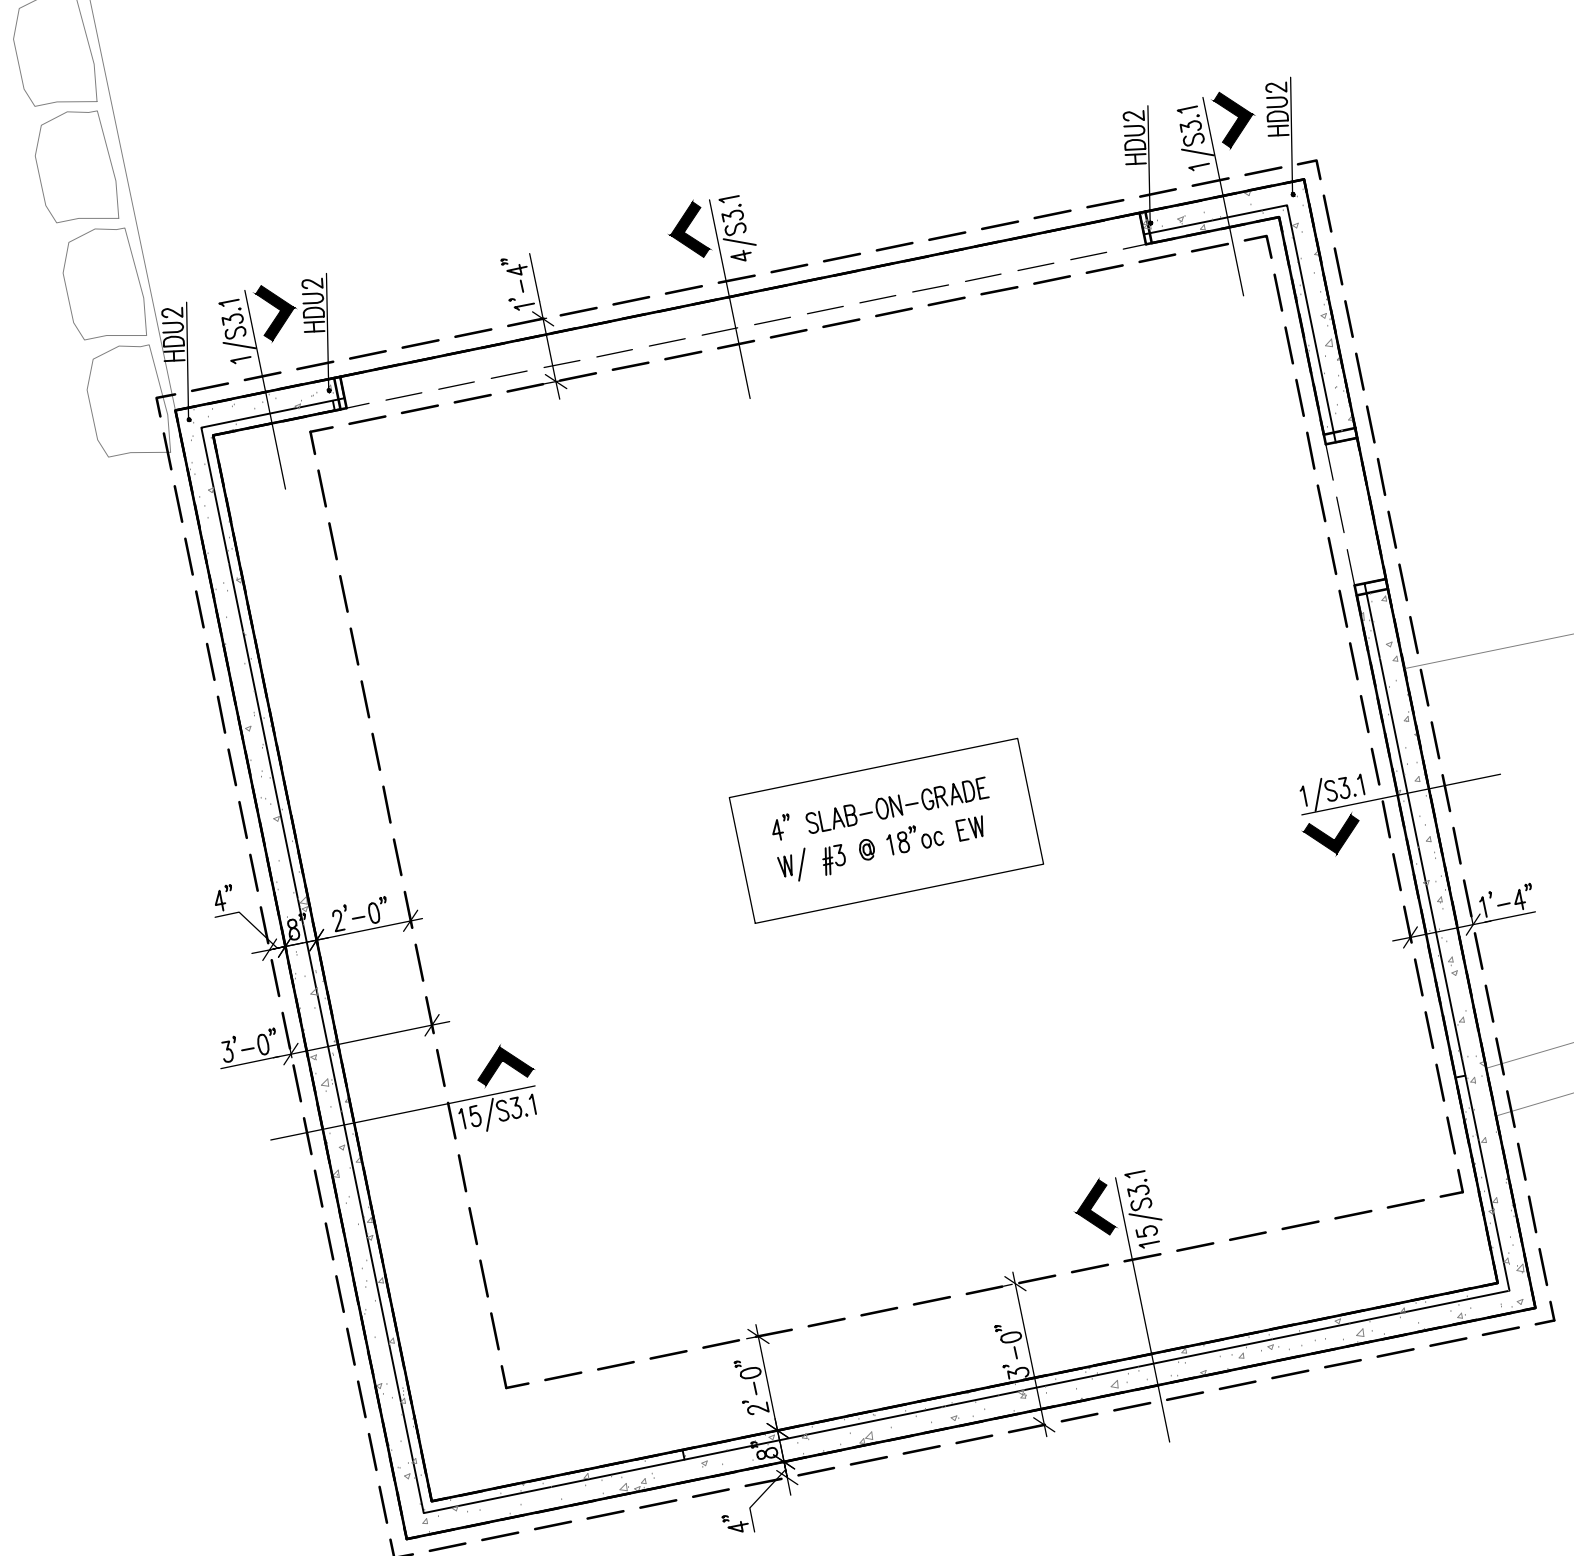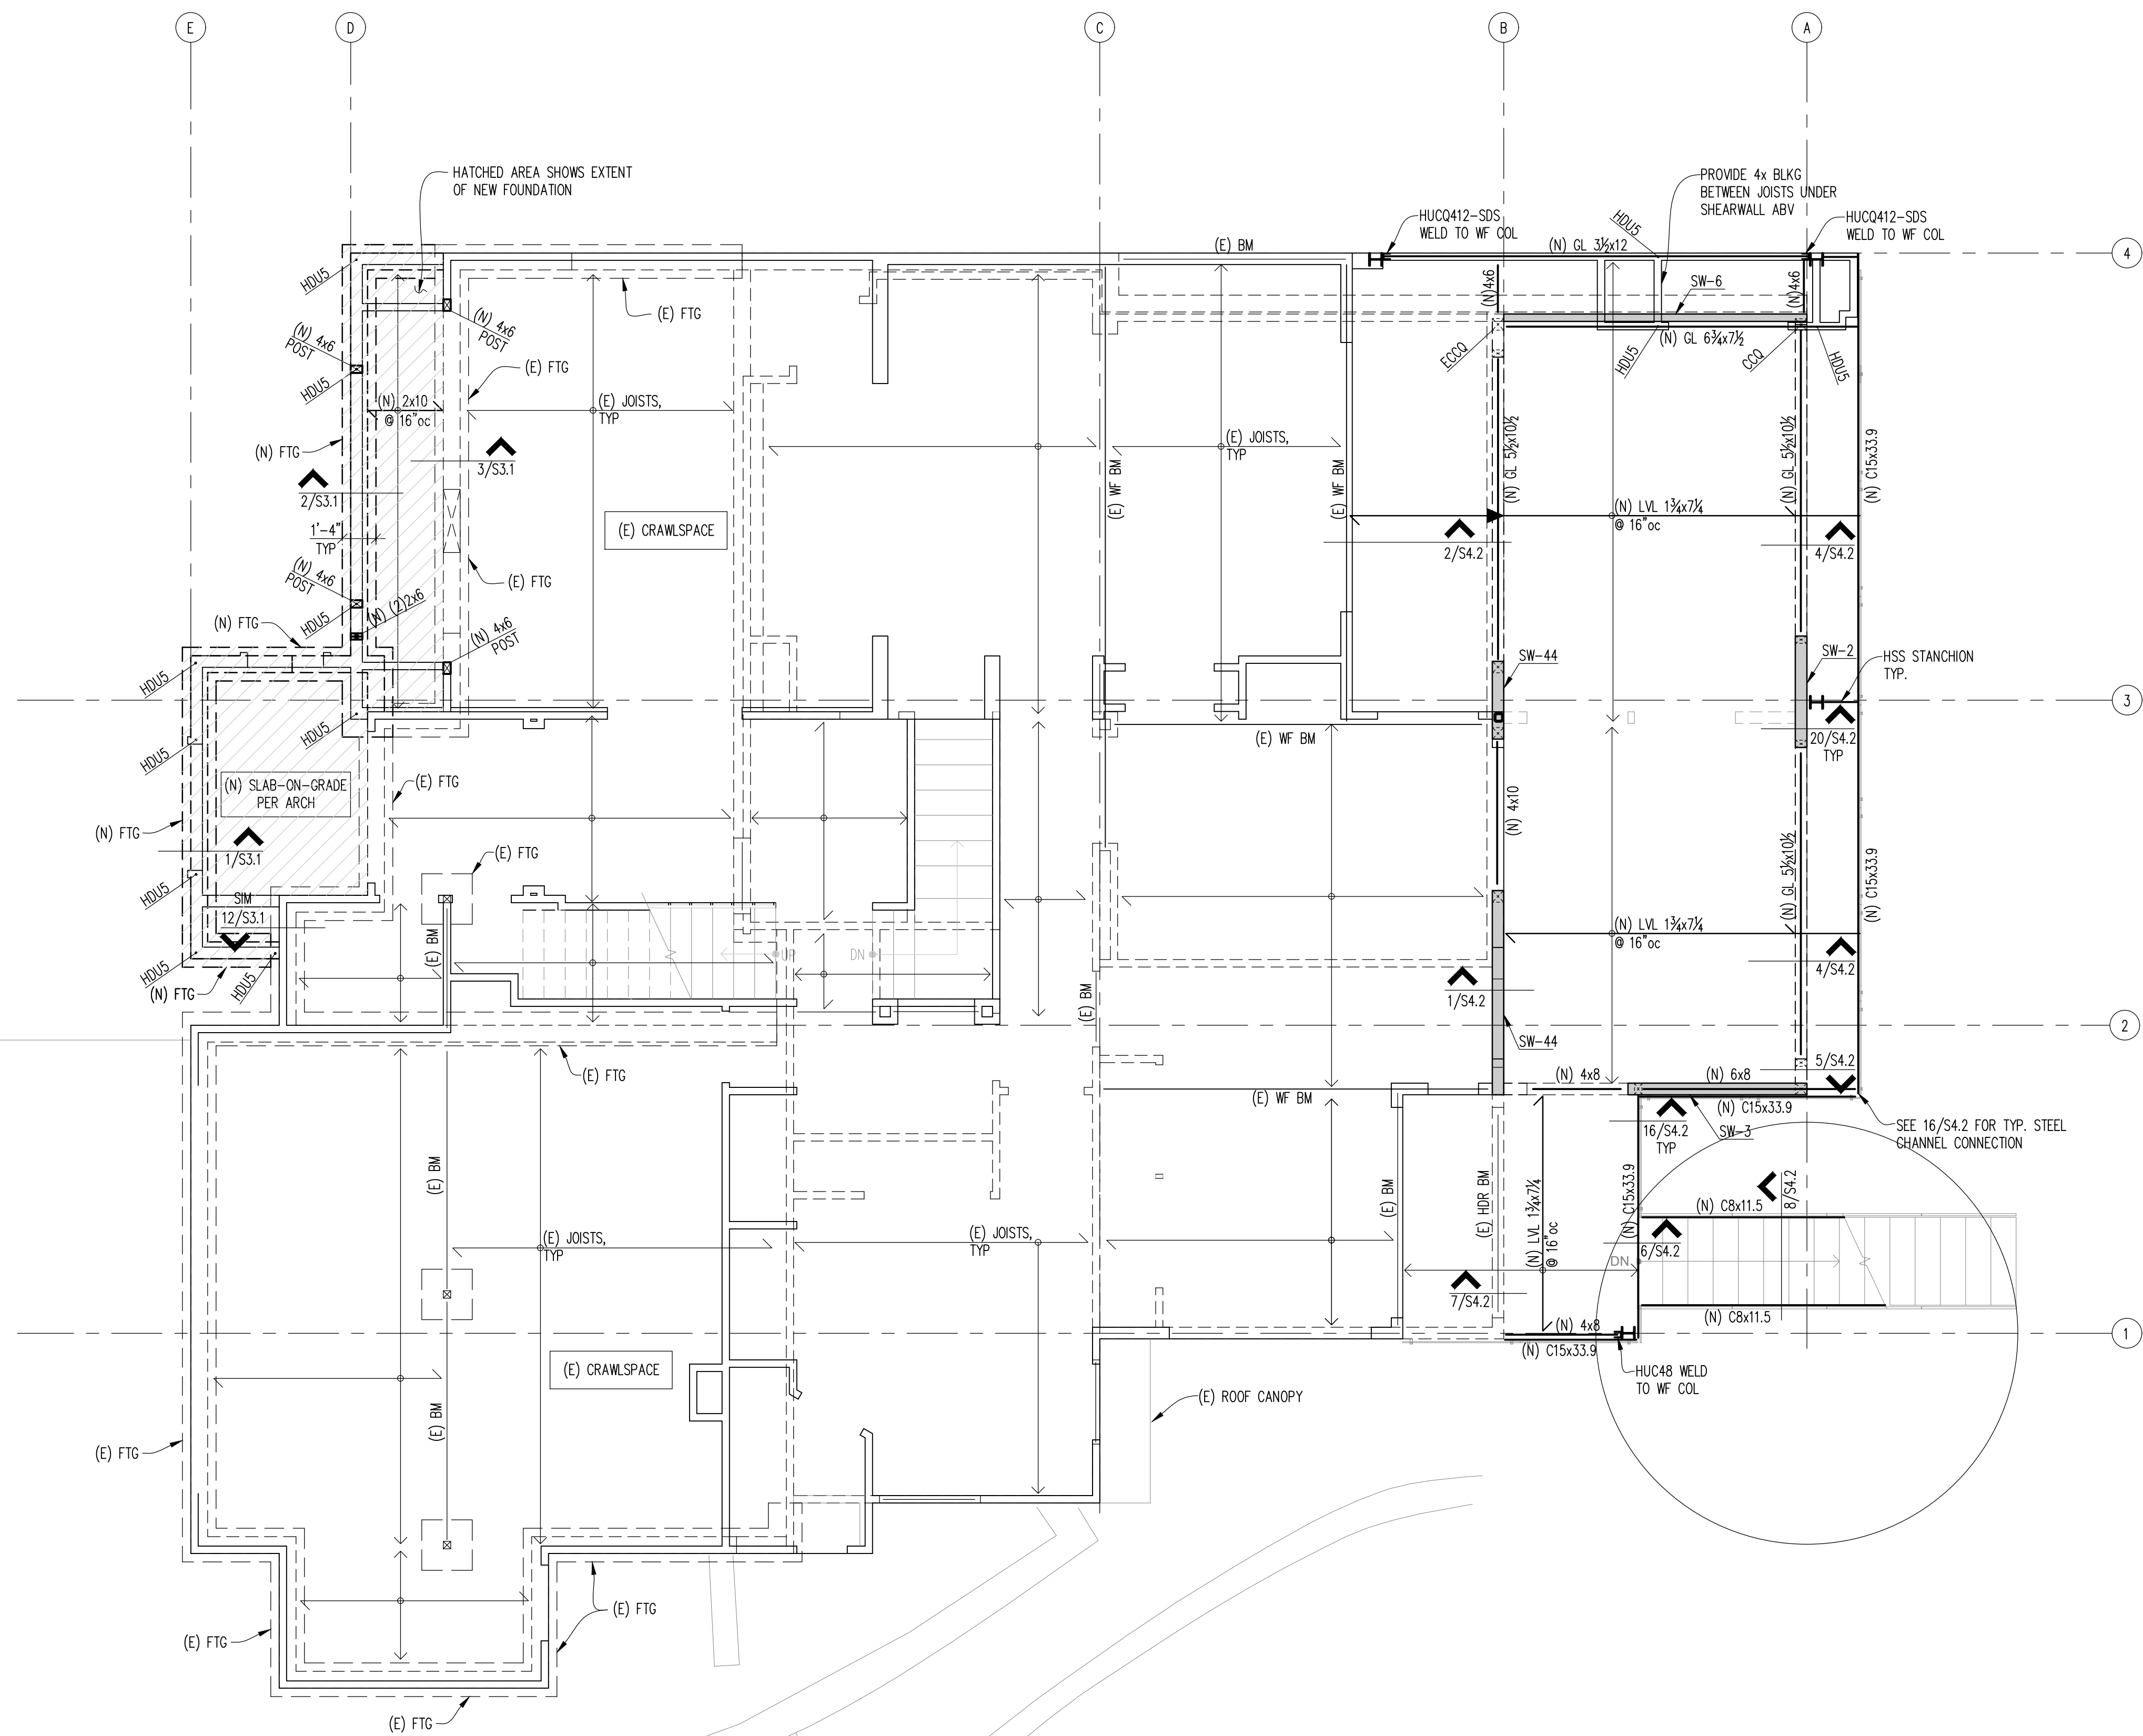

- NOTES:  
 1. WALLS SHOWN IN HIDDEN ARE ON LEVEL BELOW (BASEMENT LEVEL). WALLS SHOWN IN SOLID ARE ON 1ST FLOOR.  
 2. SEE ARCH FOR DIMENSIONS.  
 3. SEE SHEET S4.X FOR TYPICAL WOOD FRAMING DETAILS. SEE SHEET S3.X FOR CONCRETE DETAILS.  
 4. STAGGER JOISTS AT ALL BEARING WALLS FOR FULL BEARING.  
 5. ALL HEADERS TO BE 4x8, UNO ON PLANS.  
 6. SW-X, INDICATES SHEAR WALL TYPE, SEE 9/S4.1 FOR SW SCHEDULE.  
 7. X- INDICATES HOLD-DOWN TYPE, SEE 10/S4.1 FOR HOLD-DOWN SCHEDULE.  
 8. INDICATES SHEAR WALLS.  
 9. INDICATES INTERMEDIATE BEARING POINT.

REVISIONS

NO.	DATE	DESCRIPTION
1	11-4-20	PERMIT

11/4/20	20-129
DATE	JOB #
AM	FPF
DESIGN	CHECKED
LMS	AS NOTED
DRAWN	SCALE


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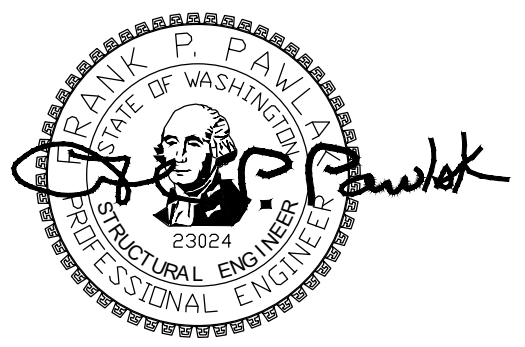
1ST FLOOR  
 FRAMING  
 PLAN

SHEET NO.

S2.2





1ST FLOOR FRAMING PLAN

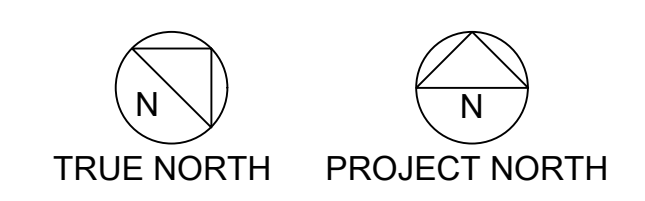

PROJECT

9820 SE 35TH PLACE  
 ACHIN & MARY CHEN  
 9820 SE 35TH PL  
 MERCER ISLAND, WA 98040

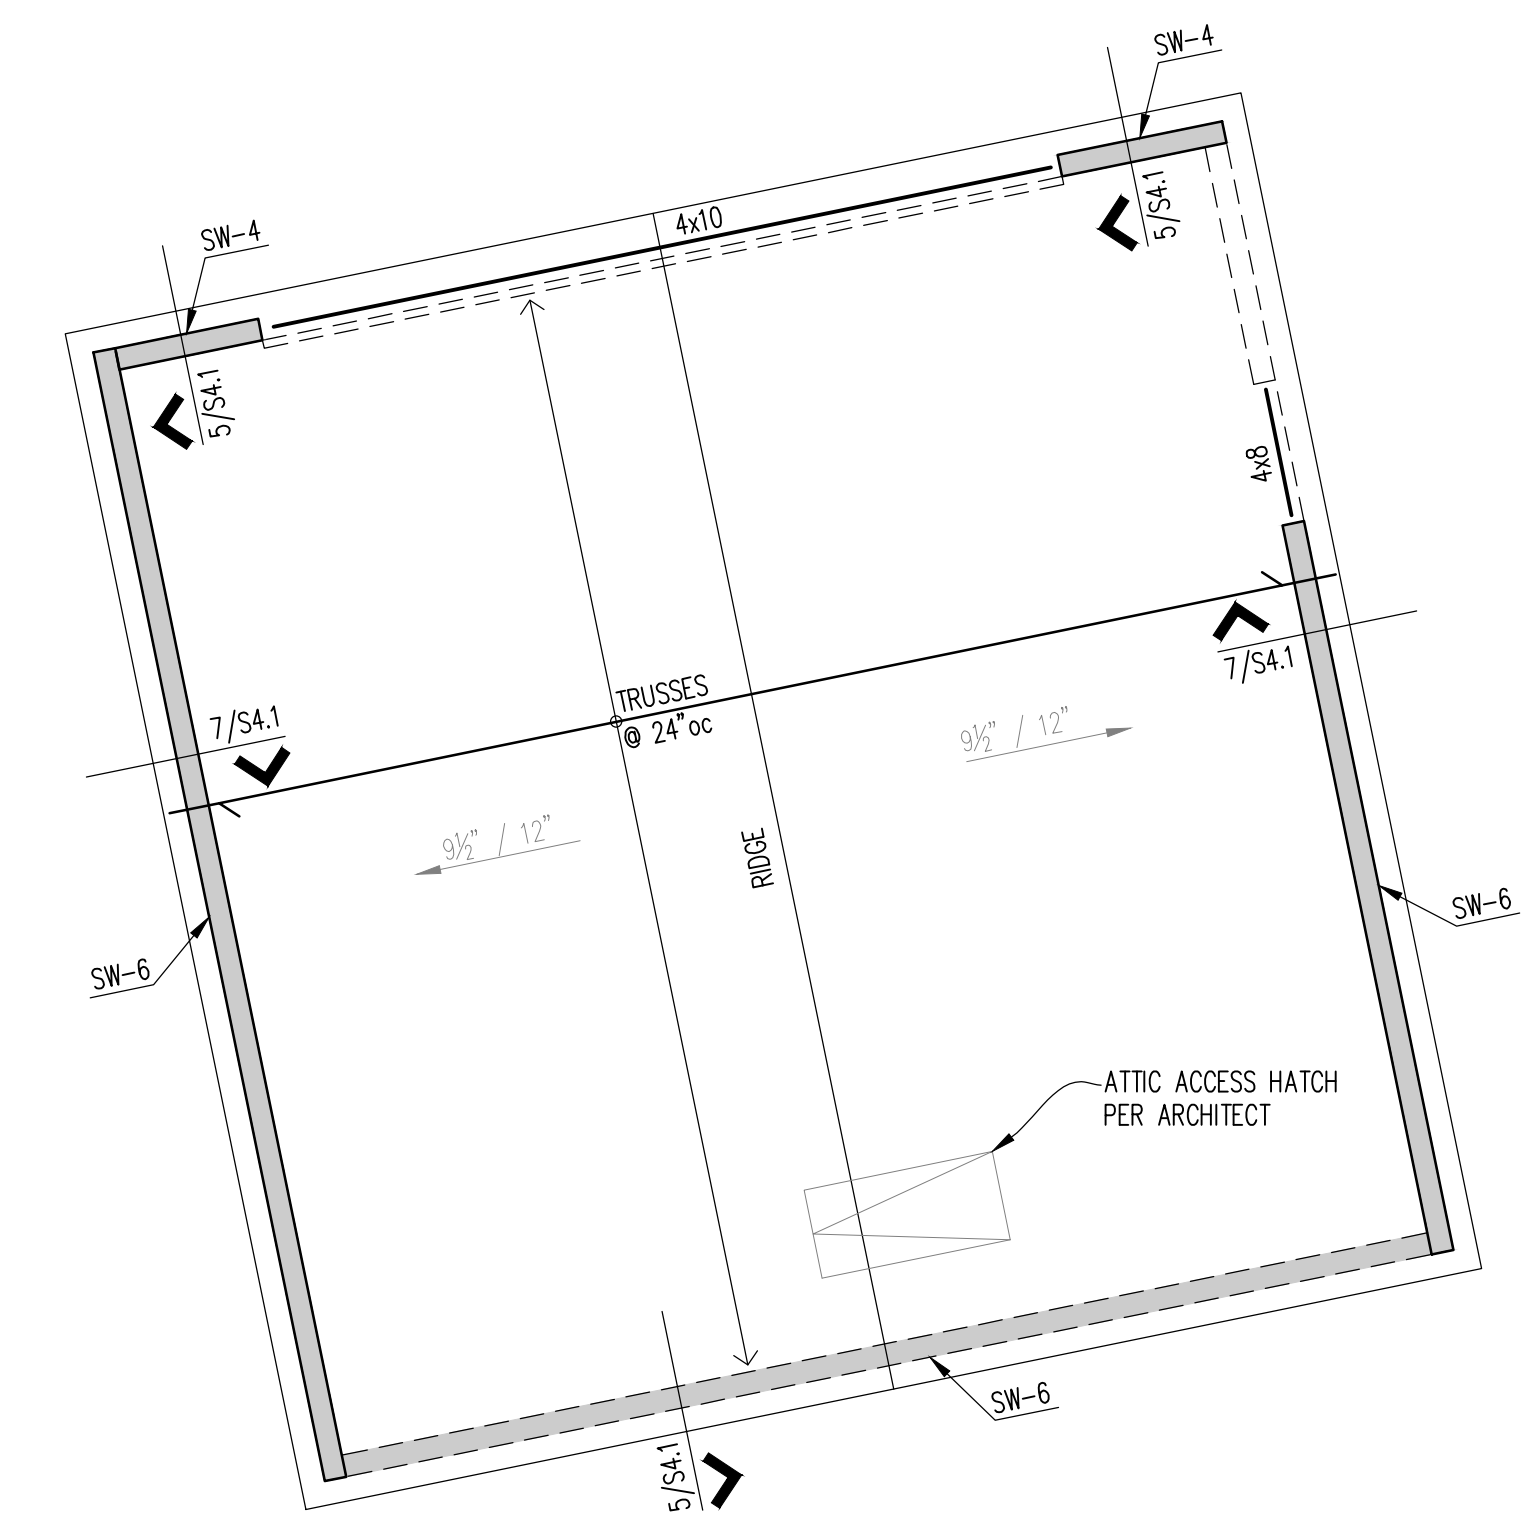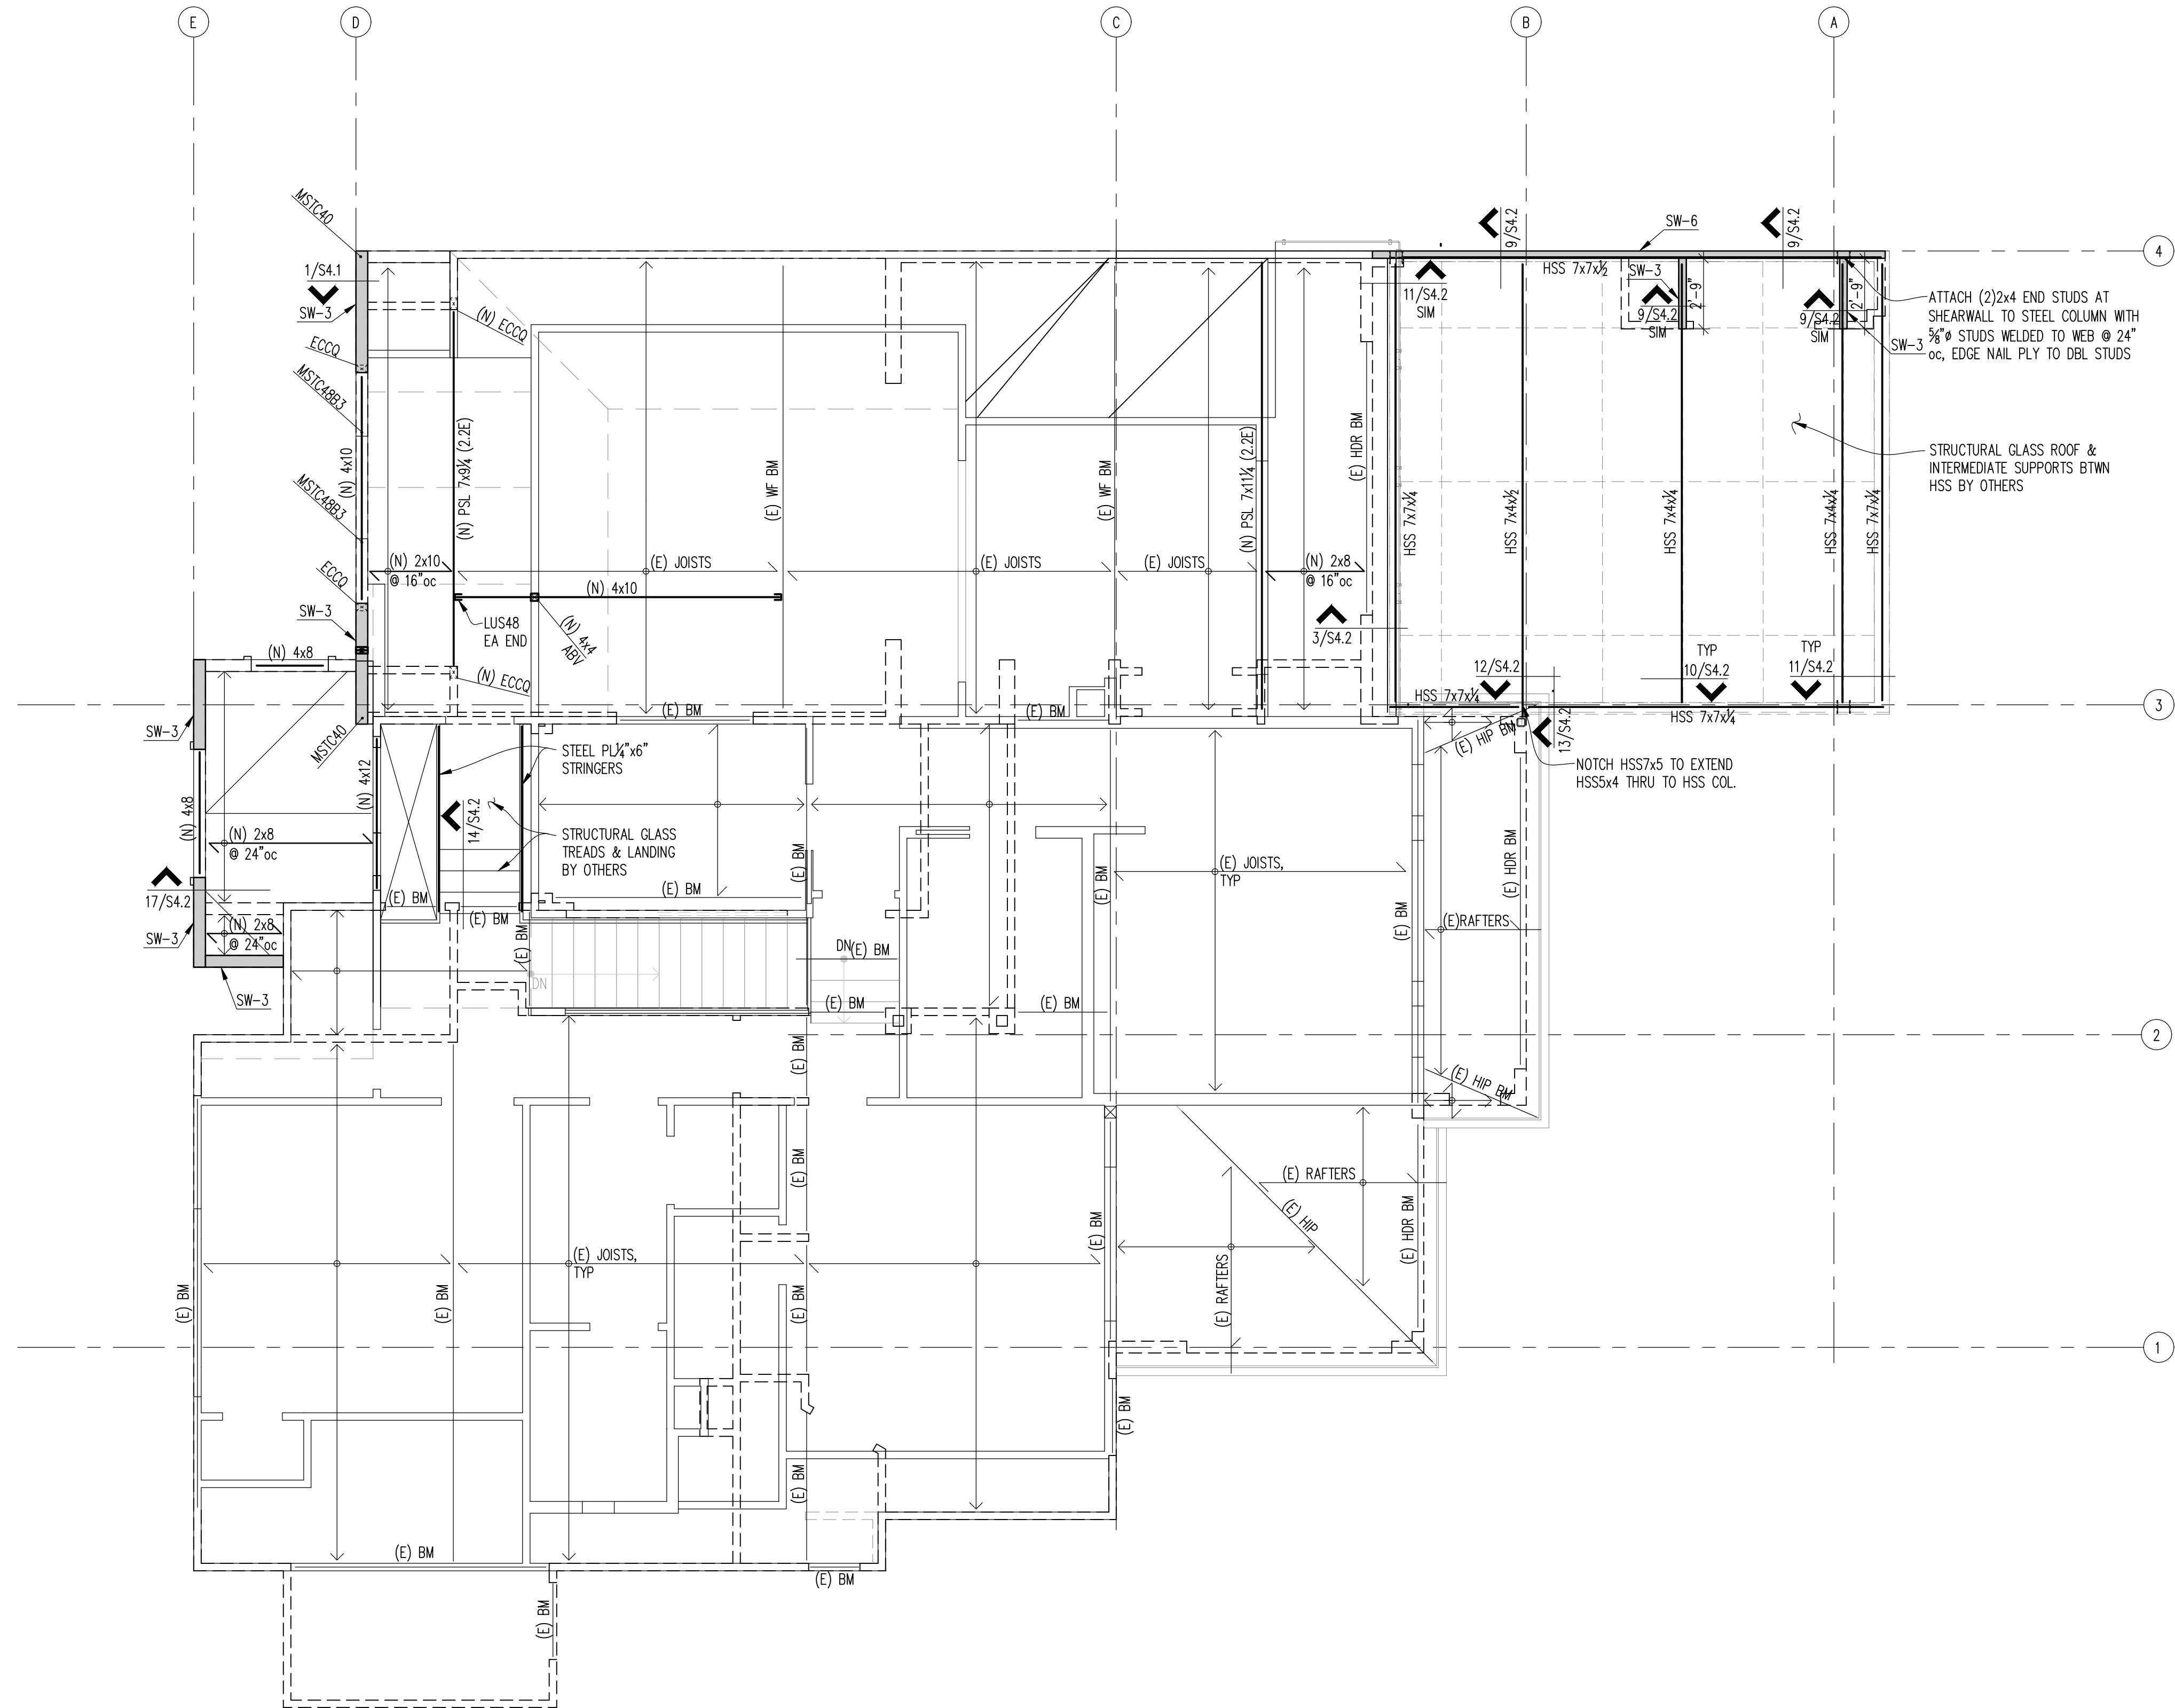

- NOTES:
1. WALLS SHOWN IN HIDDEN ARE ON LEVEL BELOW (FIRST FLOOR). WALLS SHOWN IN SOLID ARE ON SECOND FLOOR.
  2. SEE ARCH FOR DIMENSIONS.
  3. SEE SHEET S4.X FOR TYPICAL WOOD FRAMING DETAILS.
  4. STAGGER JOISTS AT ALL BEARING WALLS FOR FULL BEARING.
  5. ALL HEADERS TO BE 4x6, UNO ON PLANS.
  6. SW-X INDICATES SHEAR WALL TYPE. SEE 9/S4.1 FOR SW SCHEDULE.
  7. <img alt="holdown symbol" data-bbox="665 725 675 735"/> INDICATES HOLDOWN TYPE. SEE 10/S4.1 FOR HOLDOWN SCHEDULE.
  8. <img alt="shear wall symbol" data-bbox="665 735 675 745"/> INDICATES SHEAR WALLS.
  9. <img alt="bearing point symbol" data-bbox="665 745 675 755"/> INDICATES INTERMEDIATE BEARING POINT.

NO.	DATE	DESCRIPTION
1	11-4-20	PERMIT

11/4/20	20-129
DATE	JOB #
AM	FPP
DESIGN	CHECKED
LMS	AS NOTED
DRAWN	SCALE


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SHEET TITLE


2ND FLOOR  
 FRAMING  
 PLAN

SHEET NO.

S2.3



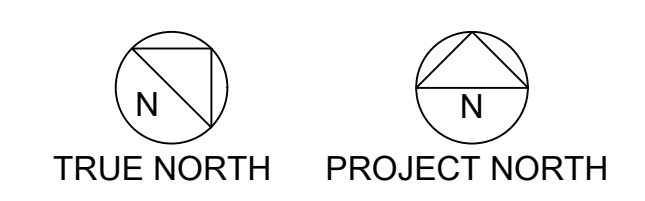

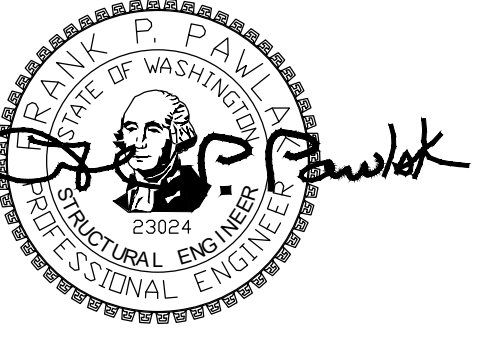

9820 SE 35TH PLACE  
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NO.	DATE	DESCRIPTION
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DATE	JOB #
AM	FPP
DESIGN	CHECKED
LMS	AS NOTED
DRAWN	SCALE


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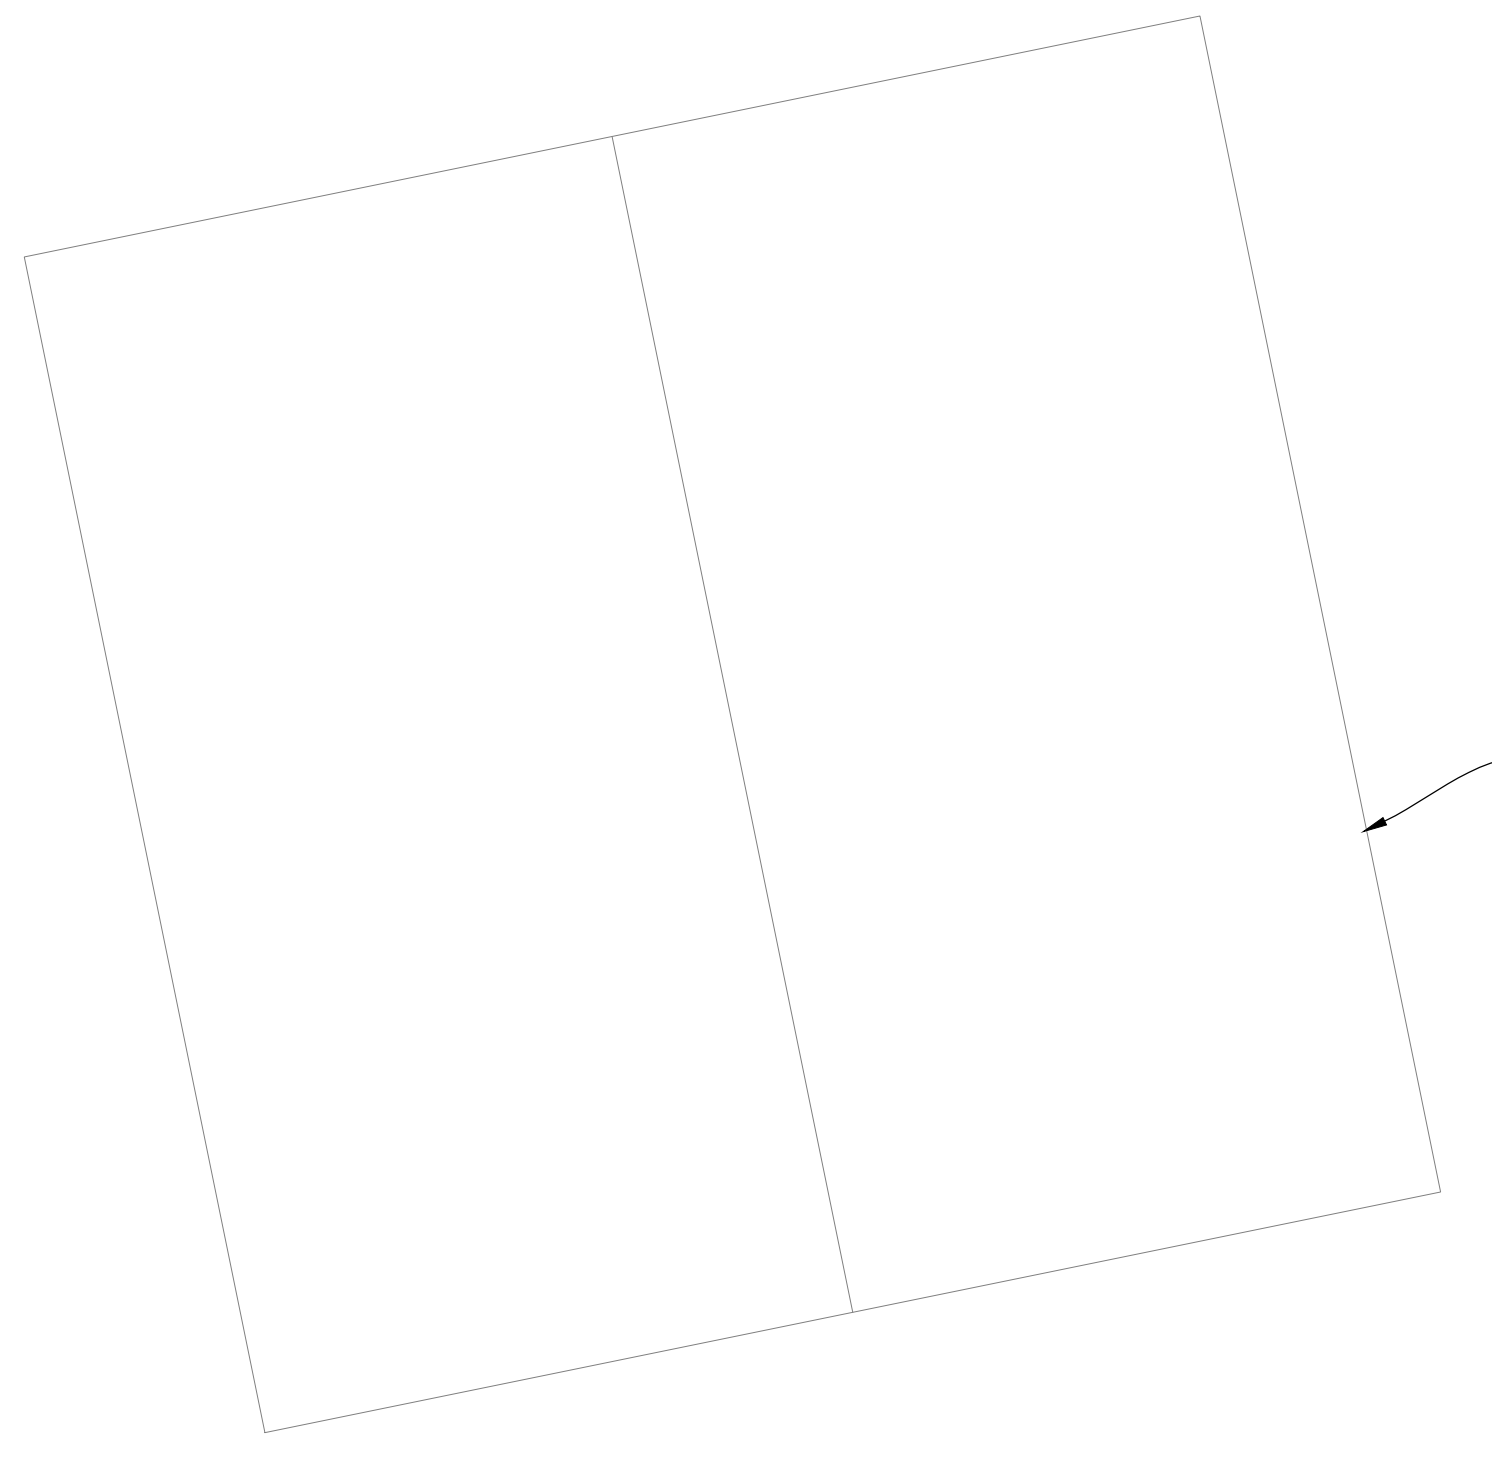
**ROOF FRAMING PLAN**

SHEET NO.


**S2.4**




- NOTES:**
1. WALLS SHOWN ARE ON LEVEL BELOW (SECOND FLOOR).
  2. SEE ARCH FOR DIMENSIONS.
  3. SEE SHEET S4.X FOR TYPICAL WOOD FRAMING DETAILS.
  4. STAGGER JOISTS AT ALL BEARING WALLS FOR FULL BEARING.
  5. ALL HEADERS TO BE 4x8, UNO ON PLANS.
  6. SW-X INDICATES SHEAR WALL TYPE, SEE 9/S4.1 FOR SW SCHEDULE.
  7. INDICATES SHEAR WALLS.
  8. INDICATES INTERMEDIATE BEARING POINT.

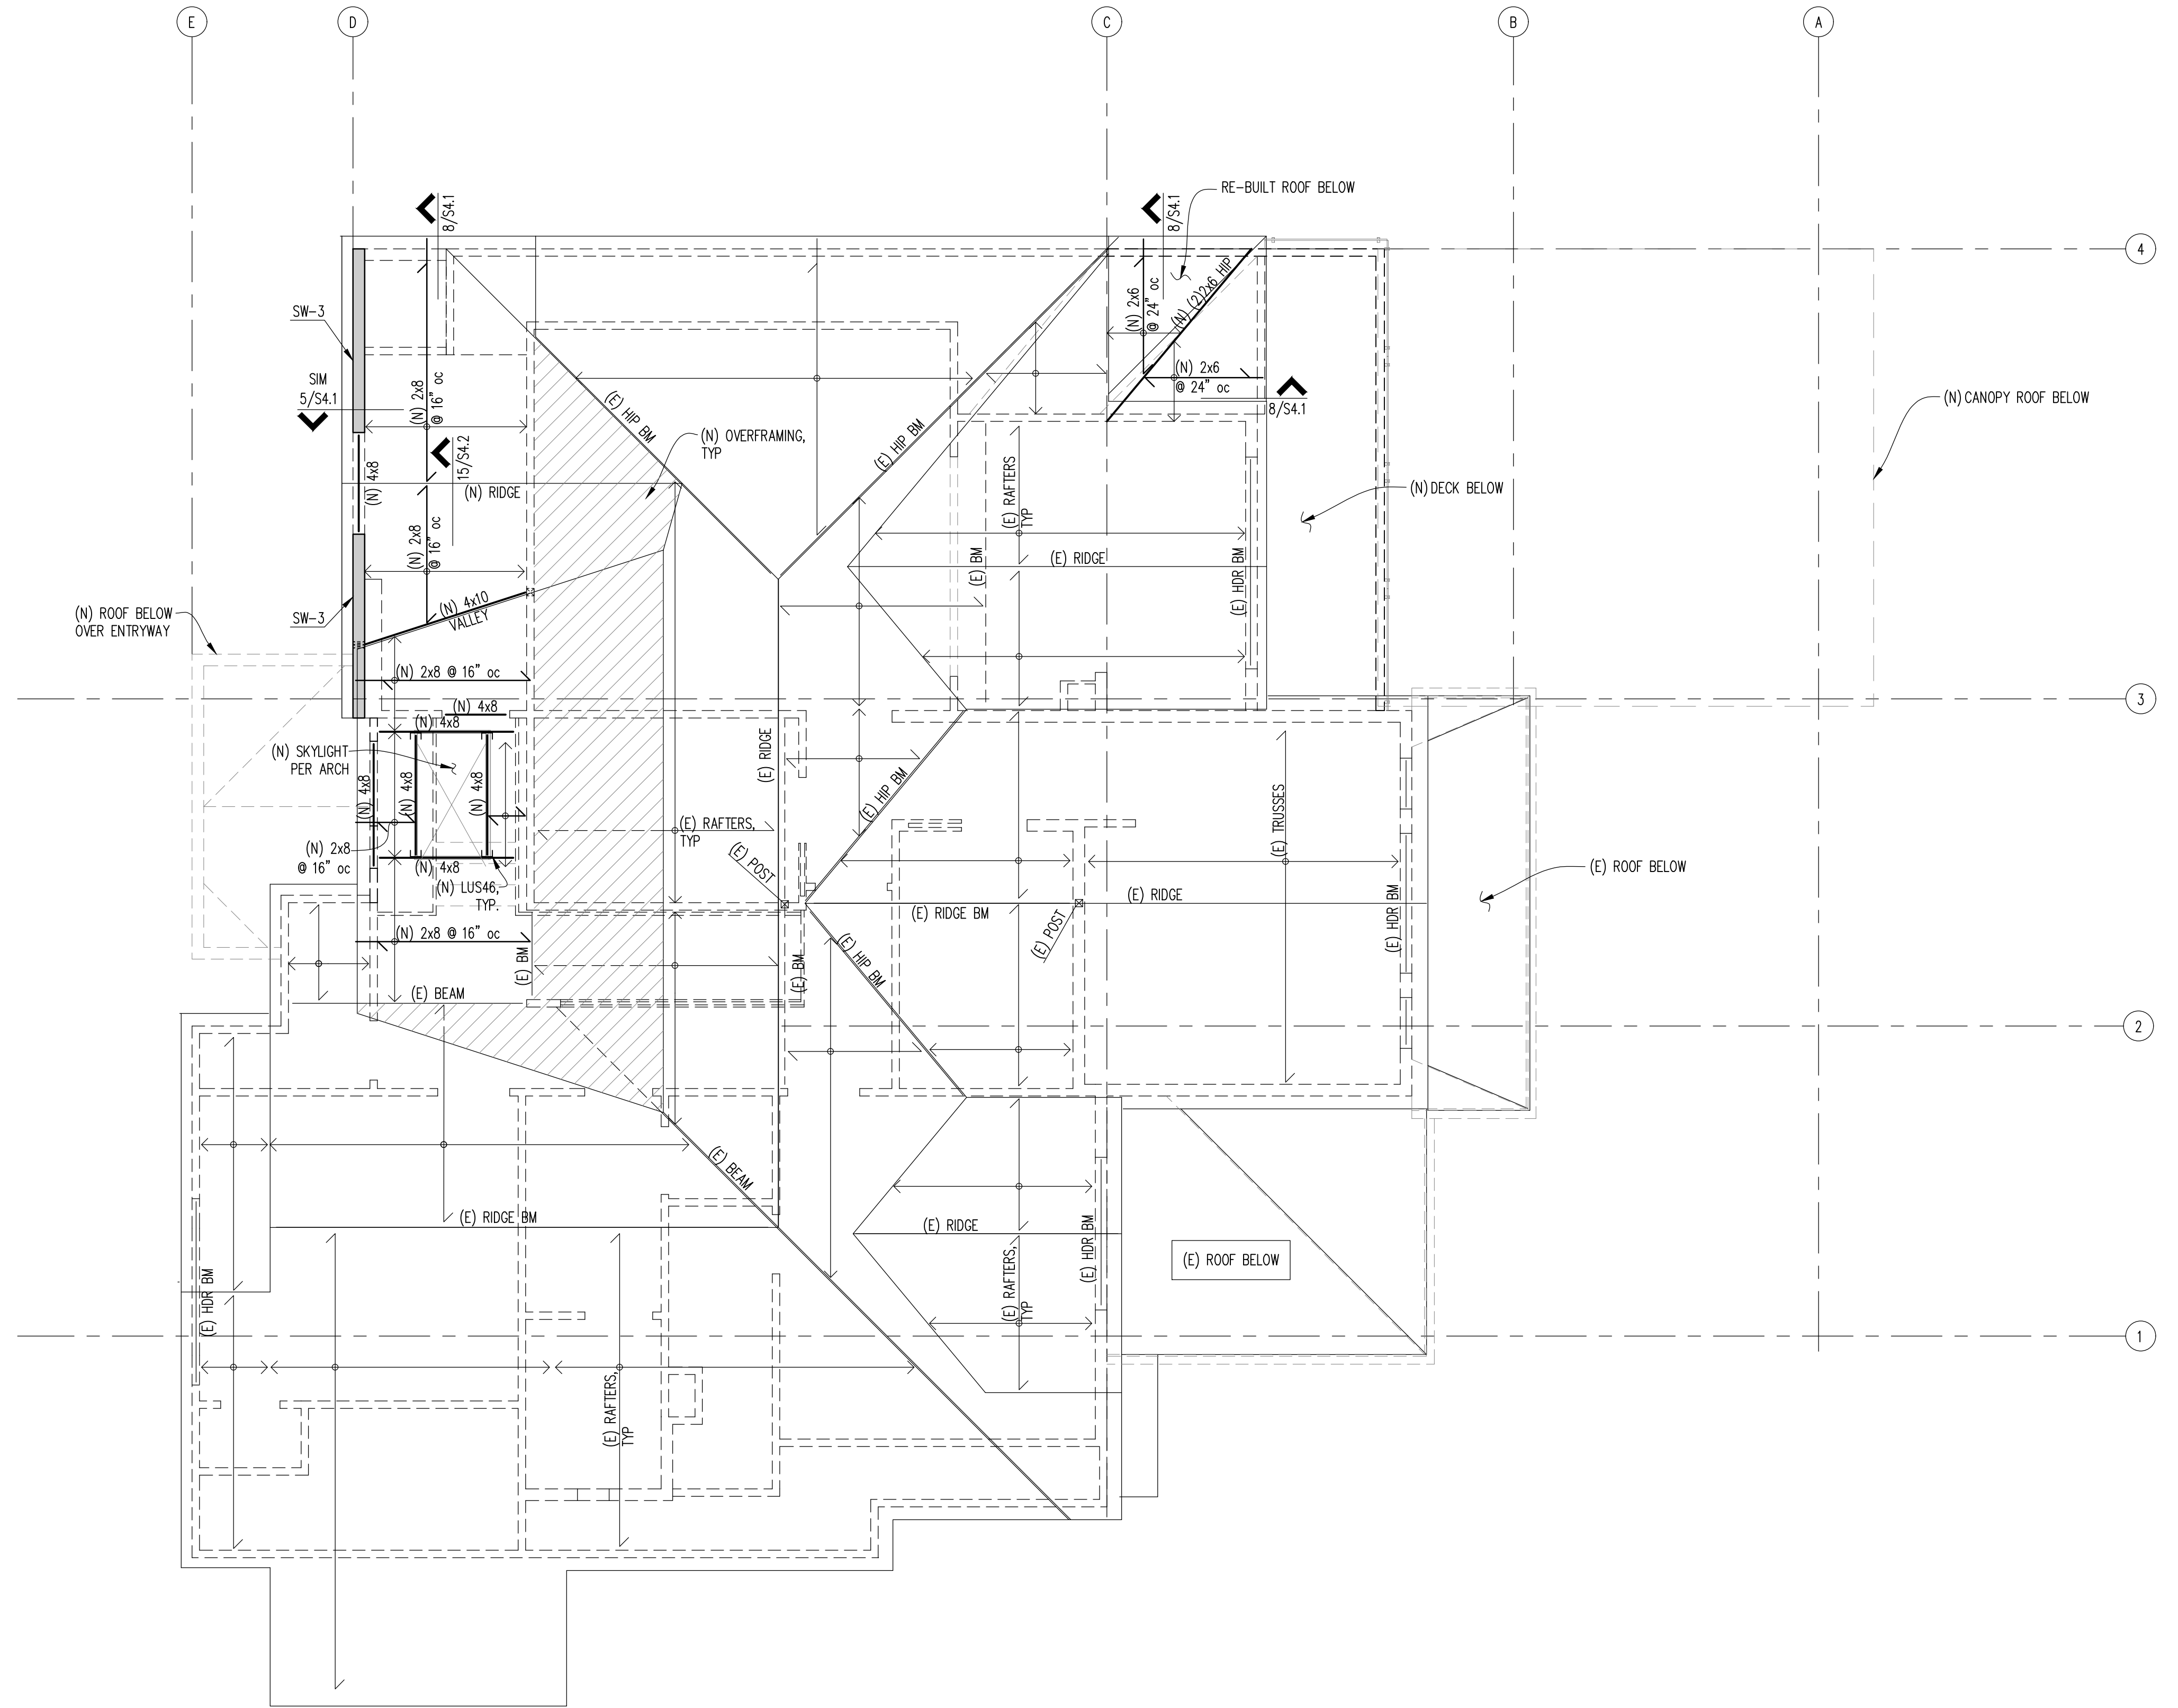

(N) GARAGE BUILDING

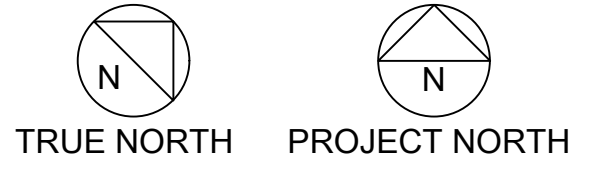

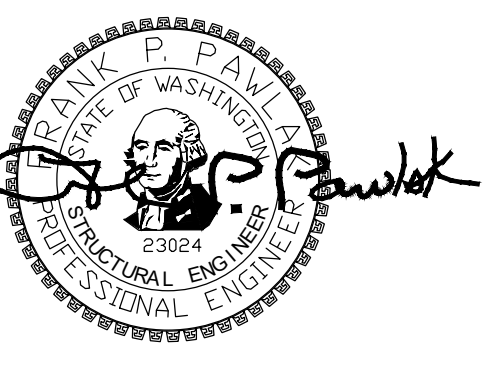

PROJECT

9820 SE 35TH PLACE  
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9820 SE 35TH PL  
MERCER ISLAND, WA 98040

REVISIONS	
NO.	DATE
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11/4/20	20-129
DATE	JOB #
AM	FPP
DESIGN	CHECKED
LMS	AS NOTED
DRAWN	SCALE


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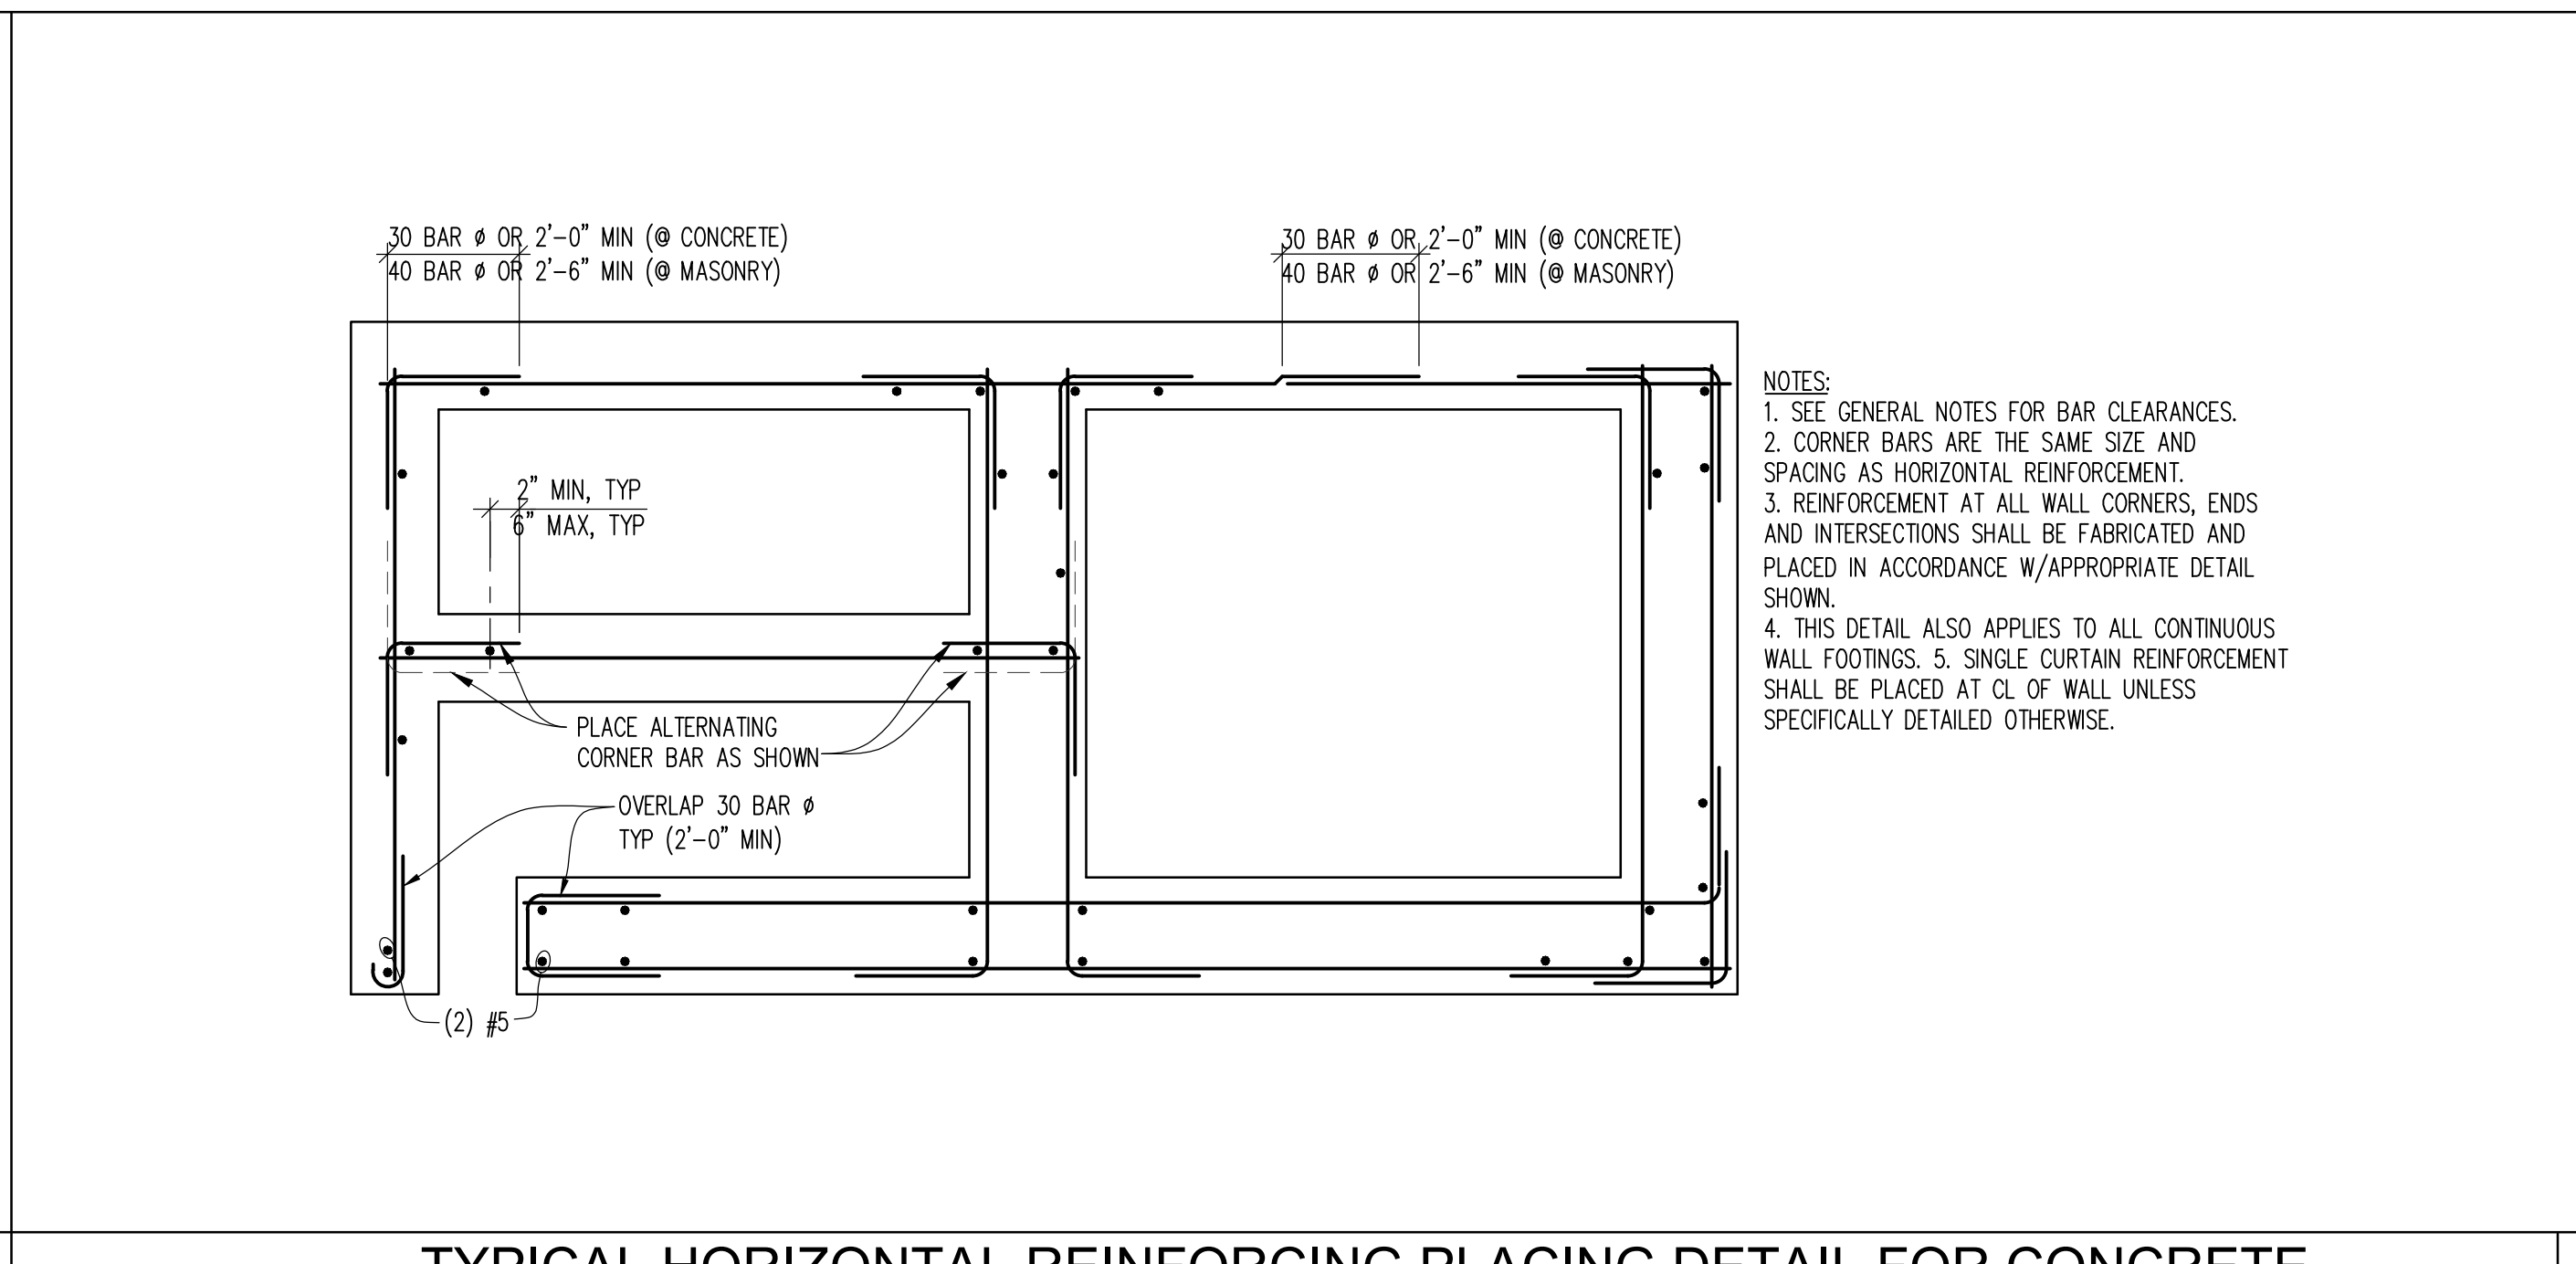
CONCRETE  
DETAILS

SHEET NO.


S3.1




EXTERIOR WALL FOOTING 1

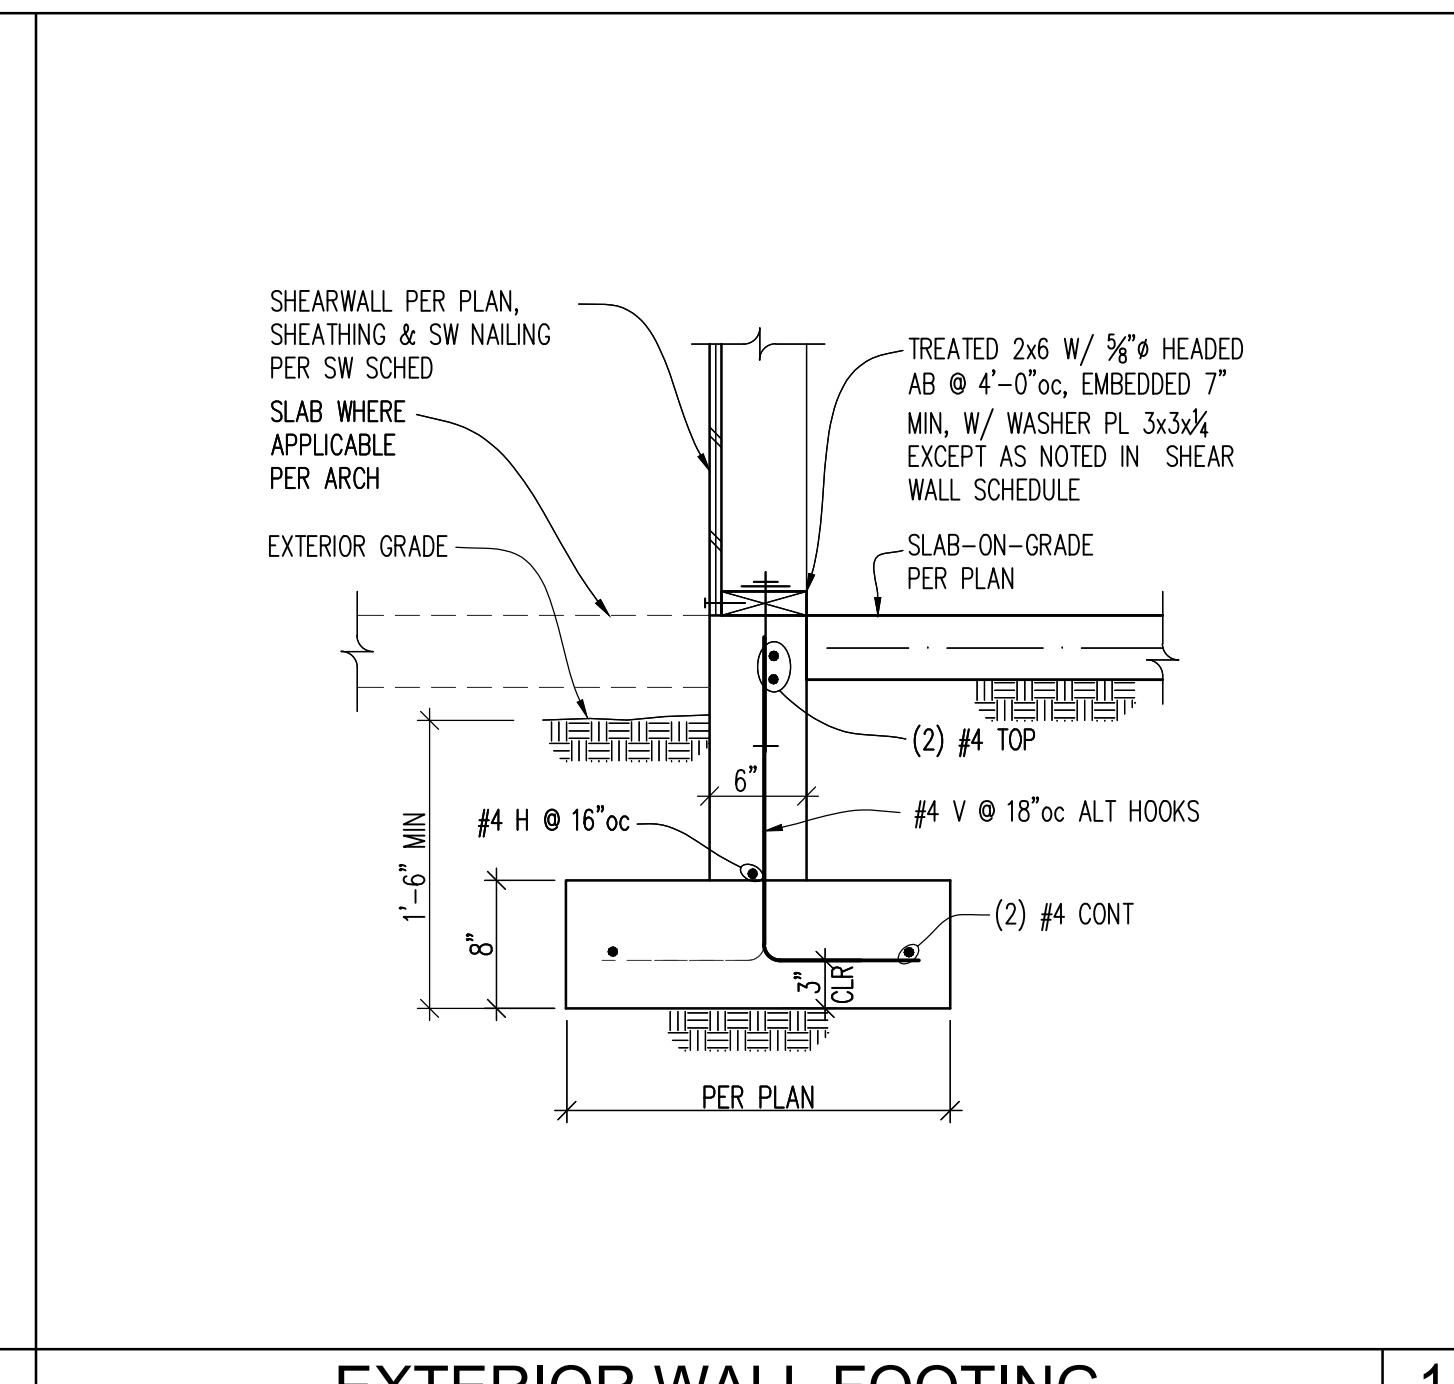


TYPICAL HORIZONTAL REINFORCING PLACING DETAIL FOR CONCRETE 5

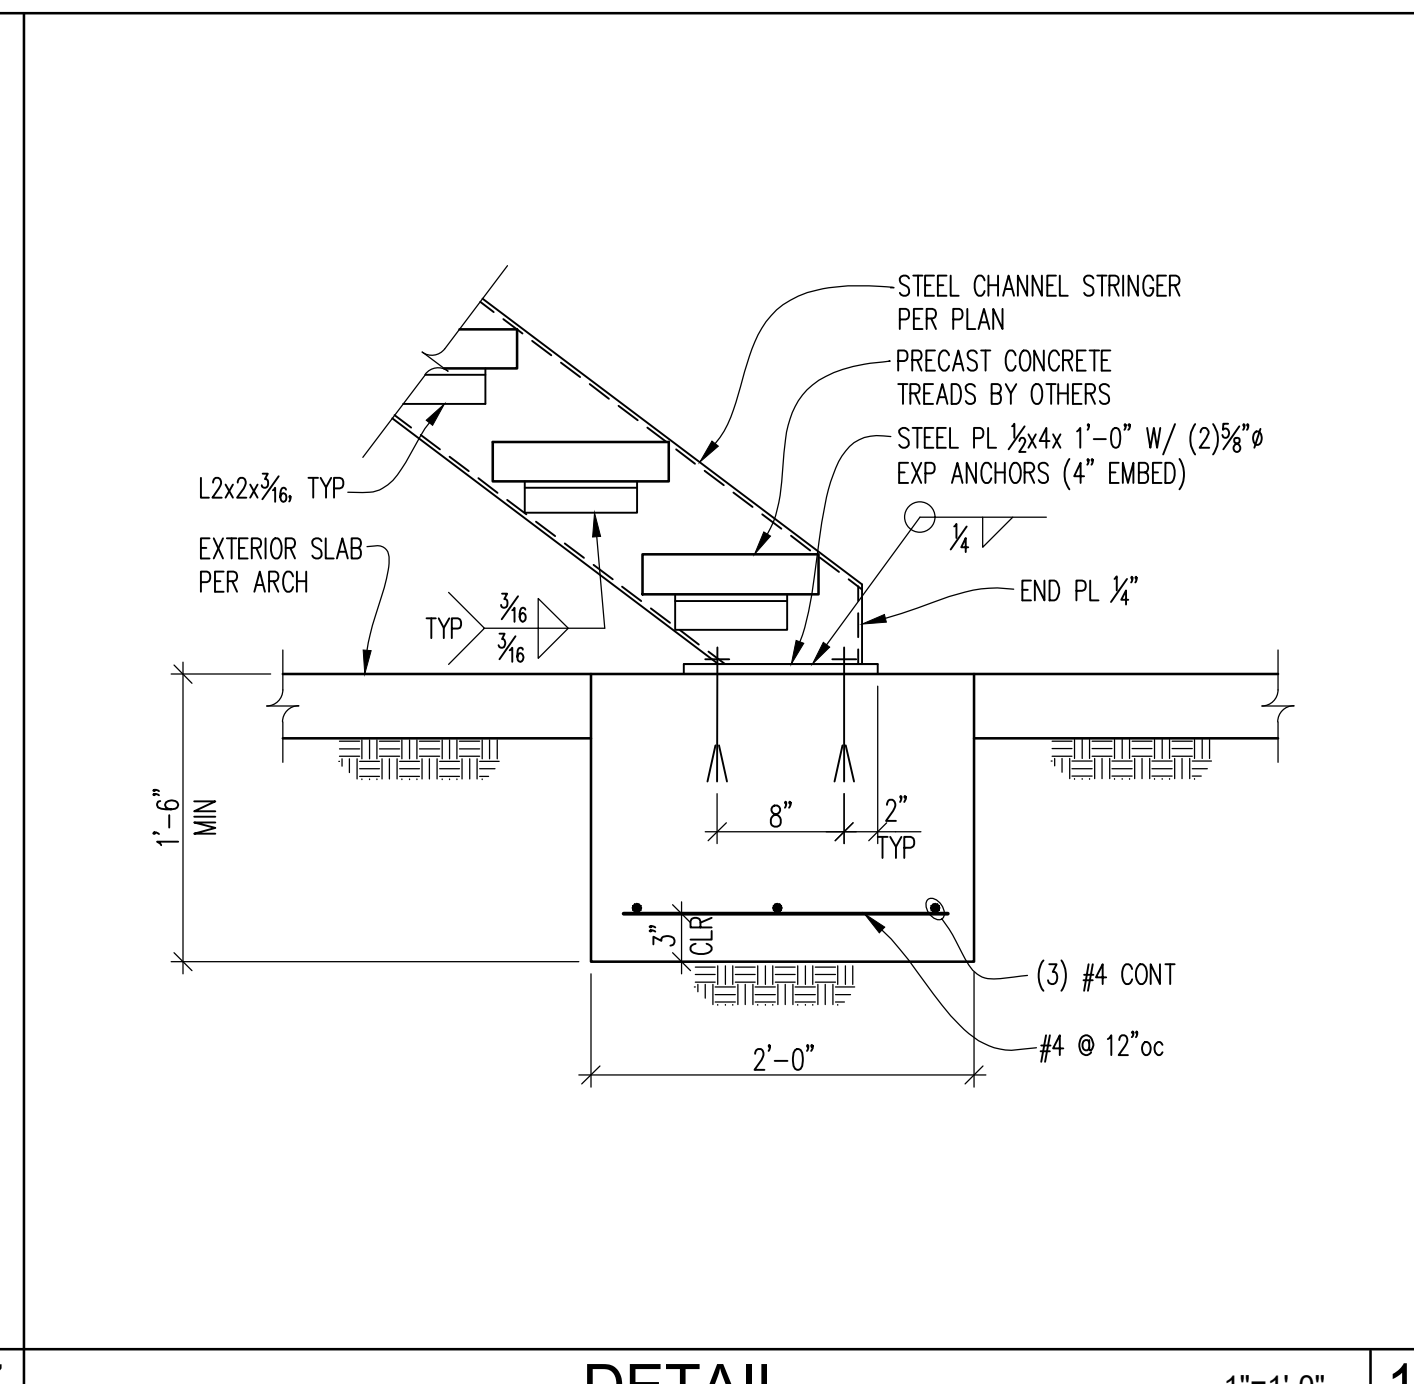


DETAIL 17

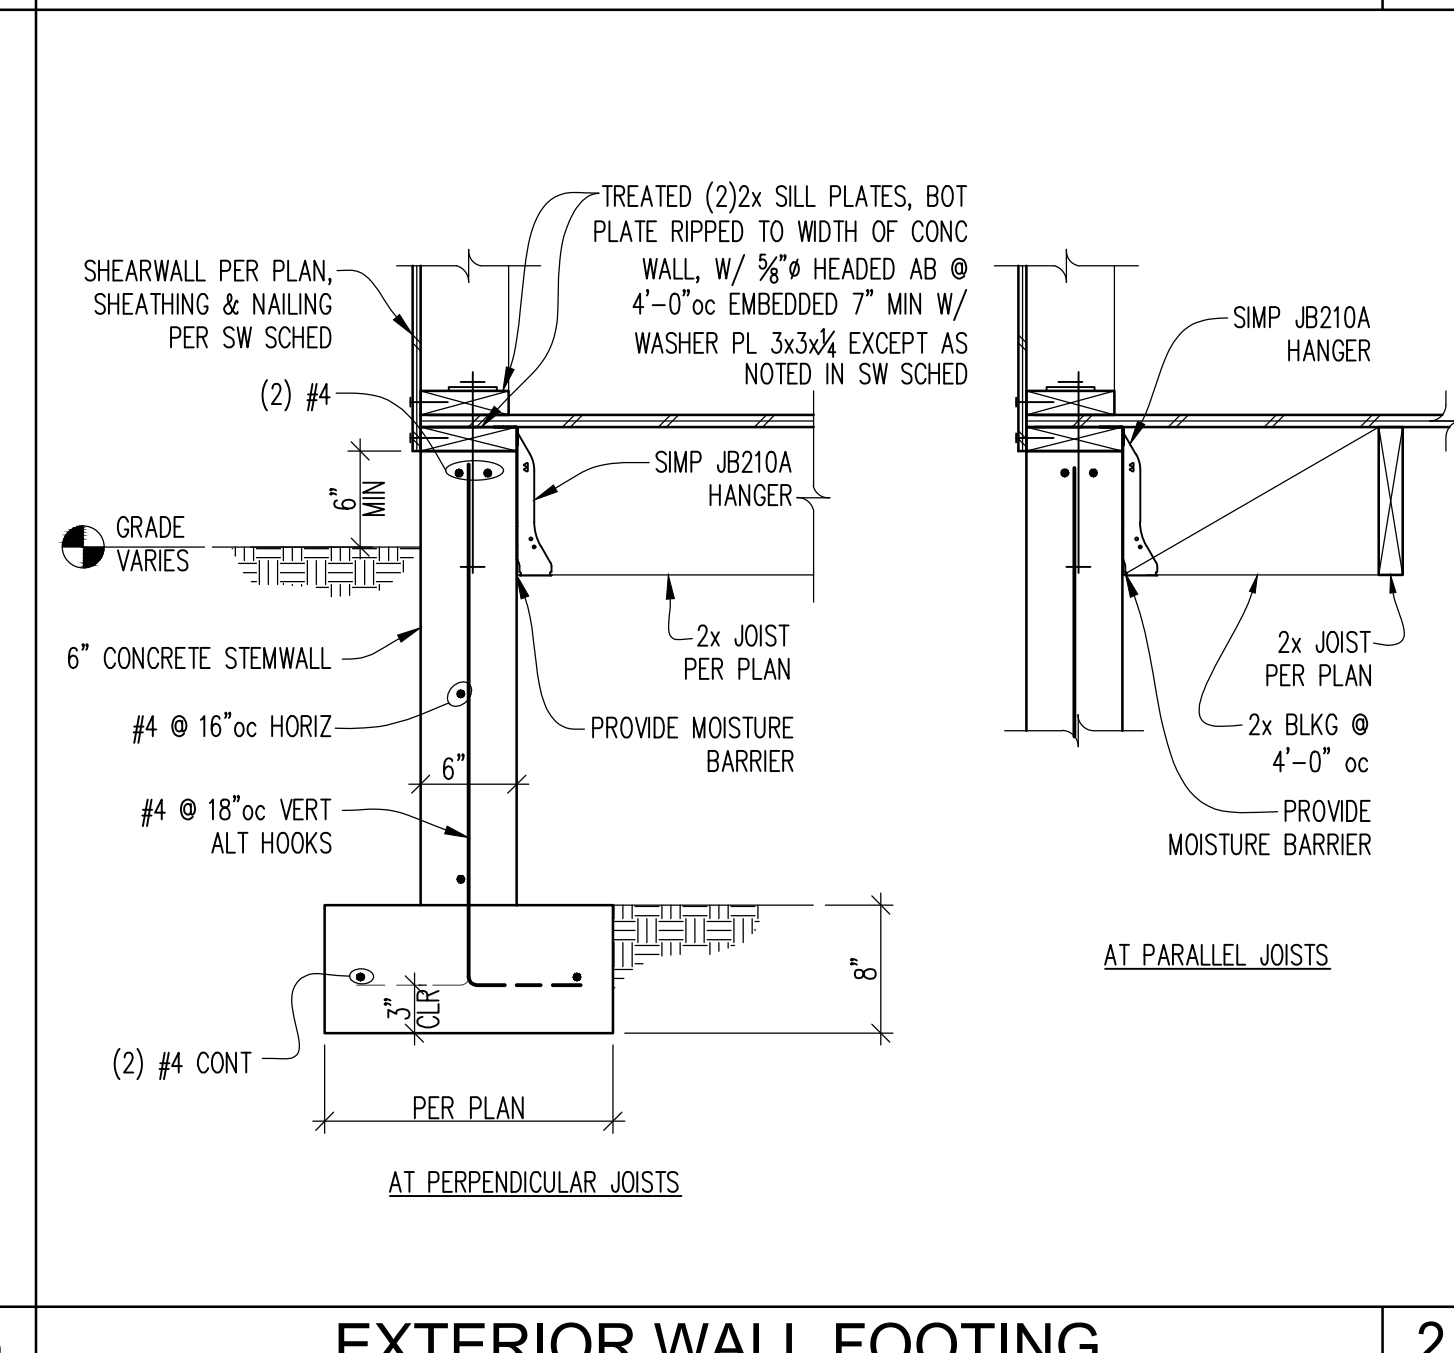


EXTERIOR WALL FOOTING 2

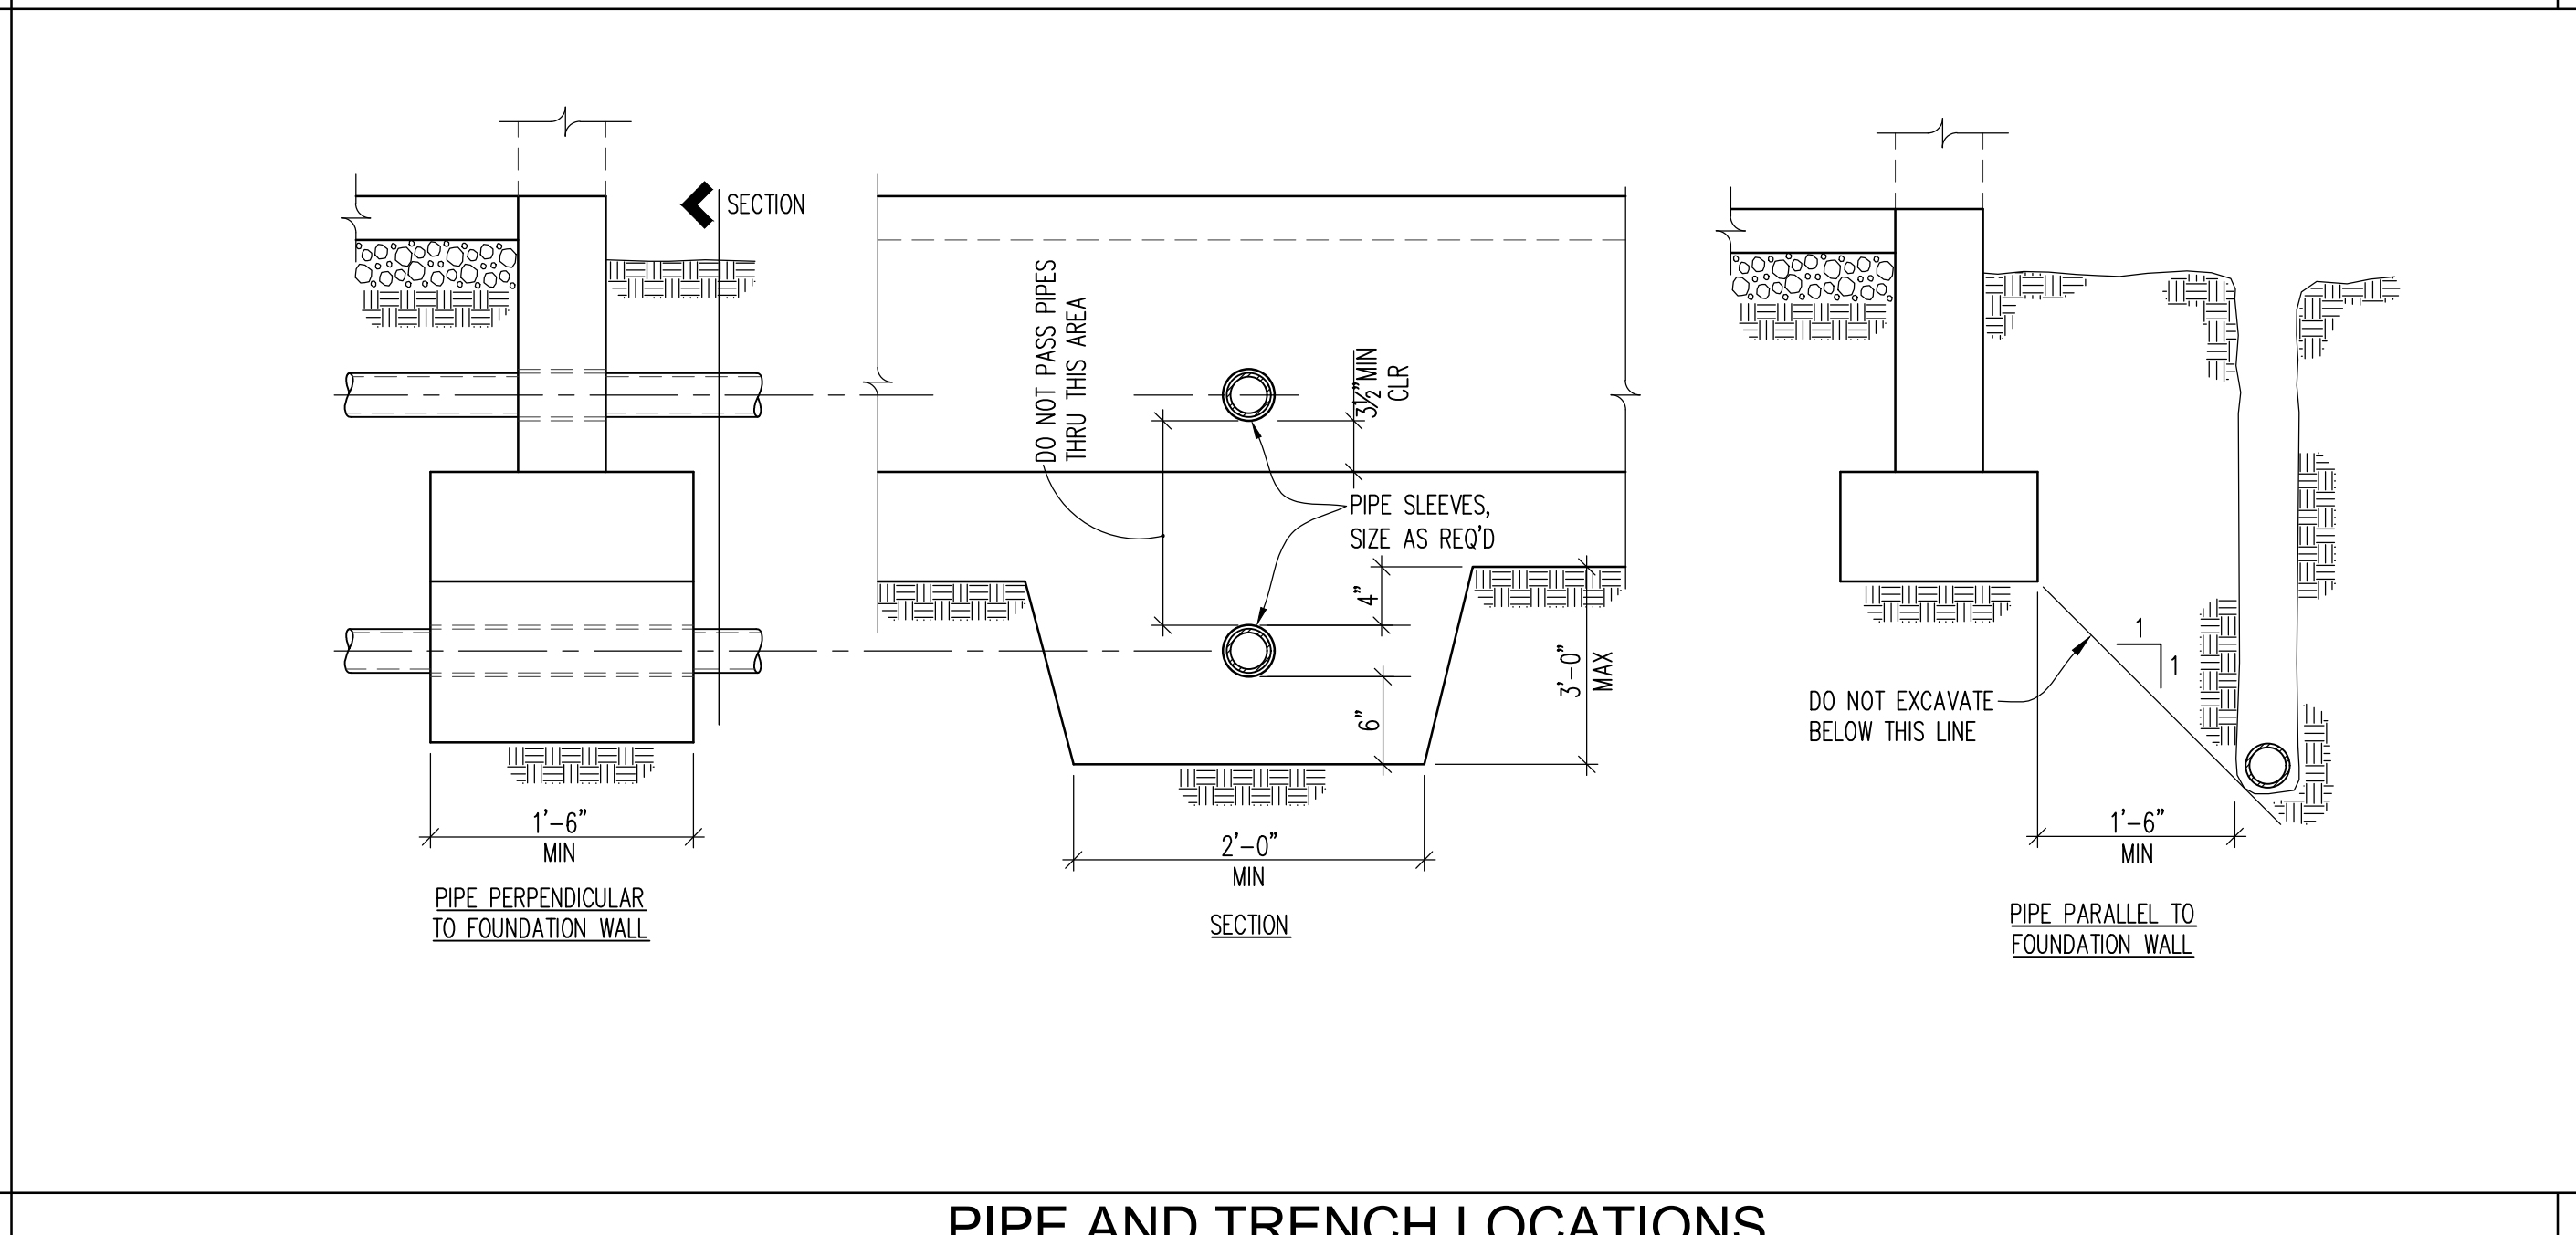


PIPE AND TRENCH LOCATIONS 6

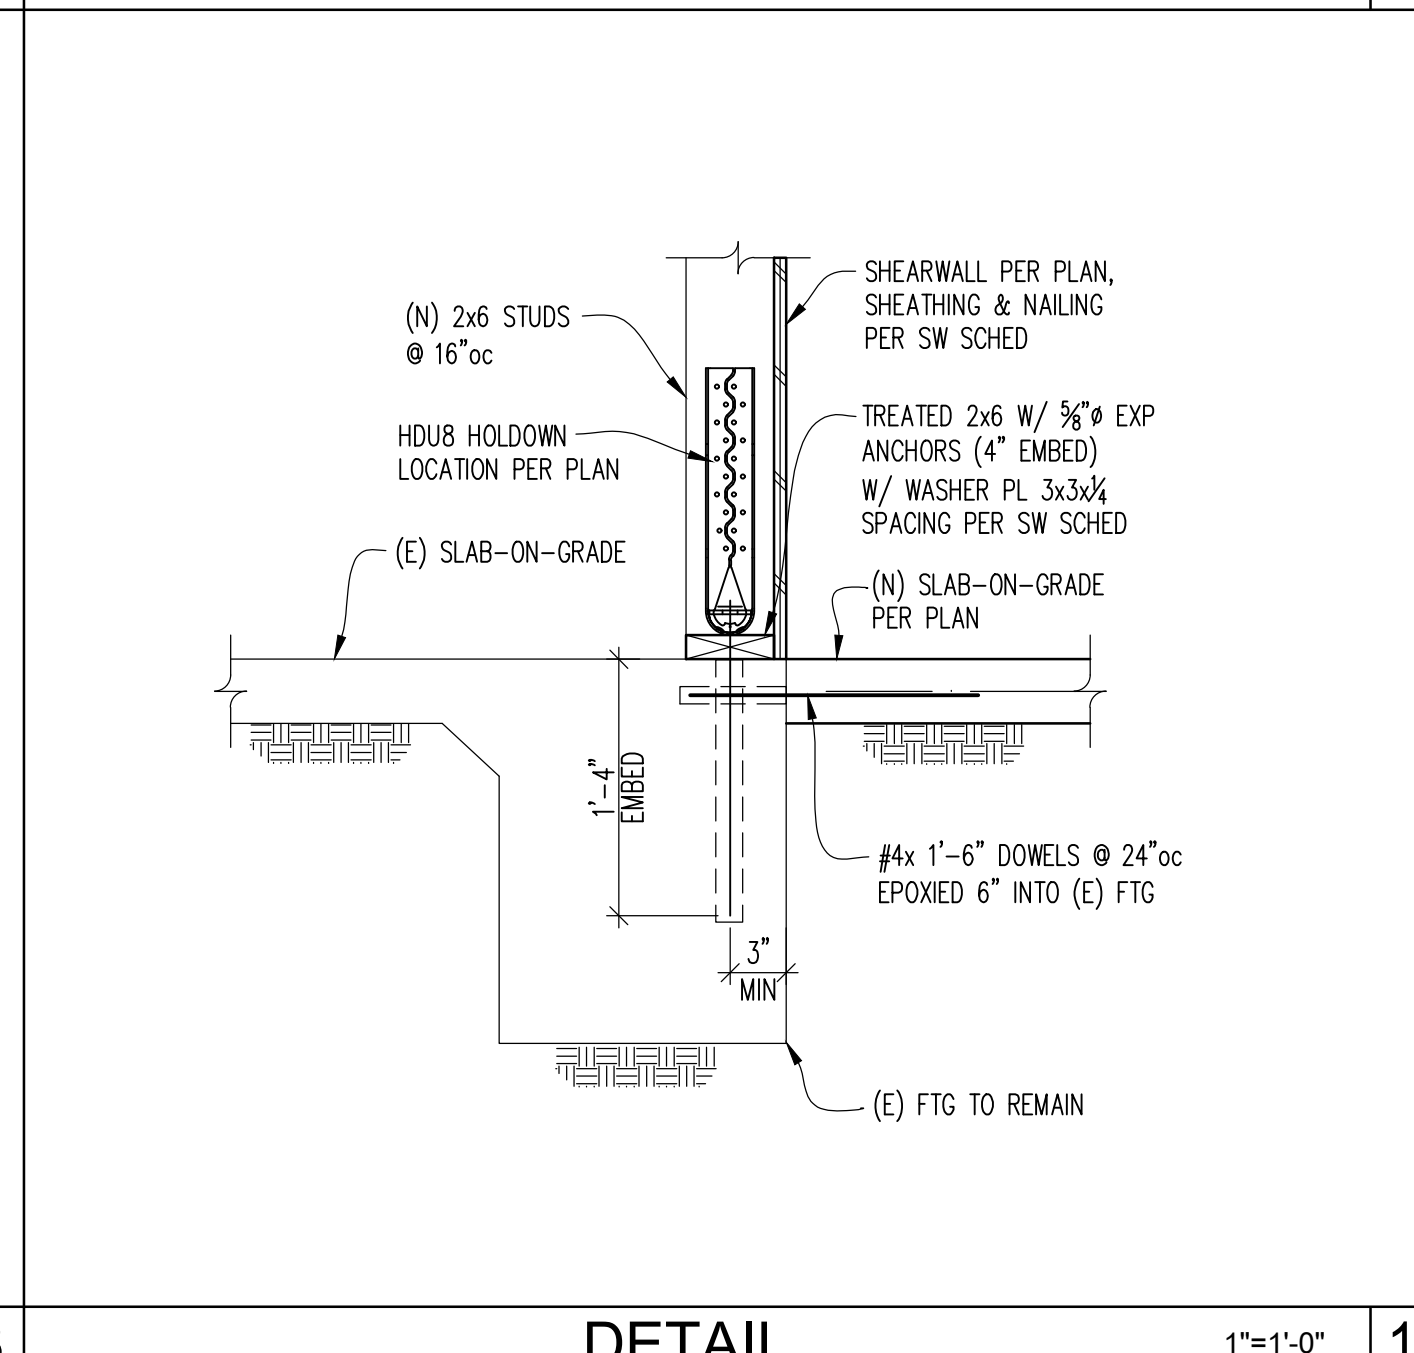


DETAIL 18

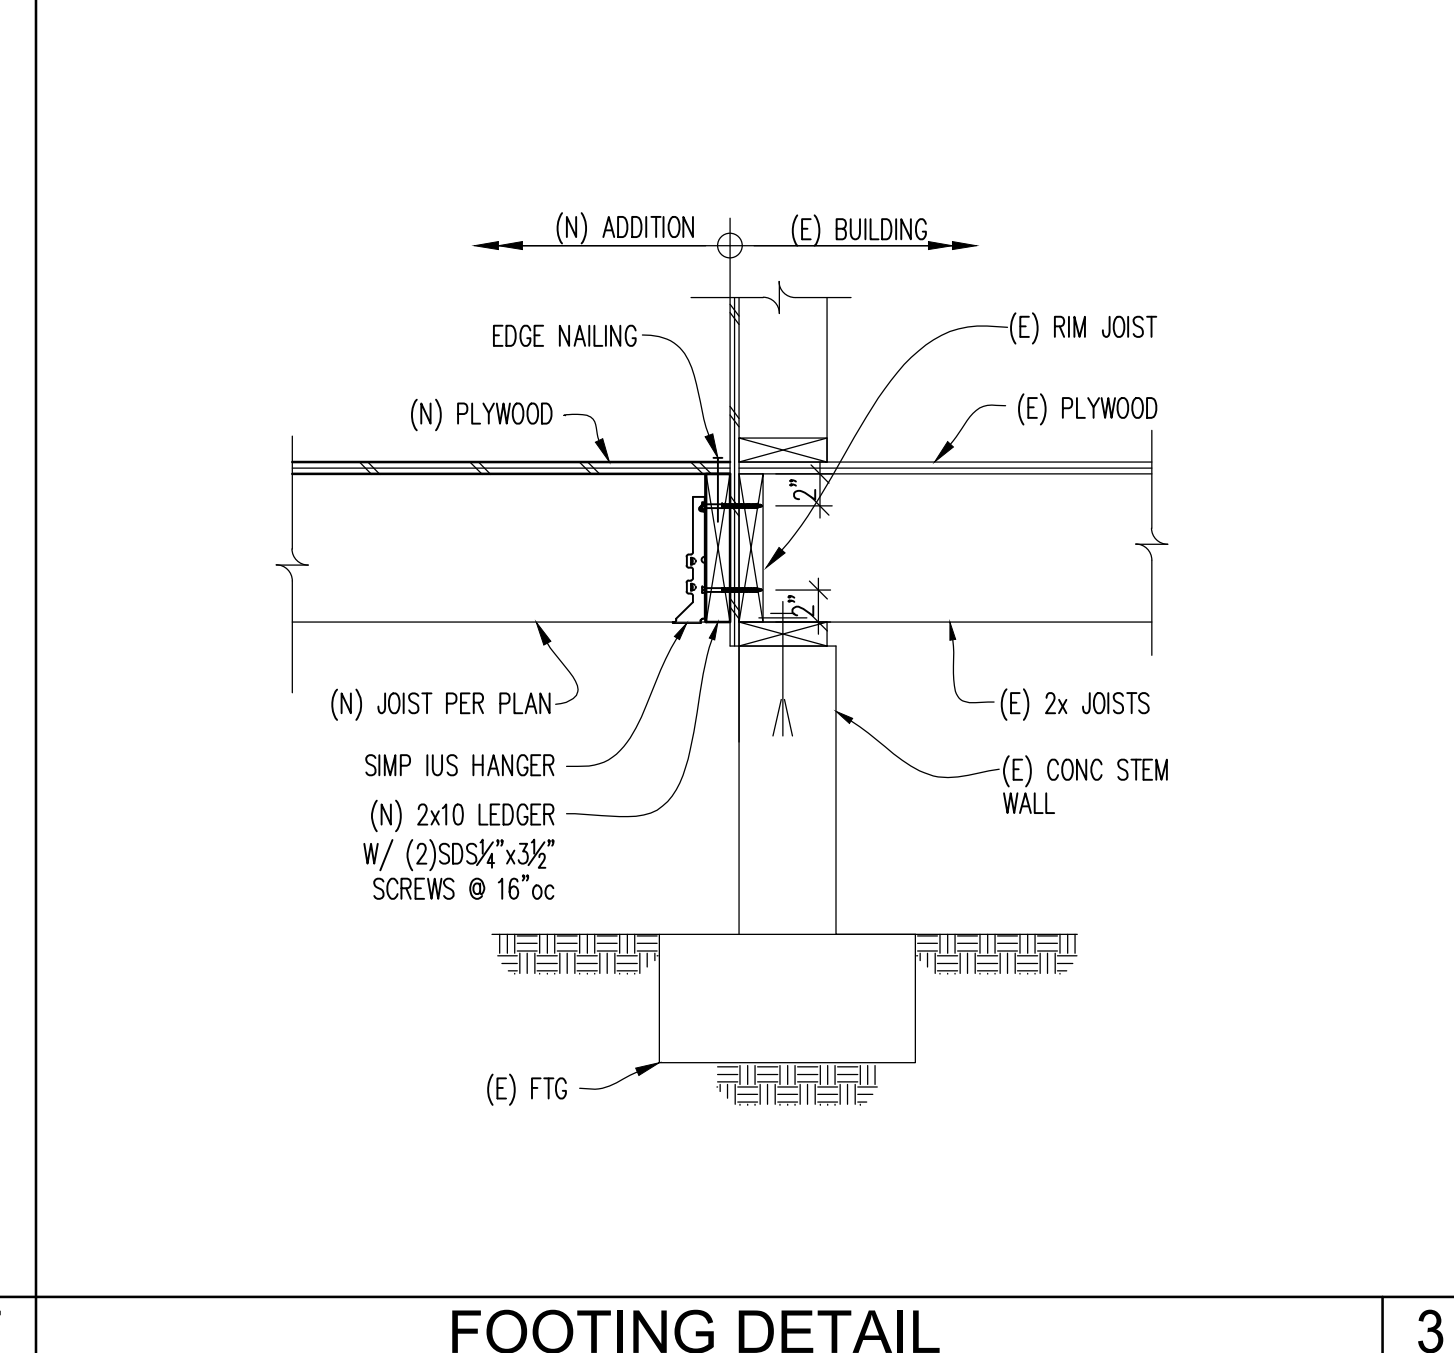


FOOTING DETAIL 3

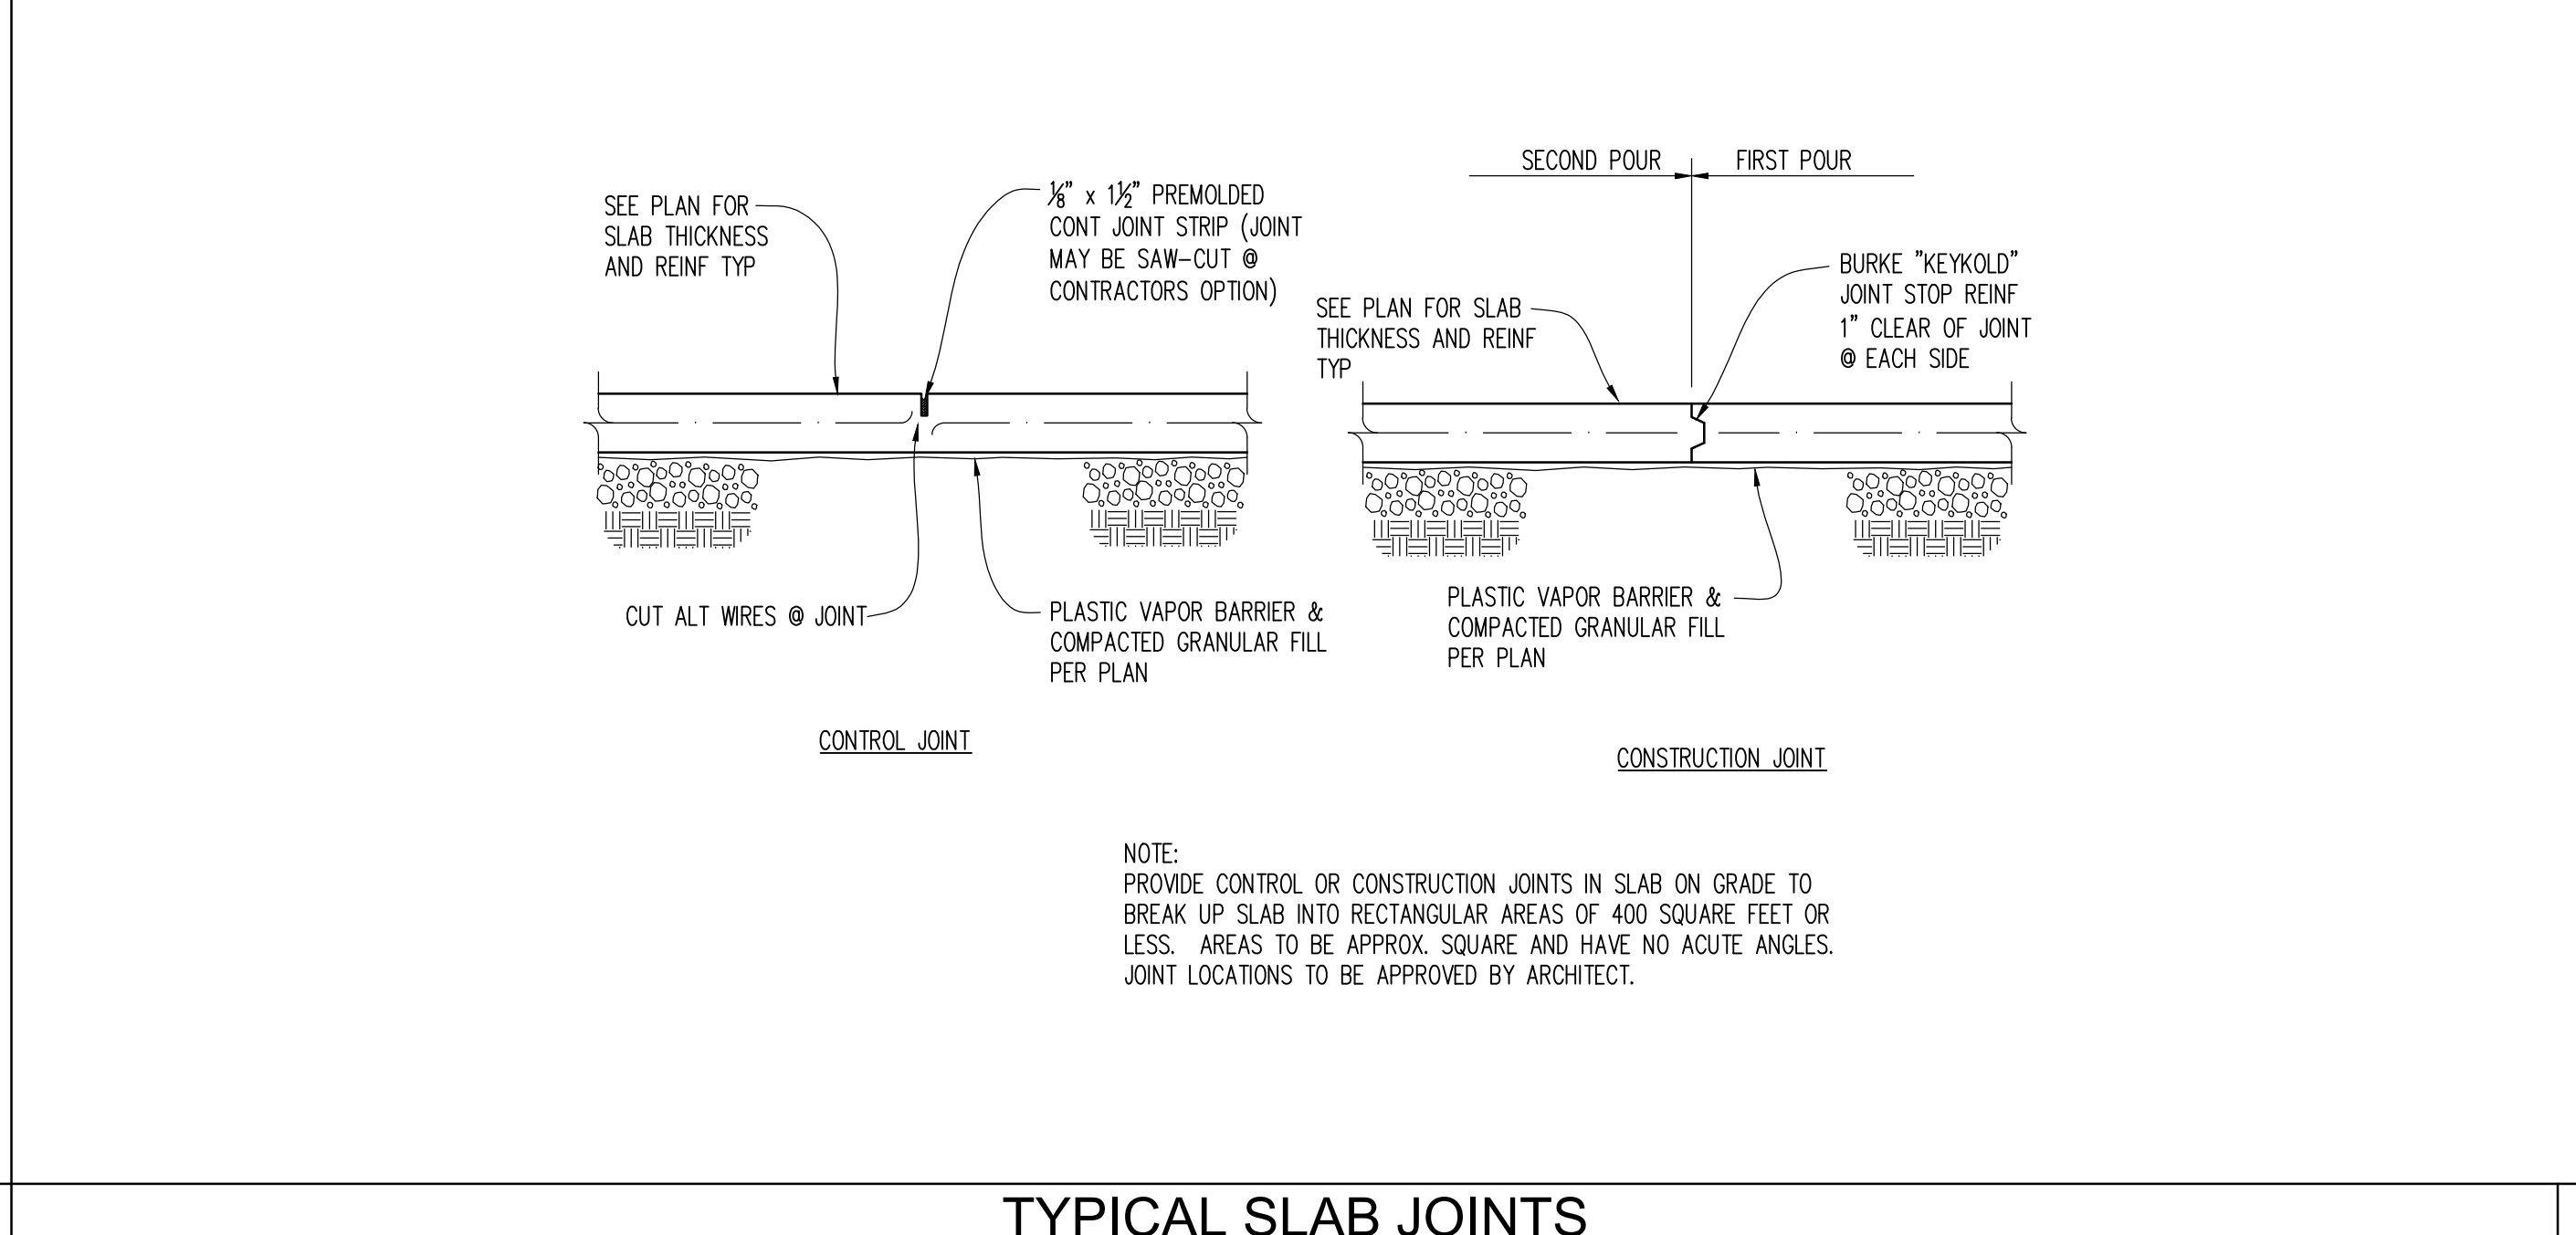


TYPICAL SLAB JOINTS 7

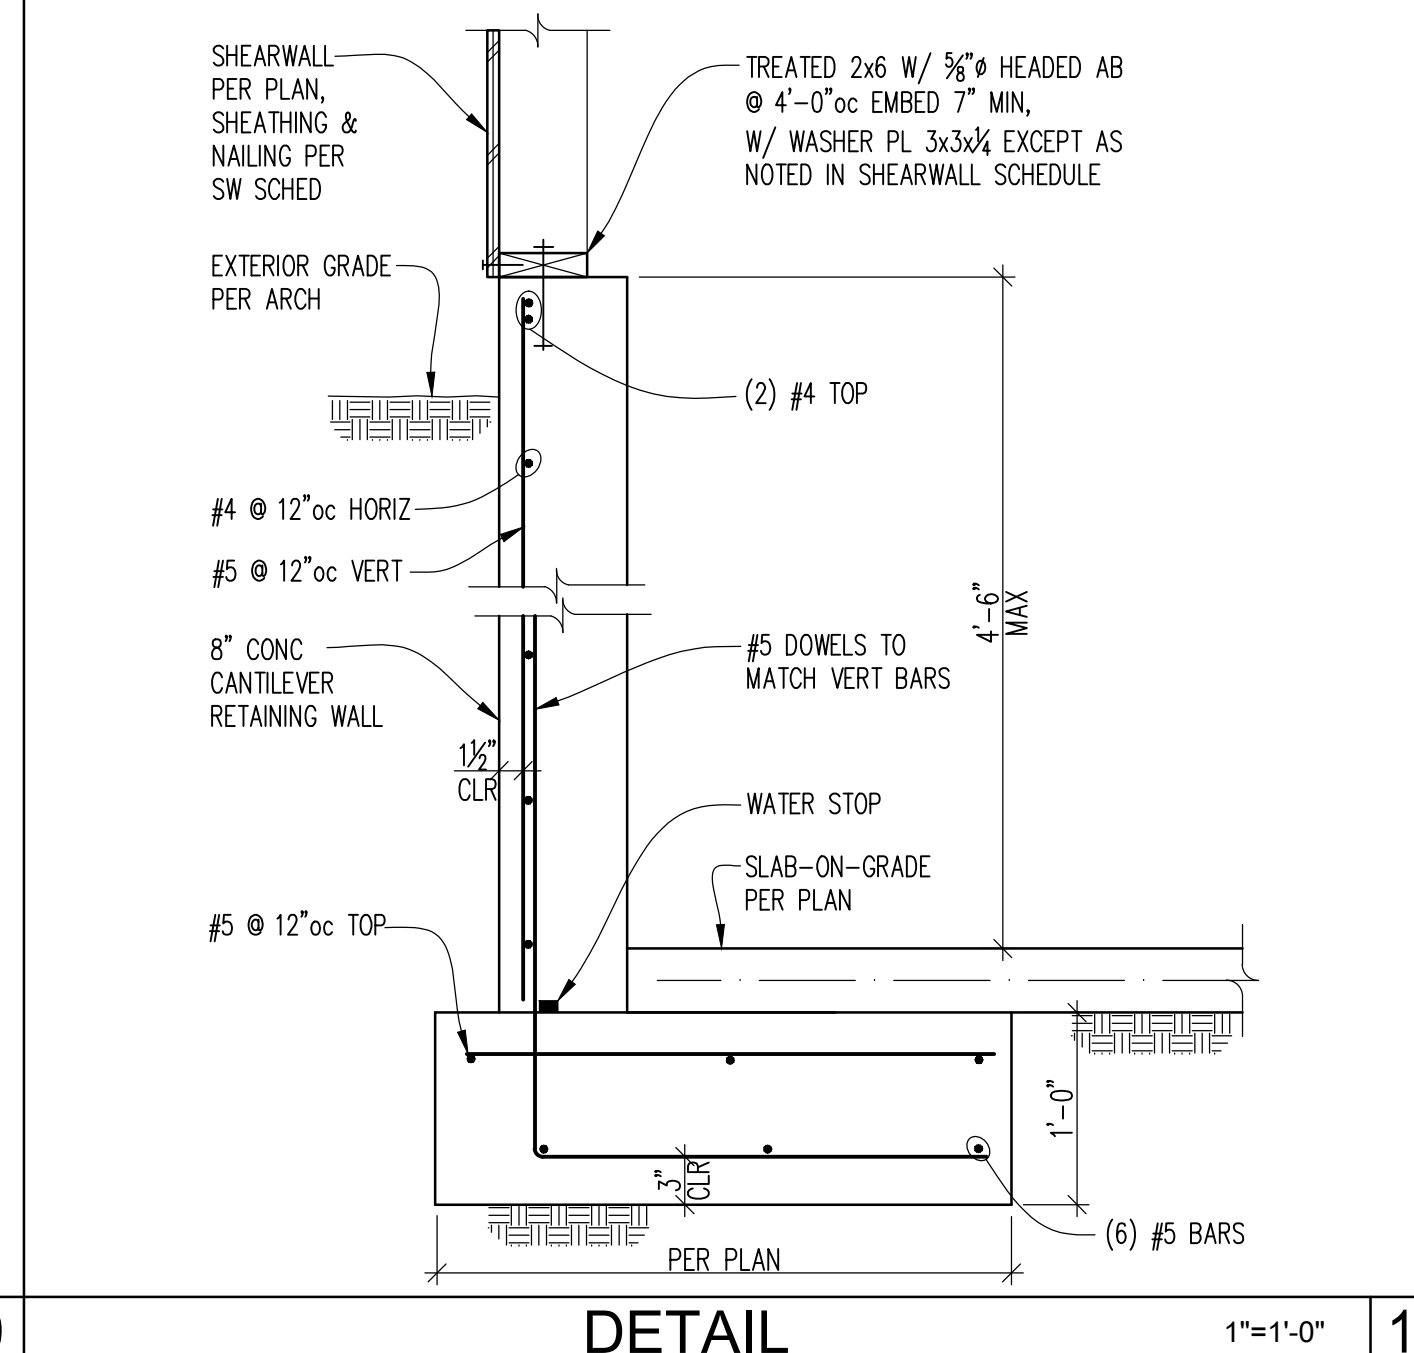


DETAIL 19

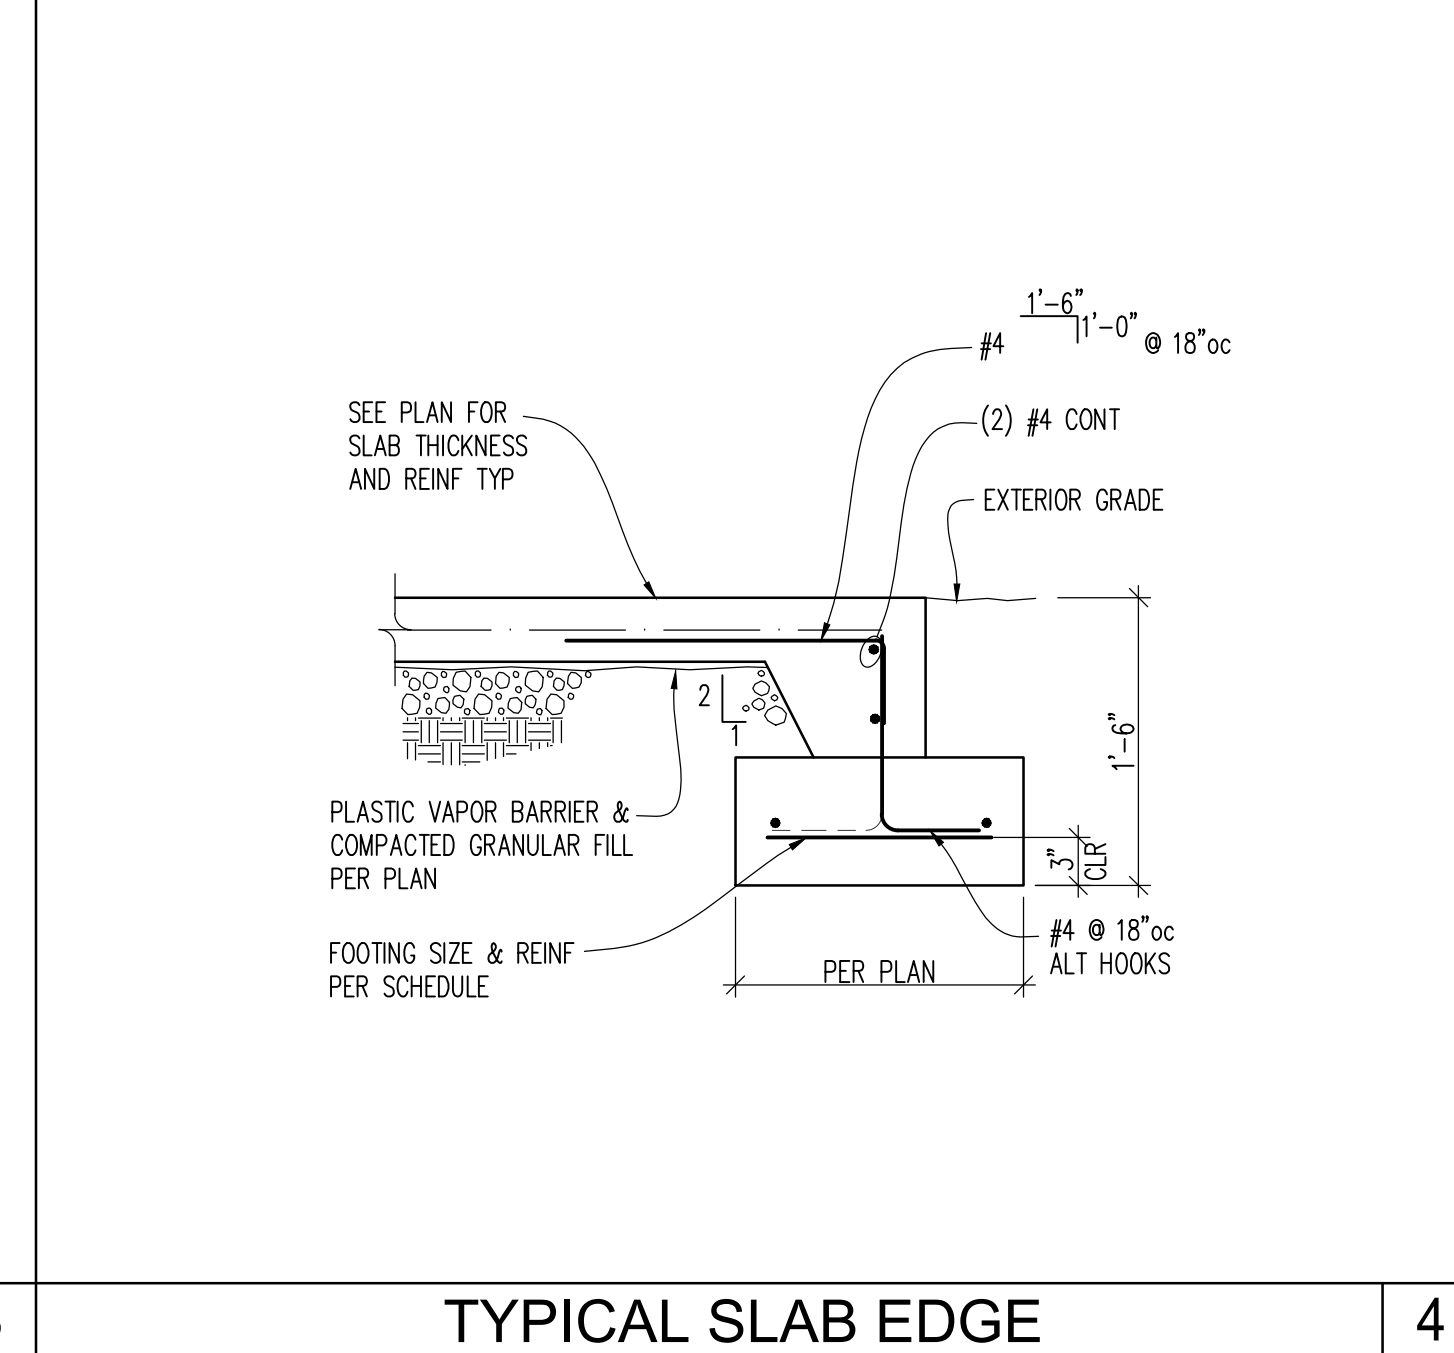

TYPICAL SLAB EDGE 4

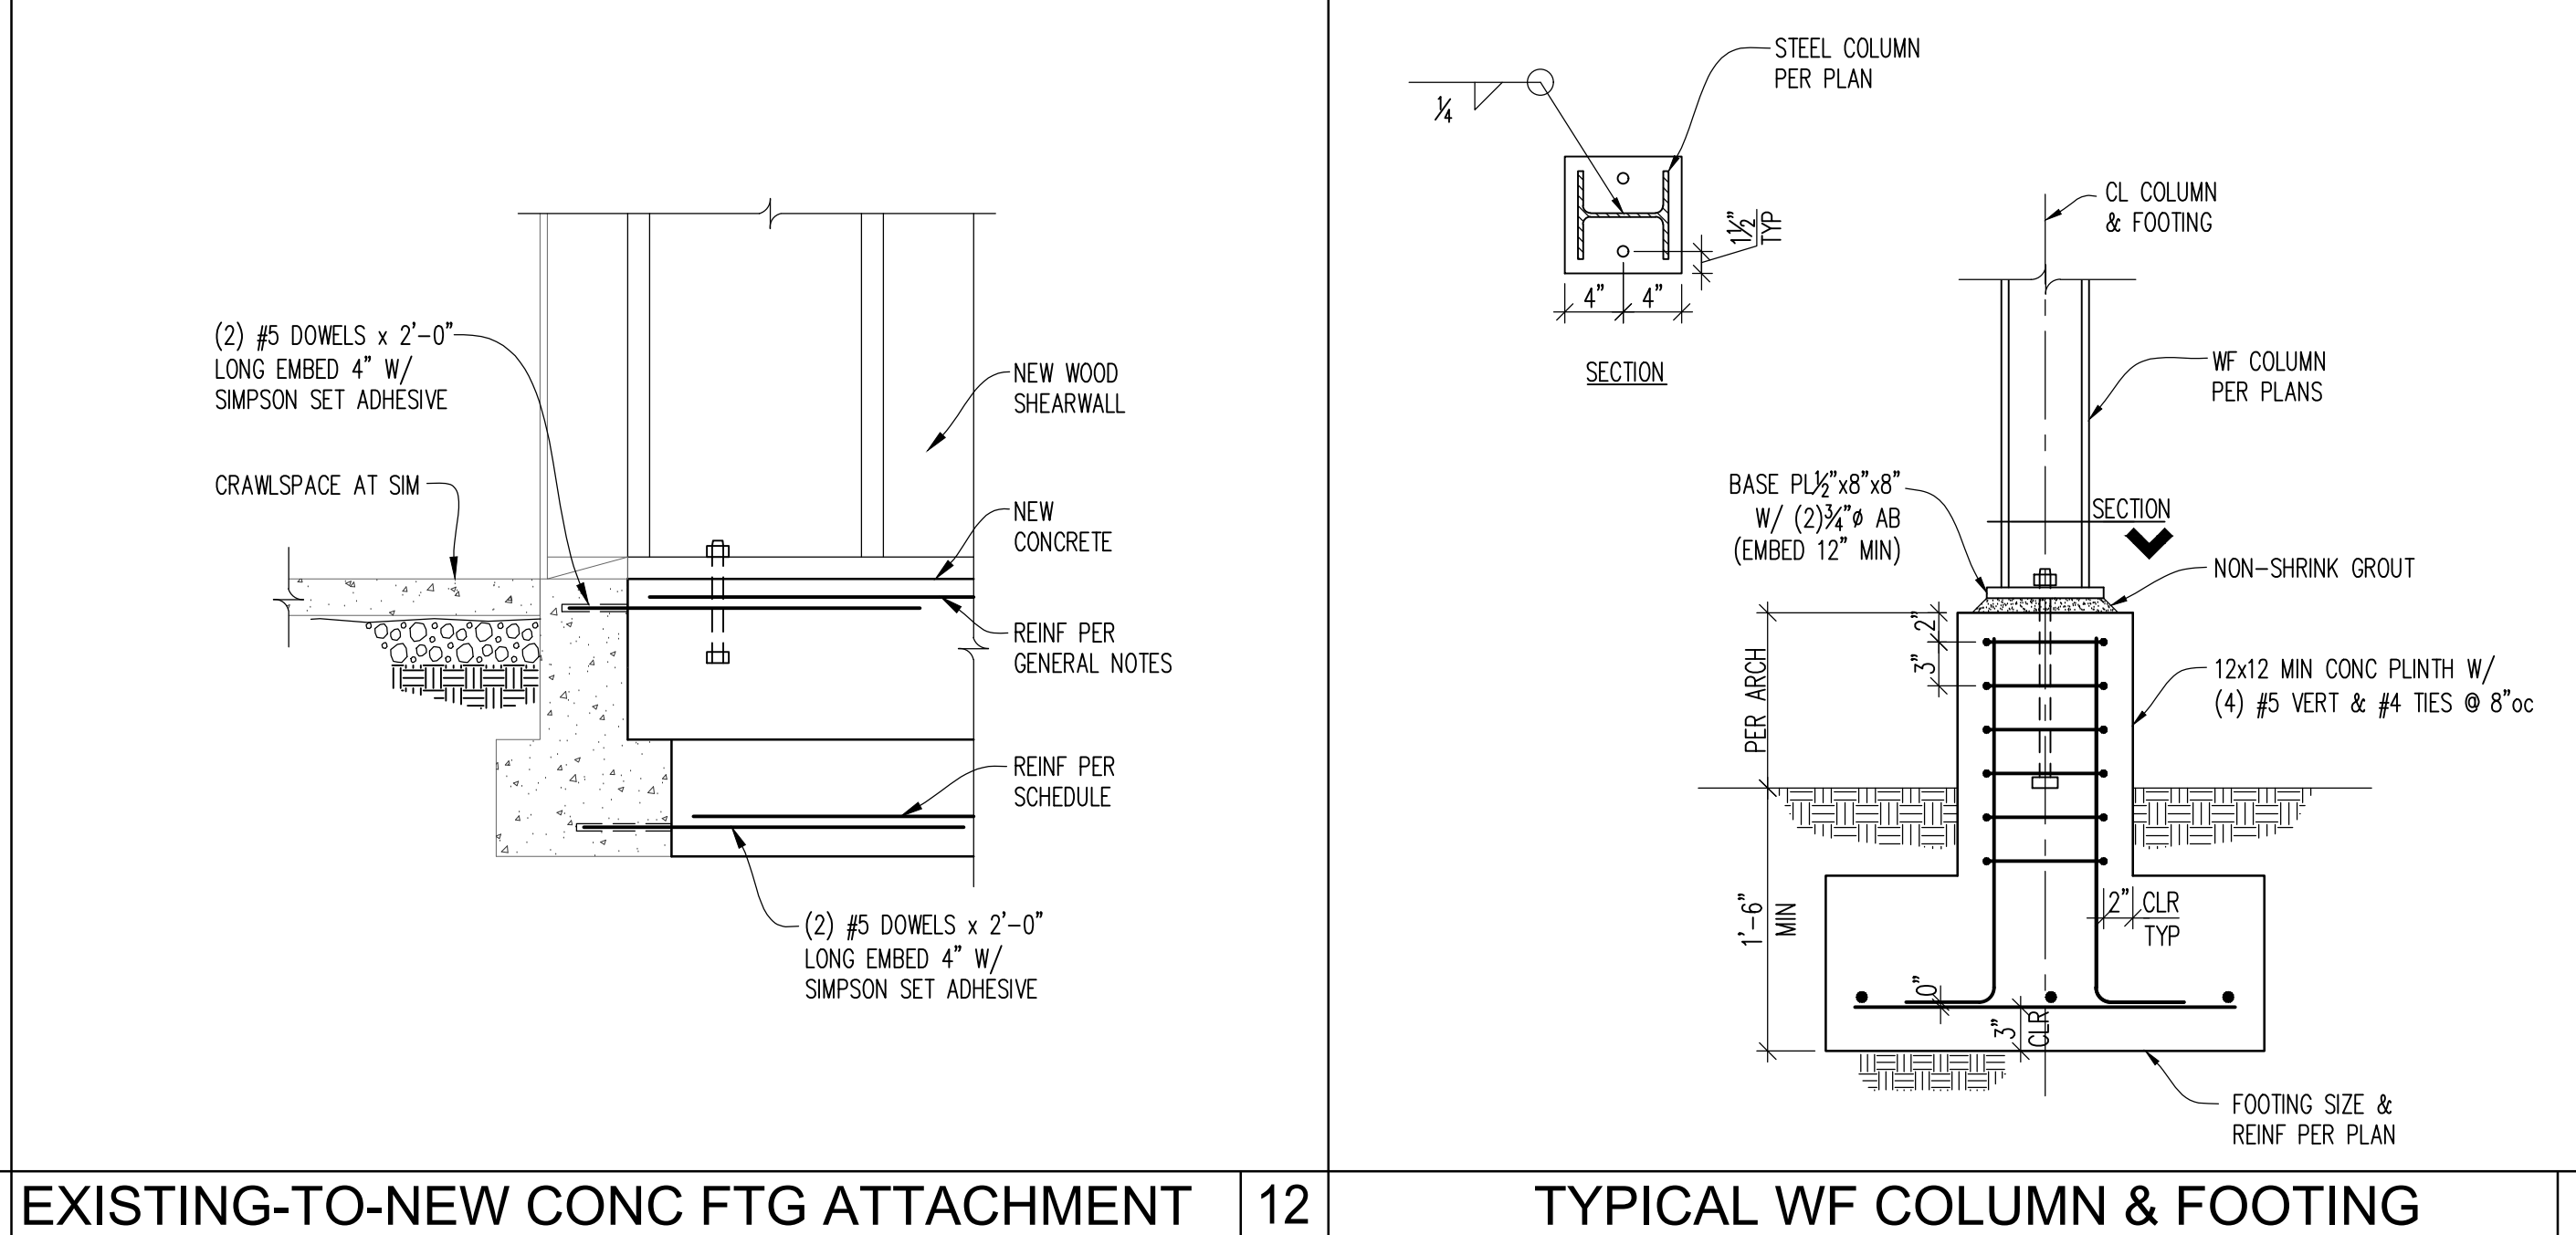

TYPICAL WF COLUMN & FOOTING 8

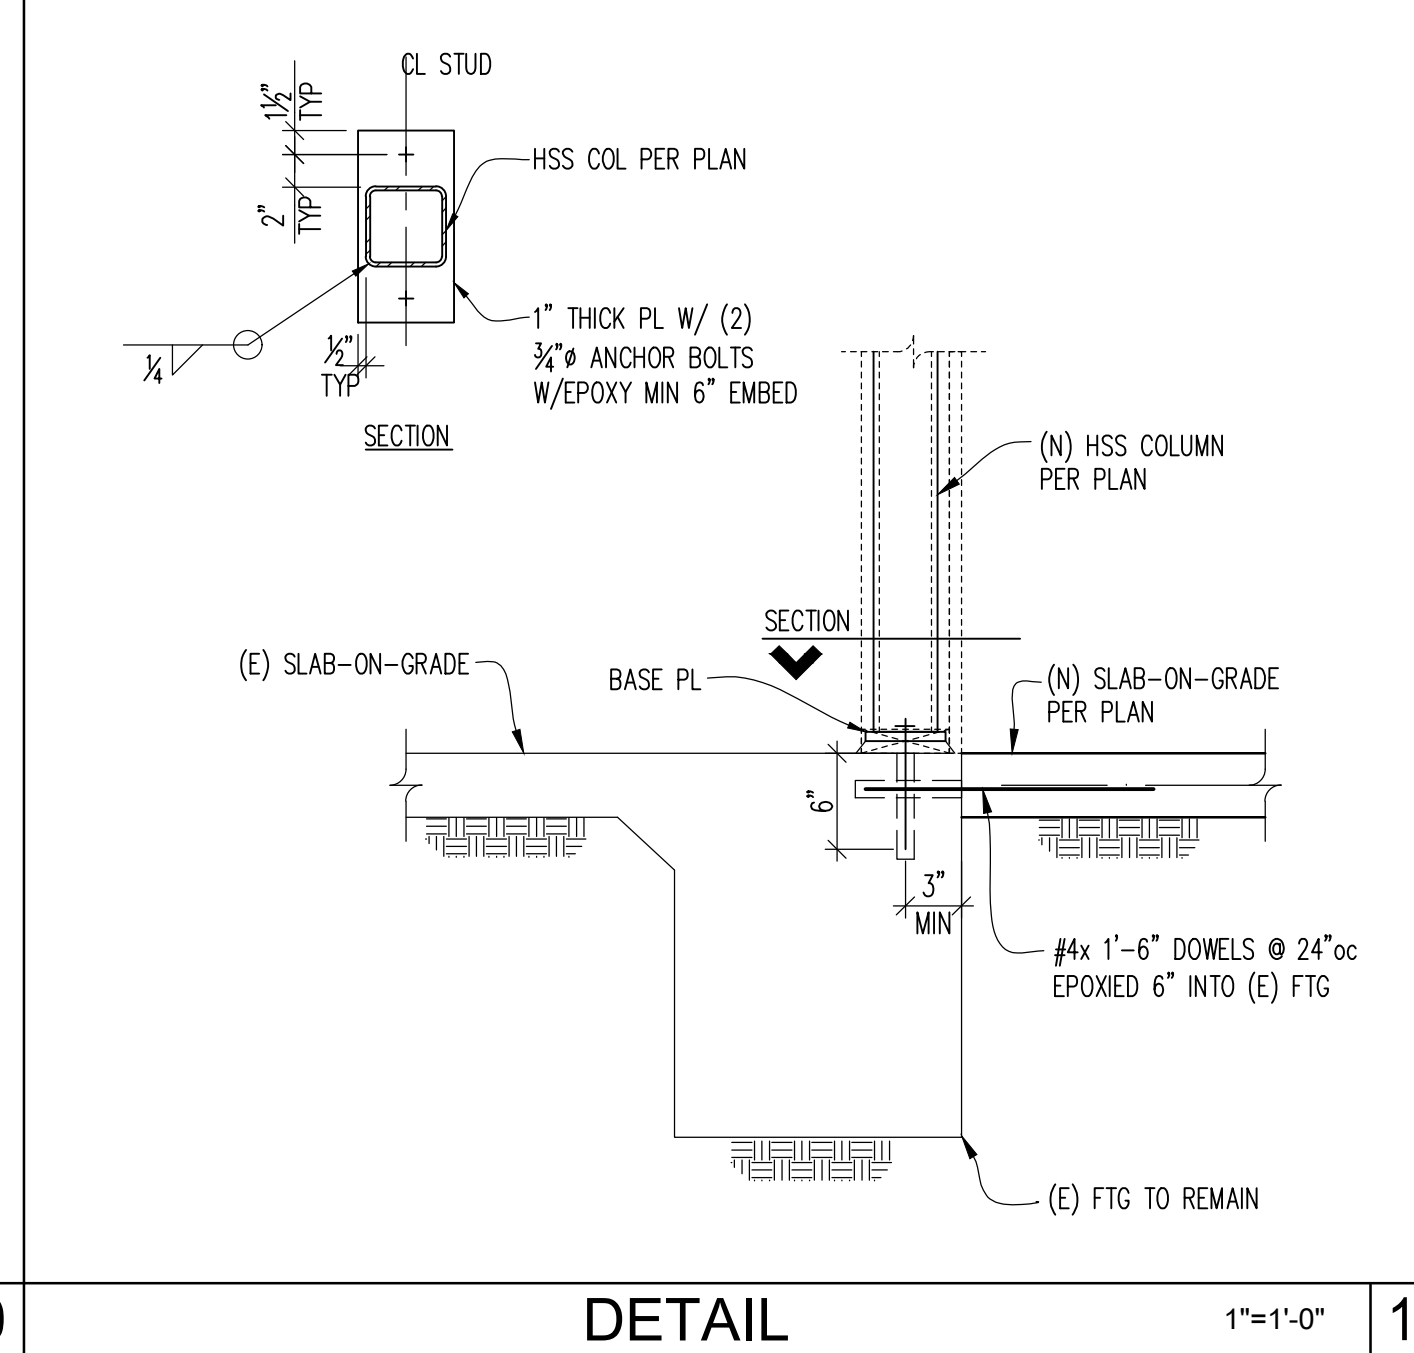



DETAIL 20

EXISTING-TO-NEW CONC FTG ATTACHMENT 12

SHEAR WALL SCHEDULE (HEM FIR LUMBER WITH 8d NAILS)										
MARK	SHEATHING (NOTES 1,2,3,4,9)	RIM/BLKG TO WALL TOP PLATE (NOTE 6)	WALL BOTTOM PLATE TO RIM/BLKG ATTACHMENT * (NOTE 6.1)		3/8" ANCHOR BOLTS TO CONCRETE (NOTES 8,10)	MIN PANEL EDGE STUDS & BLOCKING (NOTE 8)	FASTENING ALTERNATIVE (2)2x TOGETHER (NOTE 14)		ALLOWABLE SHEAR CAPACITY (PLF)(NOTE 8)	
			16d NAILS	SDS 0.220"x5"			10d NAILS	SDS 3/4"x3"		
SW-6	ONE SIDE	8d @ 6"oc	LTP4 @ 24"oc	11"oc	21"oc	48"oc	2x	N/A	N/A	242
SW-4	ONE SIDE	8d @ 4"oc	LTP4 @ 22"oc	7"oc	15"oc	48"oc	3x	5/8"oc	10"oc	353
SW-3	ONE SIDE	8d @ 3"oc	LTP4 @ 16"oc	5"oc	11"oc	36"oc	3x	4"oc	8"oc	456
SW-2	ONE SIDE	8d @ 2"oc	LTP4 @ 13"oc	4"oc	8"oc	27"oc	3x	(2) @ 6/8"oc	6/8"oc	595
SW-44	BOTH SIDES (NOTE 7)	8d @ 4"oc	LTP4 @ 11"oc	N/A	7"oc	23"oc	3x	(2) @ 5/8"oc	5/8"oc	706
SW-33	BOTH SIDES (NOTE 7)	8d @ 3"oc	LTP4 @ 8"oc	N/A	7"oc **	18"oc	3x	(2) @ 4"oc	4"oc	912
SW-22	BOTH SIDES (NOTE 7)	8d @ 2"oc	LTP4 @ 6"oc	N/A	5/8"oc **	13"oc	3x	(2) @ 3"oc ***	3"oc	1190

\* A35 OR LTP4 CAN BE USED ALTERNATIVELY  
 \*\* USE MIN 2x OF RIM BOARD AT THESE SHEARWALLS  
 \*\*\* FASTENERS SHALL BE STAGGERED


- NOTES:
- SHEATHING SHALL BE 1/2" OR 5/8" PLY, TYP UNO. OSB SHALL NOT BE SUBSTITUTED FOR PLYWOOD. SHEATHING SHALL HAVE A MINIMUM SPAN RATING OF 24/0.
  - SHEATHING SHALL BE APPLIED DIRECTLY TO FRAMING.
  - PROVIDE SOLID BLOCKING AT ALL SHEATHING PANEL EDGES.
  - PROVIDE 8d @ 12"oc AT ALL INTERMEDIATE SUPPORTS (FIELD NAIL), TYP UNO.
  - NAILS PER GENERAL STRUCTURAL NOTES.
  - LATERAL TIE PLATES OR WALL PLATE TO BLOCKING NAILING IS REQUIRED WHERE SHEATHING IS DISCONTINUOUS, I.E. WHERE ADJACENT SHEATHING EDGES ARE NOT NAILED TO THE SAME PIECE OF FRAMING. TIE NAILING IS NOT PERMITTED. LATERAL TIE PLATES MAY BE SUBSTITUTED FOR WALL PLATE TO BLOCKING NAILING. INSTALL LATERAL TIE PLATES OVER APA RATED SHEATHING PANELS. USE COMMON NAILS OR EQUIVALENT NAILS SUPPLIED BY CONNECTOR MANUFACTURER FOR LATERAL TIE PLATES. A35 FRAMING ANCHORS MAY BE SUBSTITUTED FOR LATERAL TIE PLATES AT SPACING SHOWN IN TABLE.
  - WHERE SHEATHING IS APPLIED TO BOTH SIDES OF WALL, STAGGER PLYWOOD JOINTS SO THAT JOINTS ON EACH SIDE OF THE WALL DO NOT OCCUR AT THE SAME STUD. PROVIDE 3x BLOCKING FOR ALL DOUBLE SHEATHED WALLS.
  - PROVIDE SHEAR WALL SHEATHING AND NAILING FOR ENTIRE LENGTH OF WALLS NOTED ON PLANS. ENDS OF WALLS ARE DESIGNATED BY EXTERIOR OF BUILDING, CORRIDORS, OR DOORWAYS. PROVIDE HOLD-DOWNS PER PLANS AT EACH END OF WALL, UNO. PROVIDE EDGE NAILING TO STUD(S) GRIPPED BY HOLD-DOWN.
  - CRITERIA: 2012 IBC
  - HEM FIR LUMBER  
2500 psi CONCRETE MINIMUM  
ASTM A307 ANCHOR BOLTS WITH 2x3" EDGE DISTANCE IN CONCRETE AND 7" MINIMUM EMBEDMENT
  - INSTALL 3x3/4" PL WASHERS AT ALL ANCHOR BOLTS, BETWEEN THE NUT AND THE SILL PLATE. USE 4/8"x4/8"x3/4" PL WASHERS WHERE 2x6 STUD WALLS ARE SHEATHED ON BOTH SIDES. ALL PLATE WASHERS SHALL EXTEND TO WITHIN 1/2" OF THE EDGE OF THE BOTTOM PLATE ON THE SIDE(S) WITH SHEATHING.
  - AT SHEARWALLS WHERE SHEATHING MAY EXTEND VERTICALLY TO OVERLAP WITH RIMBOARD/BLOCKING ABOVE, IT IS ACCEPTABLE TO NAIL SHEATHING TO RIMBOARD/BLOCKING WITH EDGE NAILING AS SPECIFIED IN TABLE ABOVE AND ELIMINATE THE A35 CLIPS BETWEEN THE RIMBOARD/BLOCKING AND WALL TOP PLATE.
  - FASTENERS IN CONTACT WITH TREATED WOOD SHALL BE CORROSION RESISTANT.
  - 1/2" MIN LSL RIM BOARD AND SINGLE SILL PLATE ARE ASSUMED. IF RIM MATERIAL IS DIFFERENT, NOTIFY ENGINEER FOR REVISED SCHED. IF (2)2x SILL PLATES ARE USED, USE SDS 0.220"x6" SCREWS. CONTRACTOR CAN SELECT EITHER NAILS OR SCREWS.
  - (2)2x STUDS AND SILL PLATES CAN BE USED INSTEAD OF 3x MEMBERS. (2)2x STUDS WILL NEED TO BE FASTENED TOGETHER WITH EITHER NAILS OR SCREWS AS CALLED OUT.

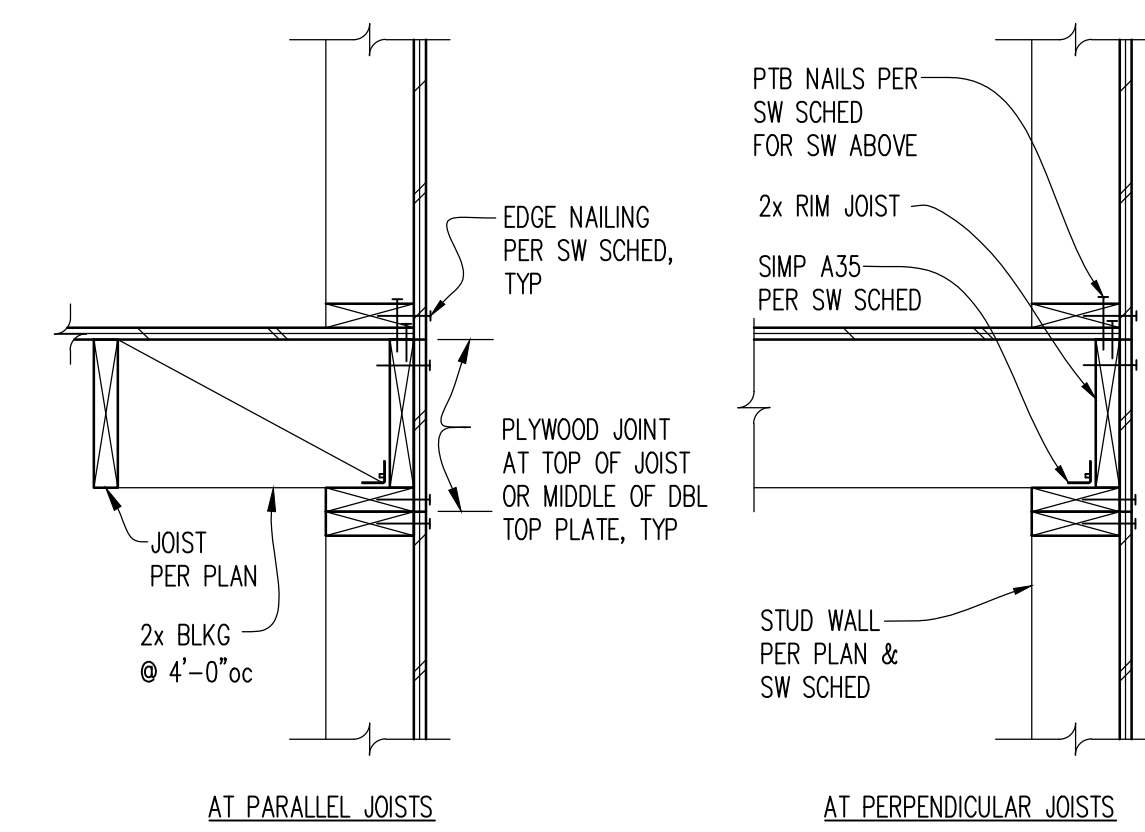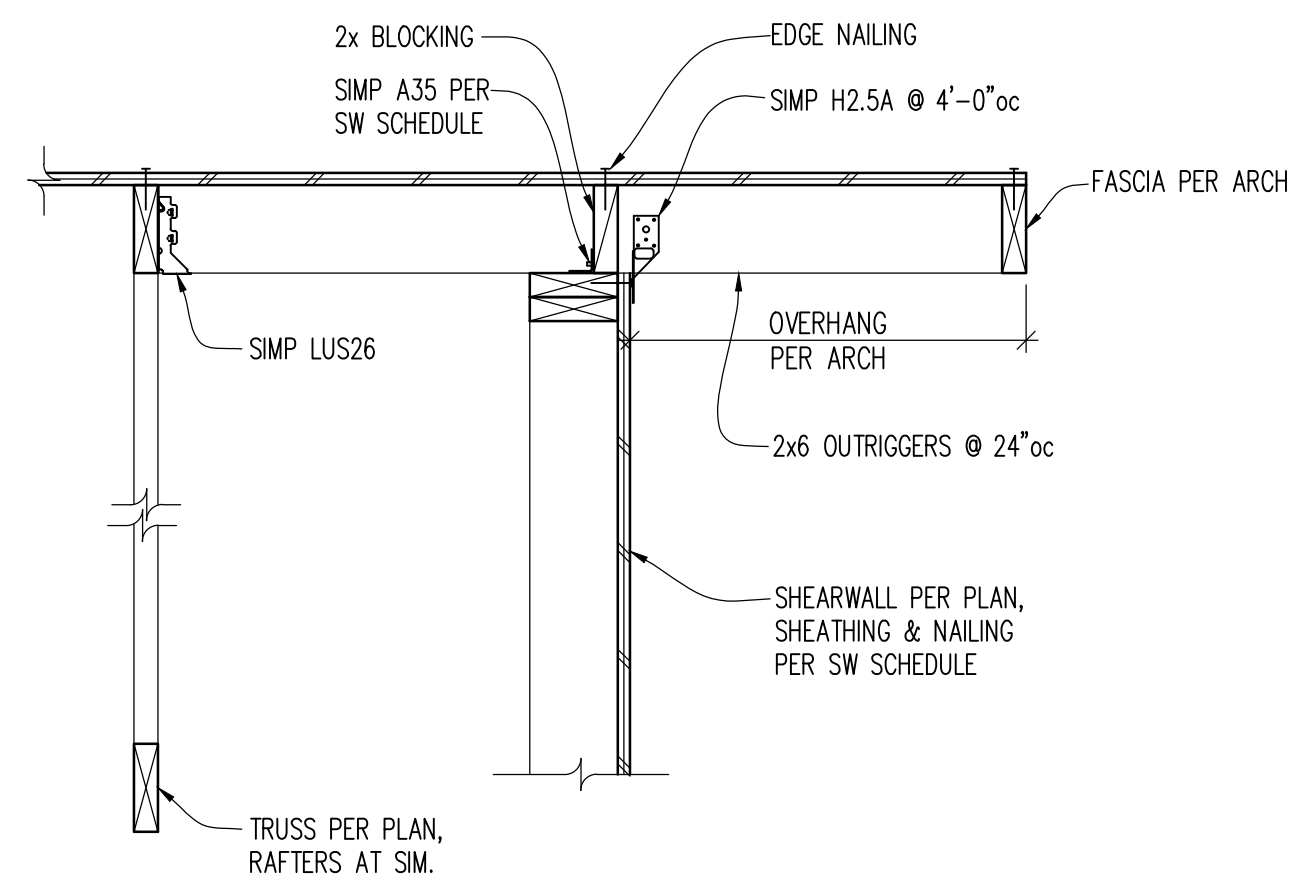


SHEAR WALL SCHEDULE (HEM FIR LUMBER)

MARK	FASTENERS TO CONCRETE		FASTENERS TO WOOD STUDS OR POSTS		CHORD MEMBER SEE NOTES 2 AND 4	ANCHOR ALLOWABLE LOAD (LBS)
	ANCHOR # SEE NOTES 1, 5, 6, 7	BOLTS	SDS 3/4" x 2 1/2" SCREWS	16d COMMON NAILS SEE NOTE 5		
MSTC28	3" x 16 GA	-	-	(16) 16d	(2) 2x STUDS	1,330
MSTC40	3" x 16 GA	-	-	(32) 16d	(2) 2x STUDS	2,655
MSTC52	3" x 16 GA	-	-	(48) 16d	(2) 2x STUDS	3,985
MSTC66	3" x 14 GA	-	-	(68) 16d	(2) 2x STUDS	5,850
HDU2	3/8"	-	6	-	(2) 2x STUDS	2,215
HDU4	3/8"	-	10	-	(2) 2x STUDS	3,285
HDU5	3/8"	-	14	-	(2) 2x STUDS	4,340
HDU8	3/8"	-	20	-	6x6 DF	7,870
HDU11	1"	-	30	-	6x6 DF	9,335
HDU14	1"	-	36	-	6x6 DF	14,445


- NOTES:
- PROVIDE ASTM F1554 OR 36 HEAVY SQUARE HEAD ANCHORS FOR ALL HOLD-DOWNS.
  - WOOD MEMBERS (MIN), ABOVE AND BELOW WHERE STRAP OR HOLD-DOWN OCCURS AT FLOOR LEVEL.
  - HOLD-DOWN SCHEDULE IS PROVIDED FOR GENERAL INSTALLATION INFORMATION. NOT ALL HARDWARE SCHEDULED IS REQUIRED. SEE PLANS FOR HOLD-DOWN CALL-OUTS AND LOCATIONS. CONSULT MANUFACTURER FOR ADDITIONAL INFORMATION.
  - IF SHEAR WALL REQUIRES 3x STUDS, USE MIN (2) 3x STUDS INSTEAD OF (2) 2x STUDS.
  - QUANTITY OF NAILS FOR STRAPS ARE EVENLY DIVIDED BETWEEN ENDS OF STRAPS ABOVE AND BELOW THE DEPTH OF THE FLOOR SYSTEM. USE 16d COMMON NAILS.
  - WHERE HOLD-DOWN OCCURS ATOP BEAM WITH NO STRUCTURE BELOW, SEE DETAIL 19/S4.1.
  - HOLD-DOWN DETAIL AT FLOOR-TO-FLOOR HOLD-DOWNS CONDITION PER 5/S4.2.
  - STRAP DETAIL AT FLOOR-TO-FLOOR STRAP CONDITION PER 8/S4.2.
  - IBC 2015, Fc = 2,500 PSI, HEM-FIR LUMBER.

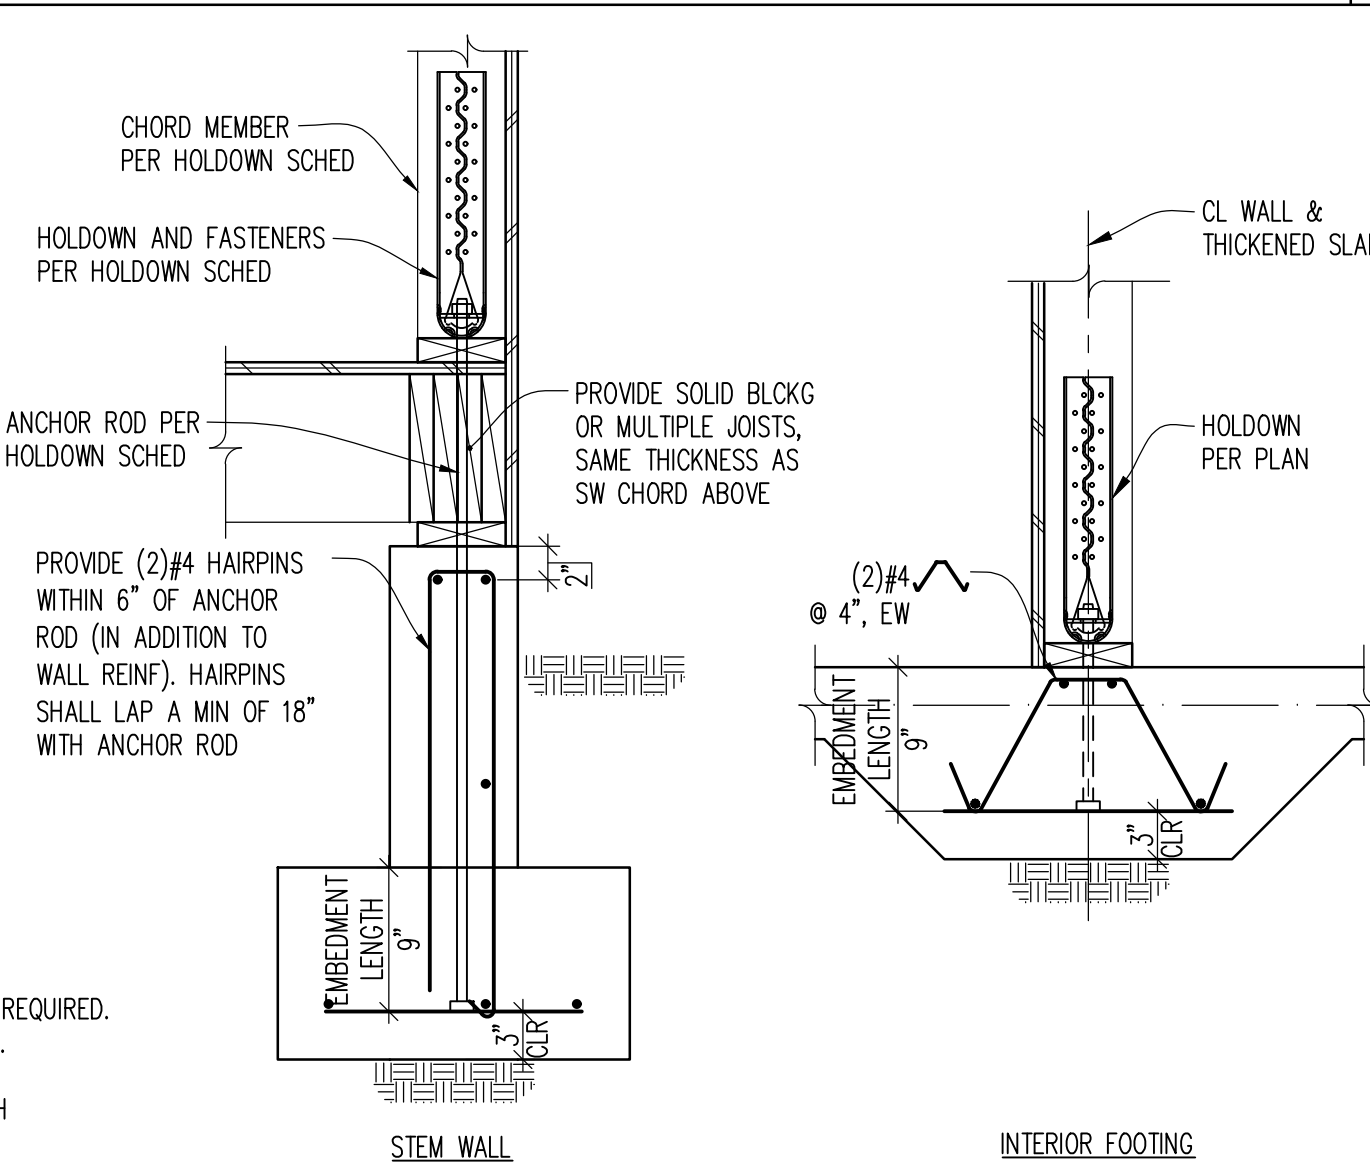


TYPICAL OUTRIGGER

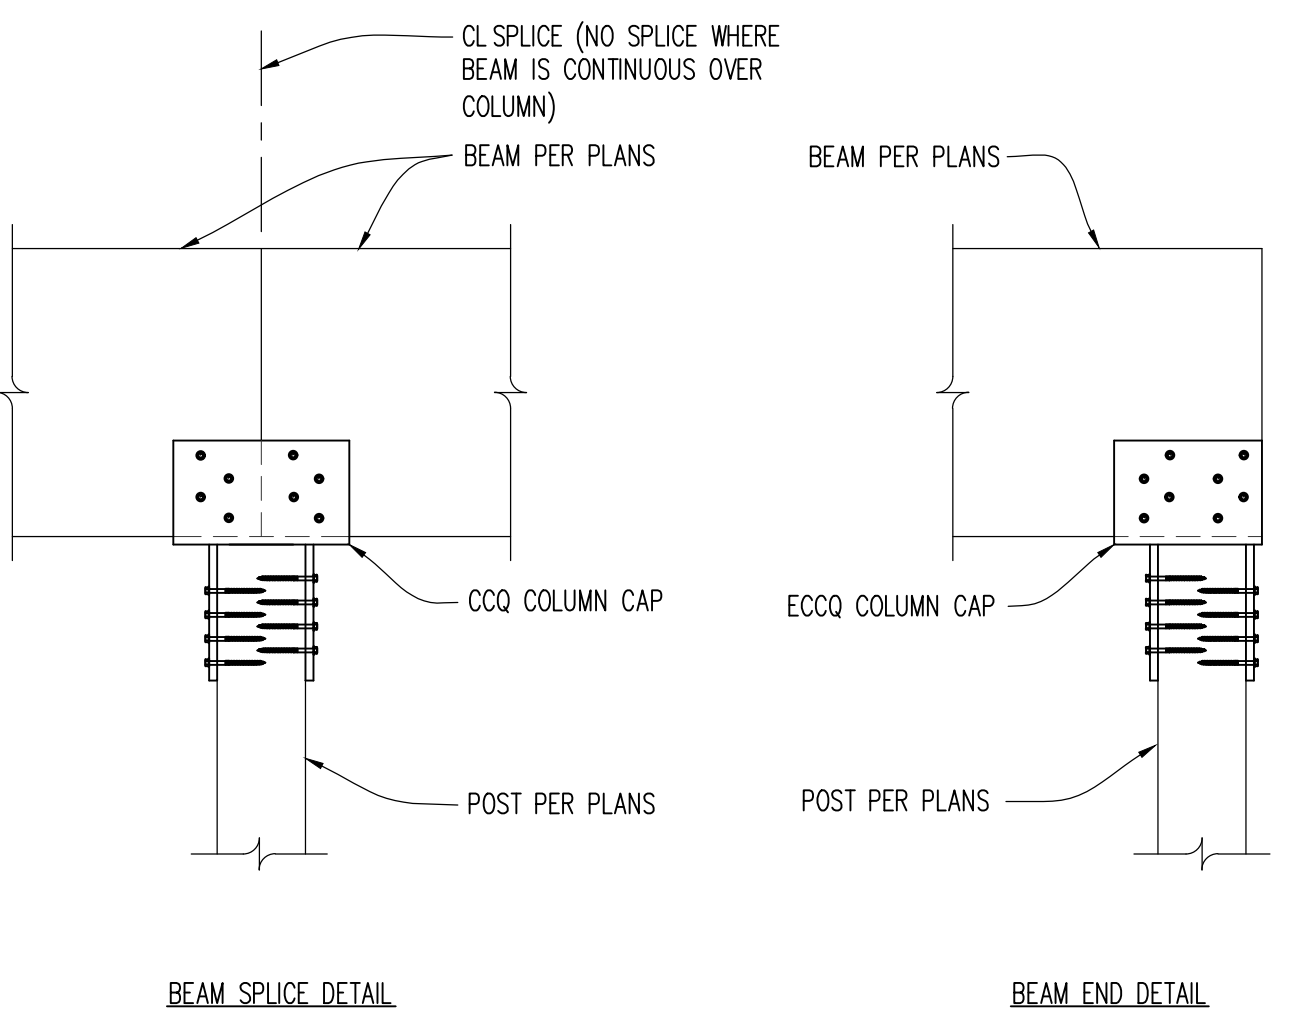


TYP WALL DETAIL

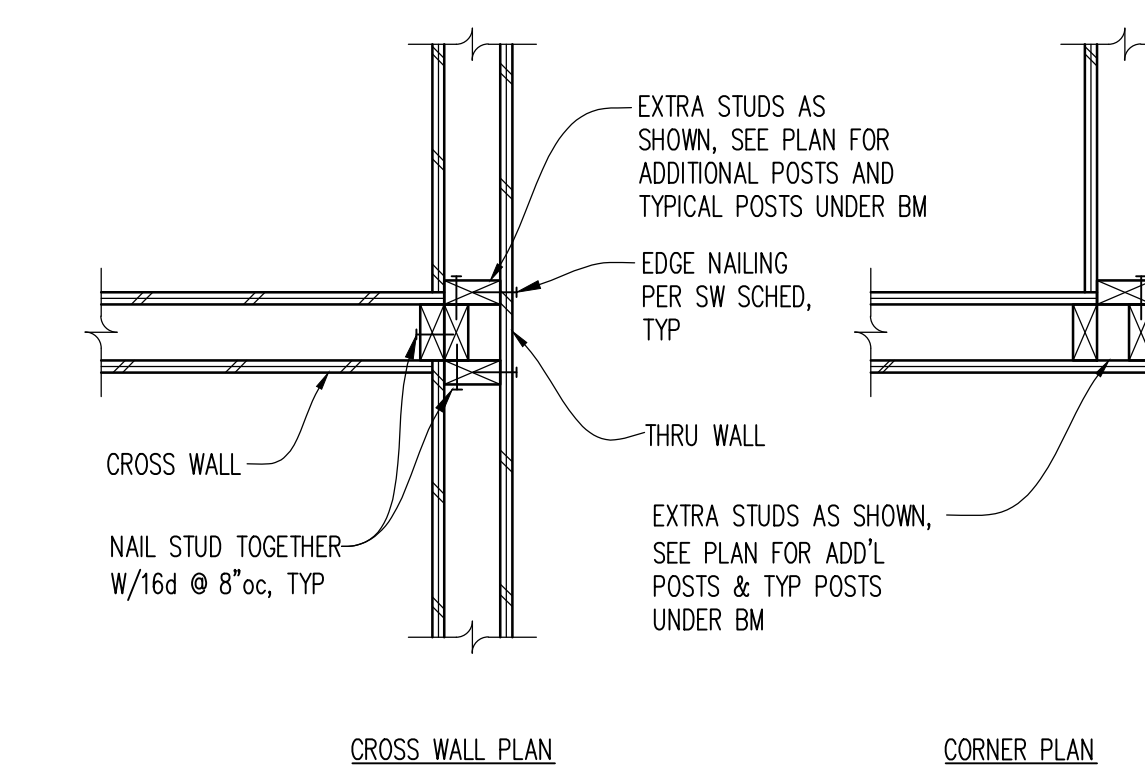


FLOOR TO FLOOR HOLD-DOWN STRAP

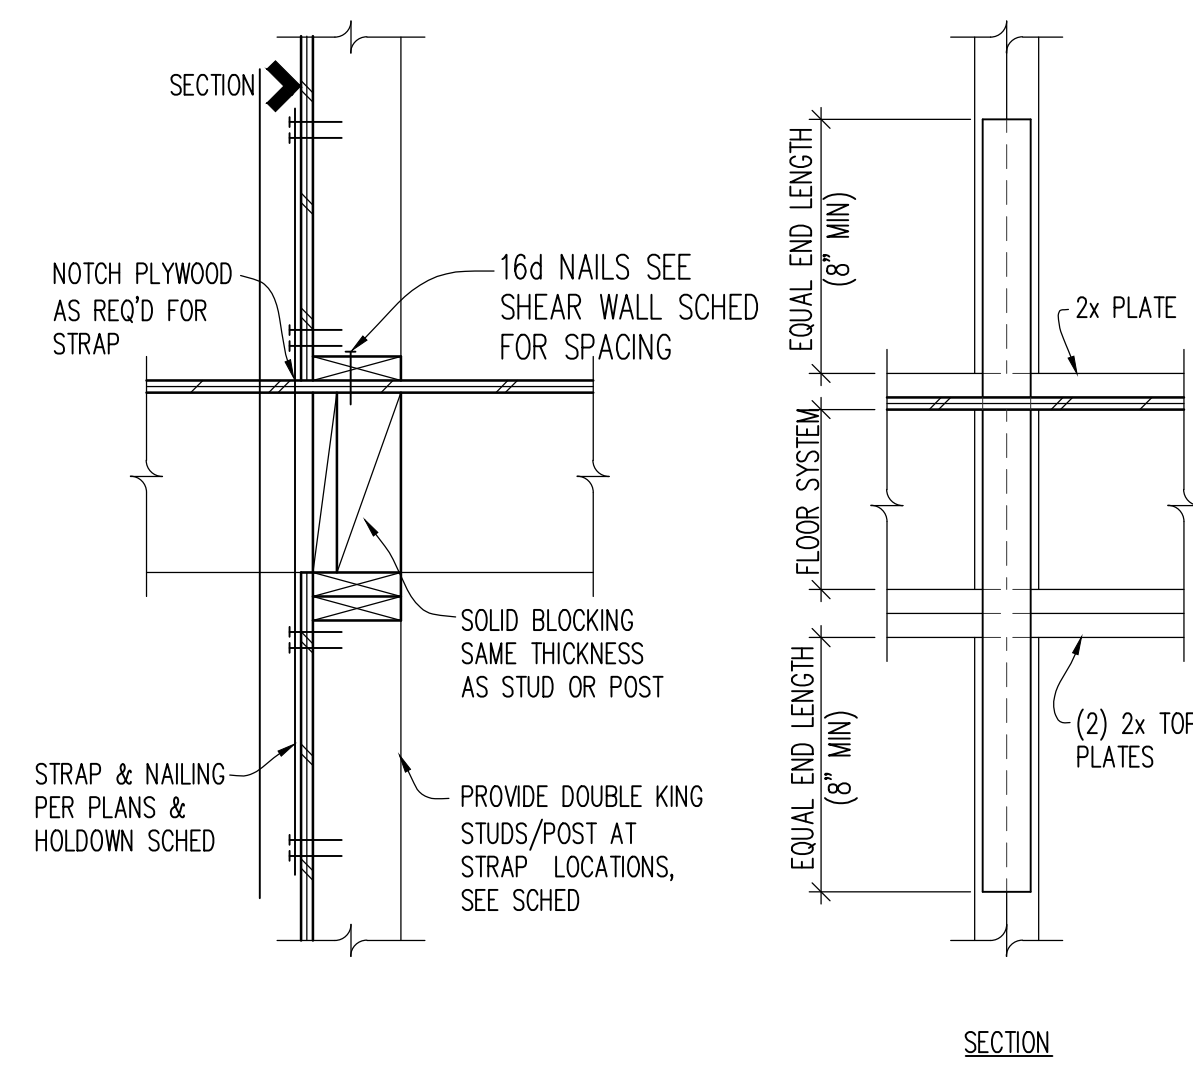


SHEAR WALL SCHEDULE (HEM FIR LUMBER)

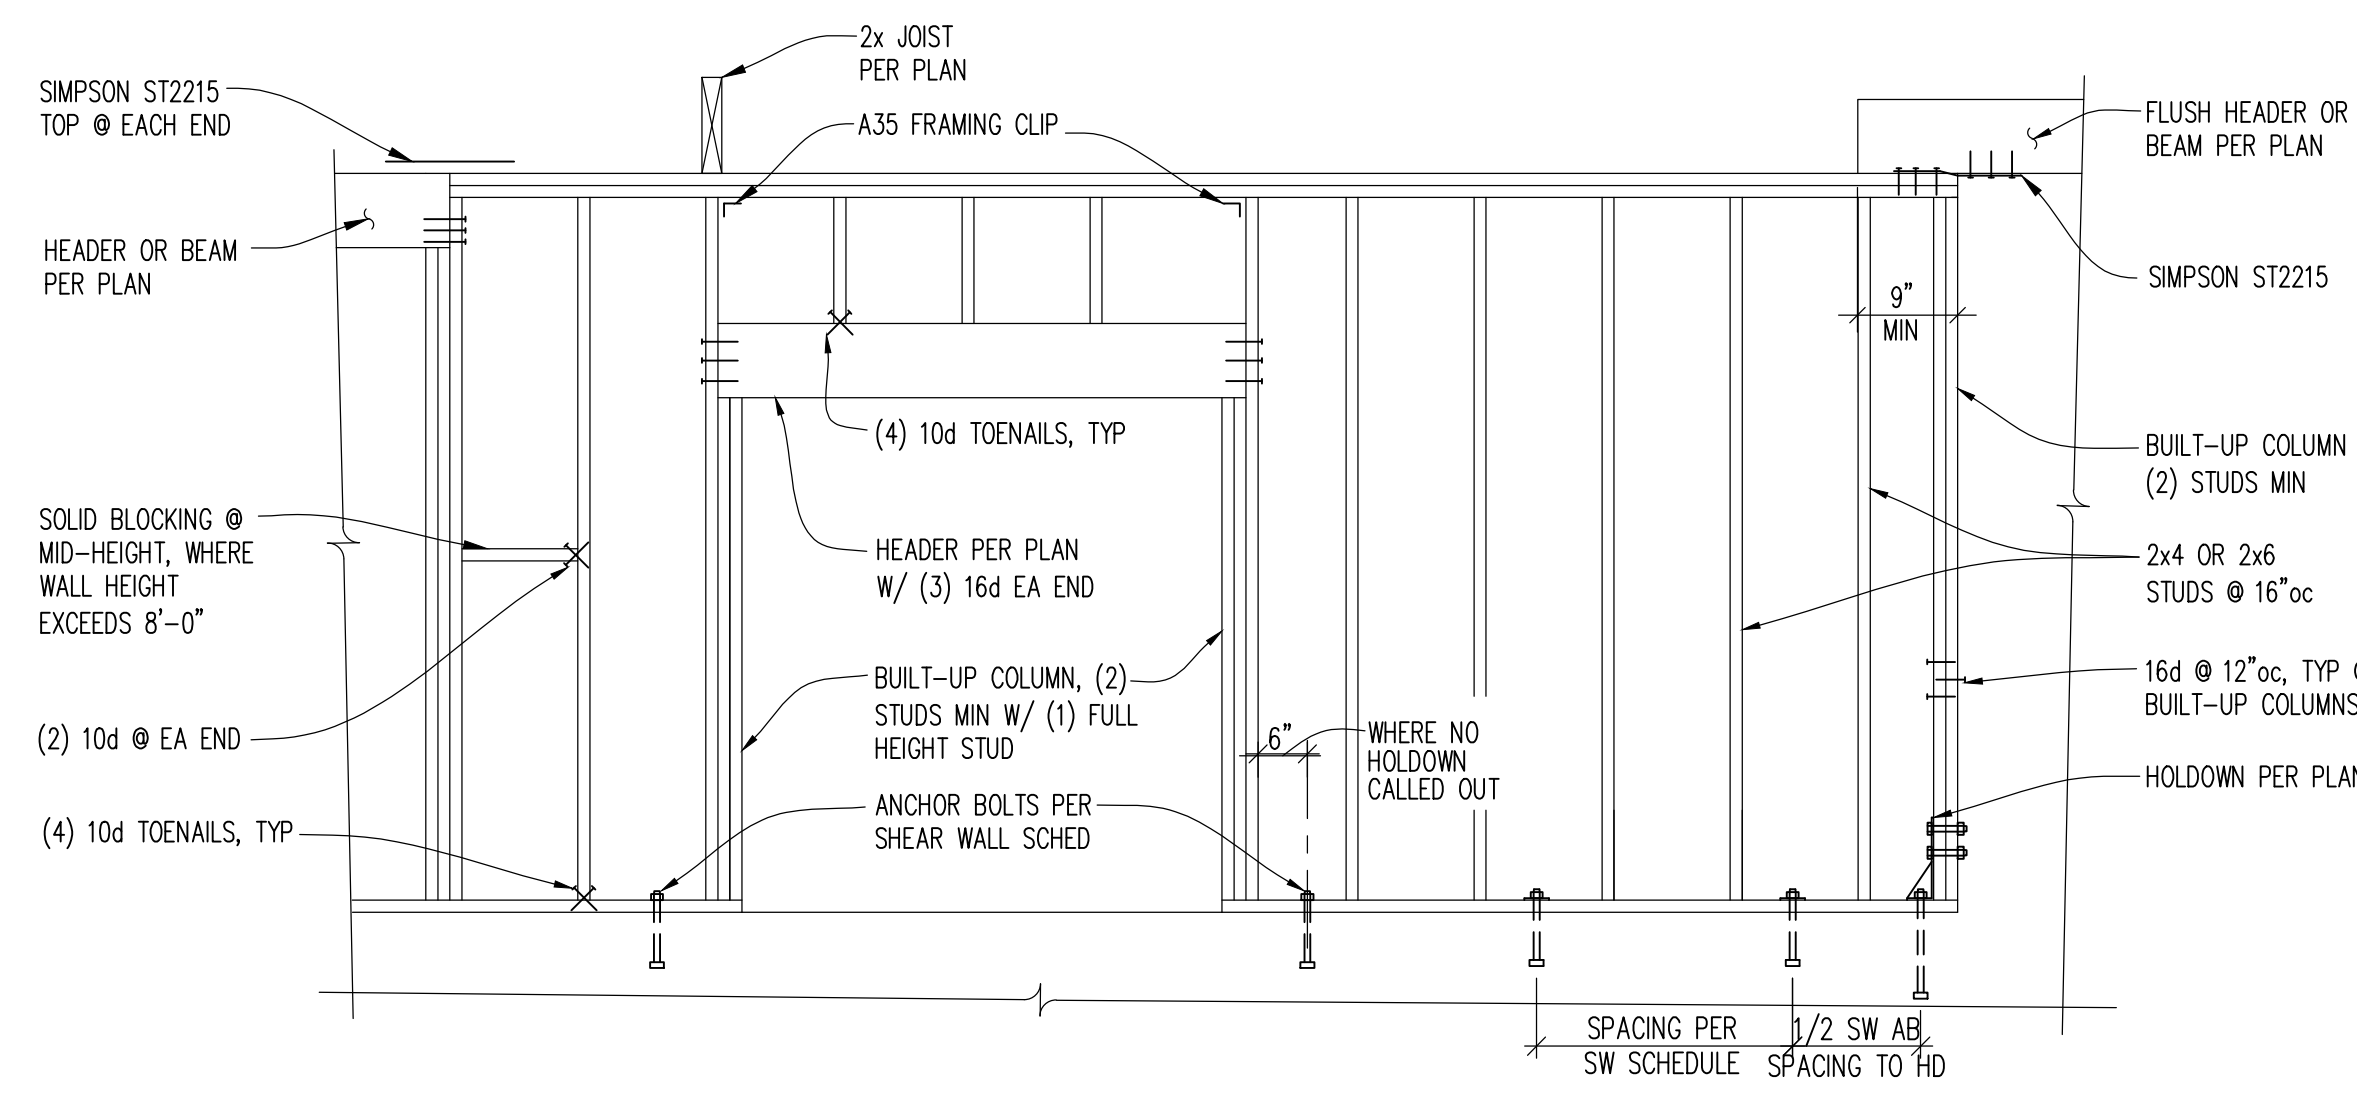


TYP. COLUMN CAP DETAILS

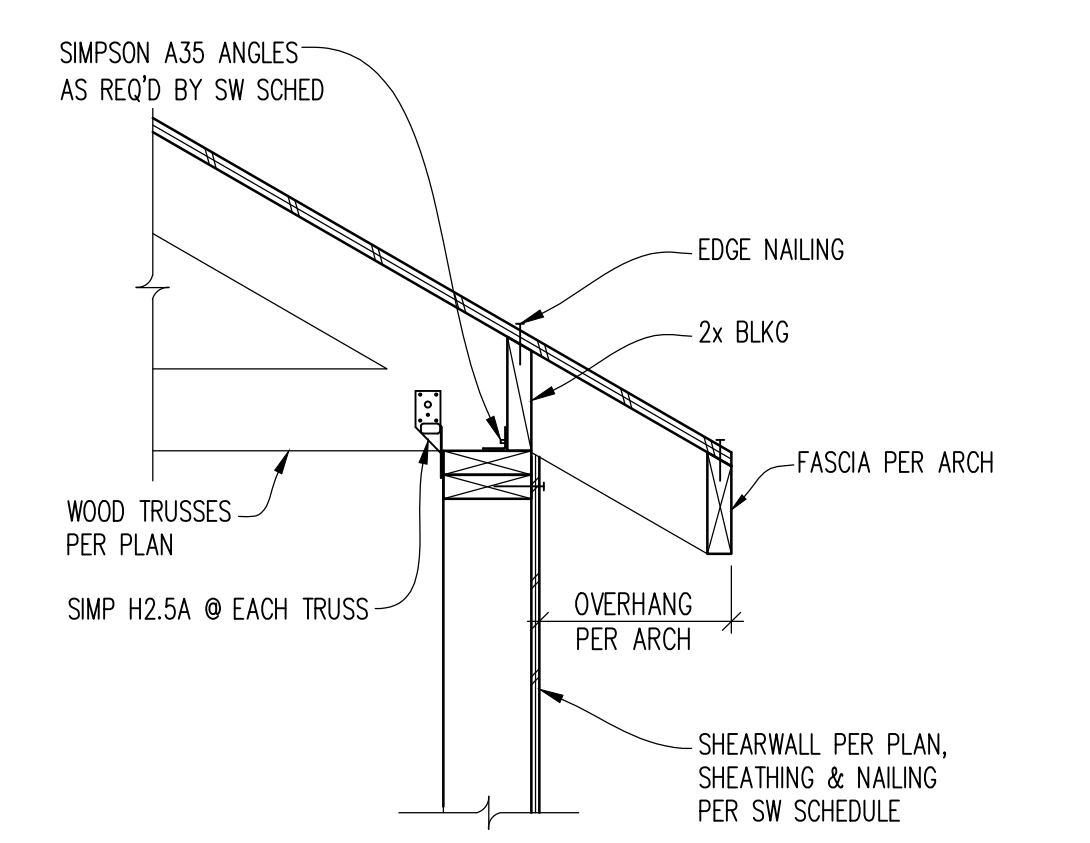


TYPICAL SHEAR WALL INTERSECTION

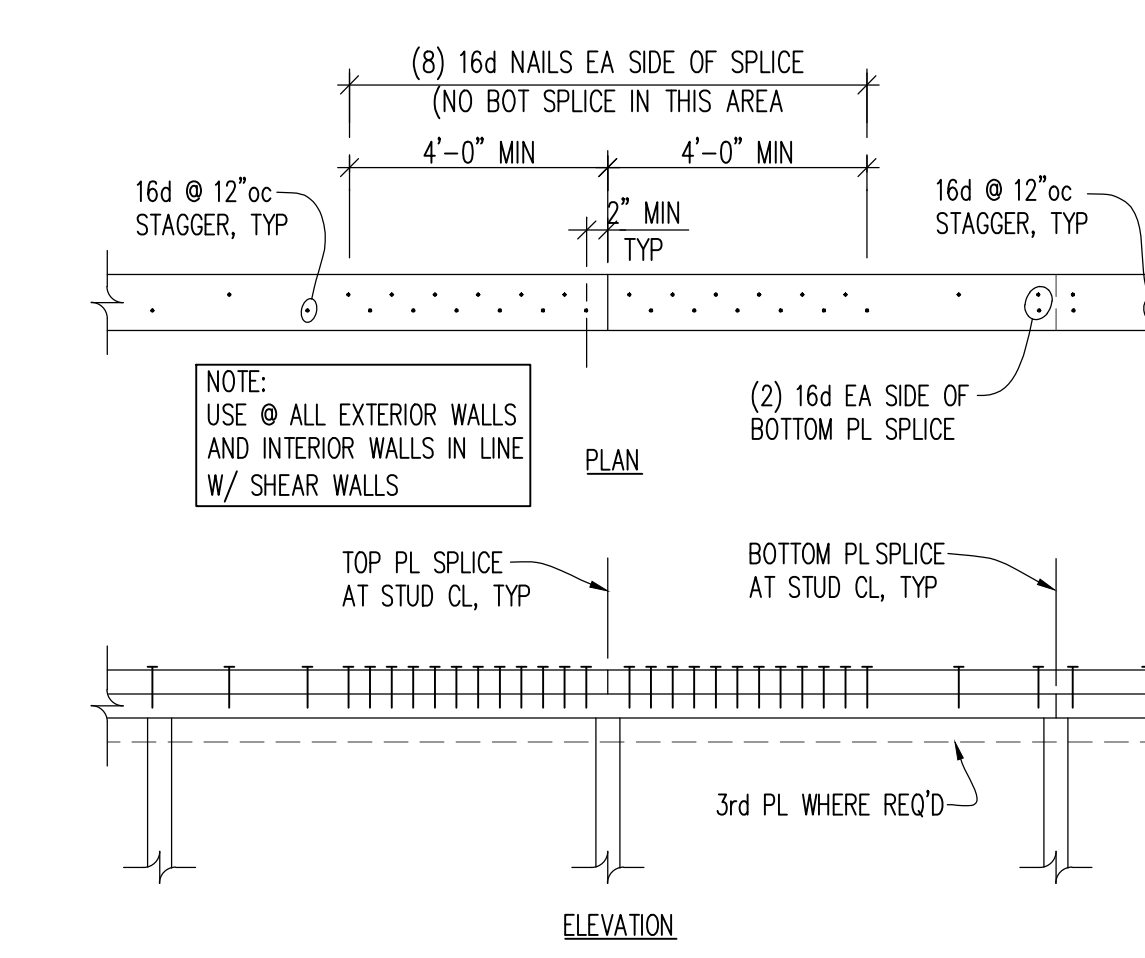


DETAIL

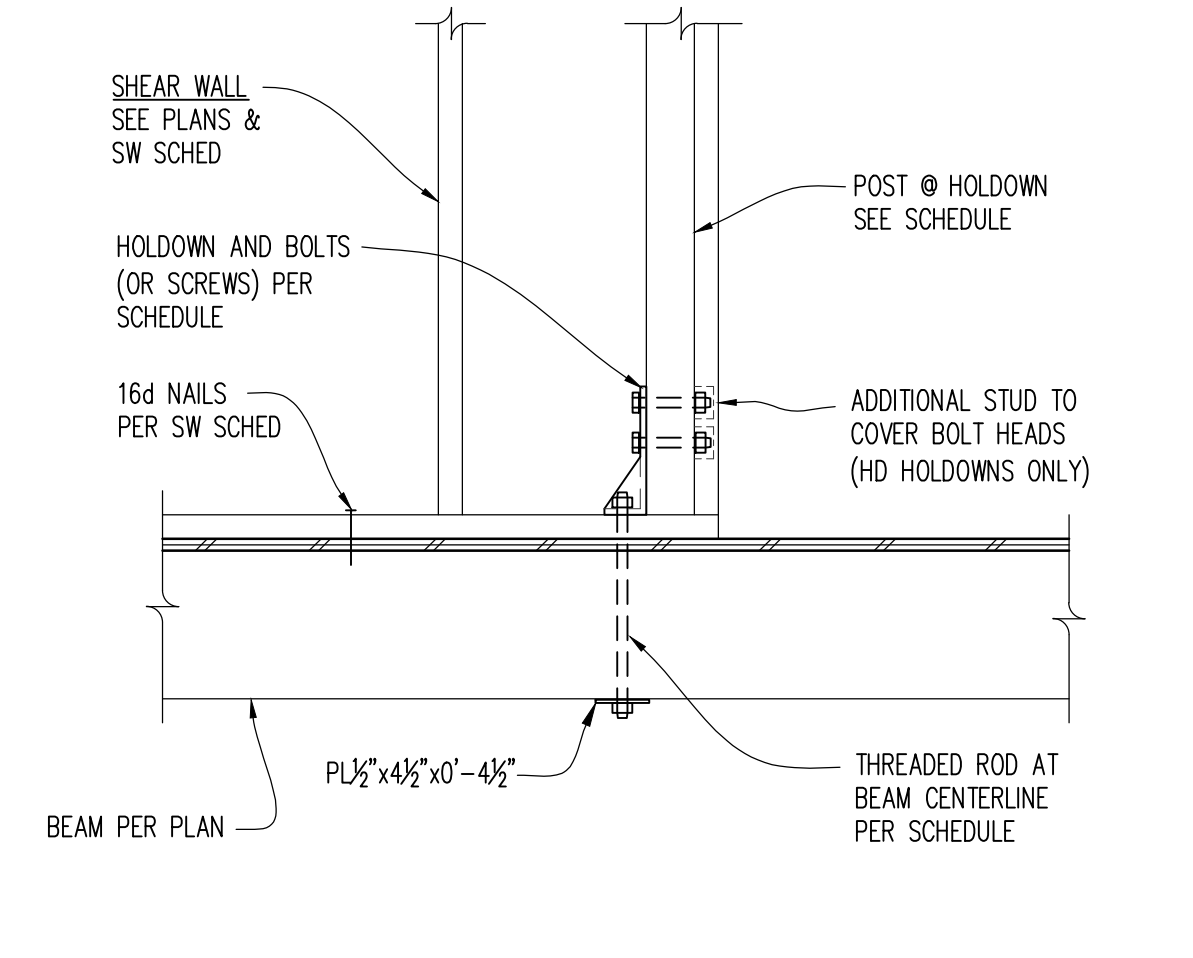


TYPICAL FLOOR SHEATHING

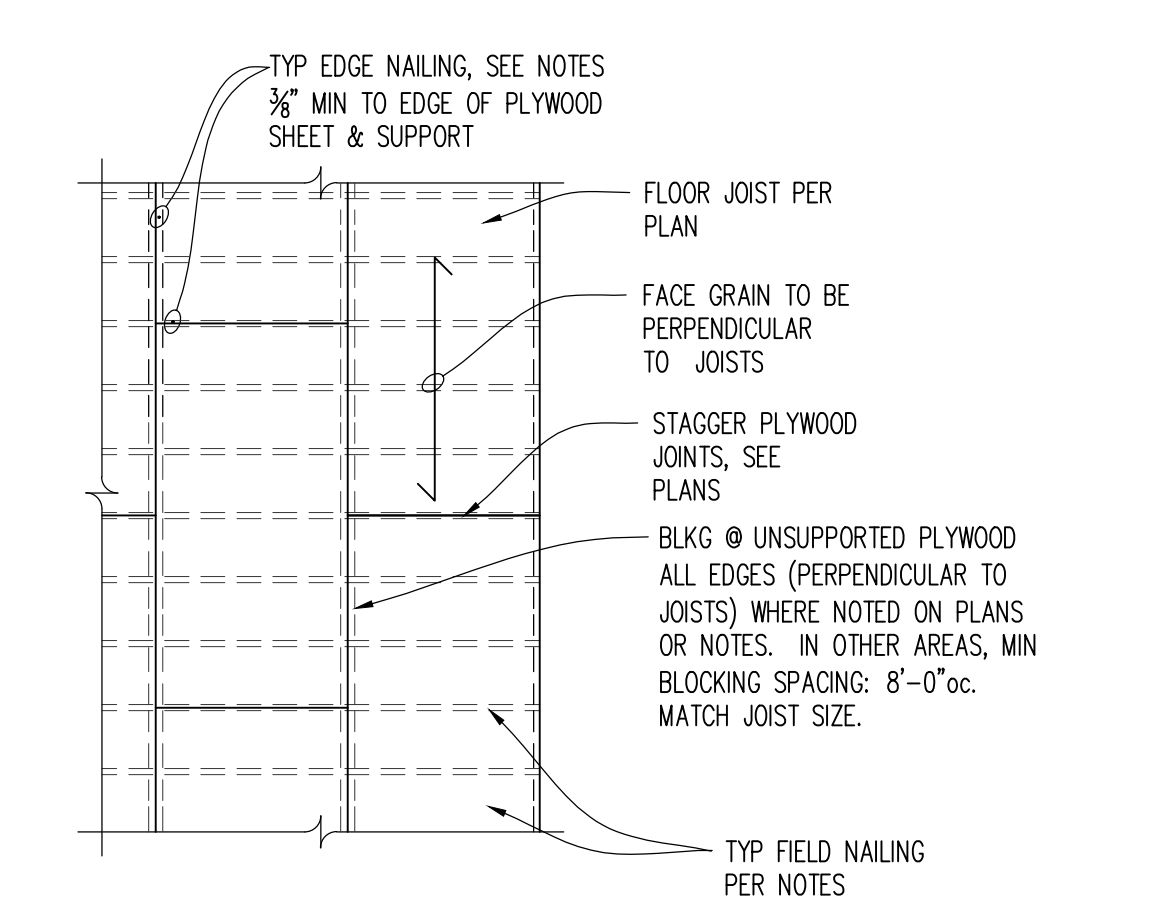


TYPICAL SHEAR WALL SHEATHING

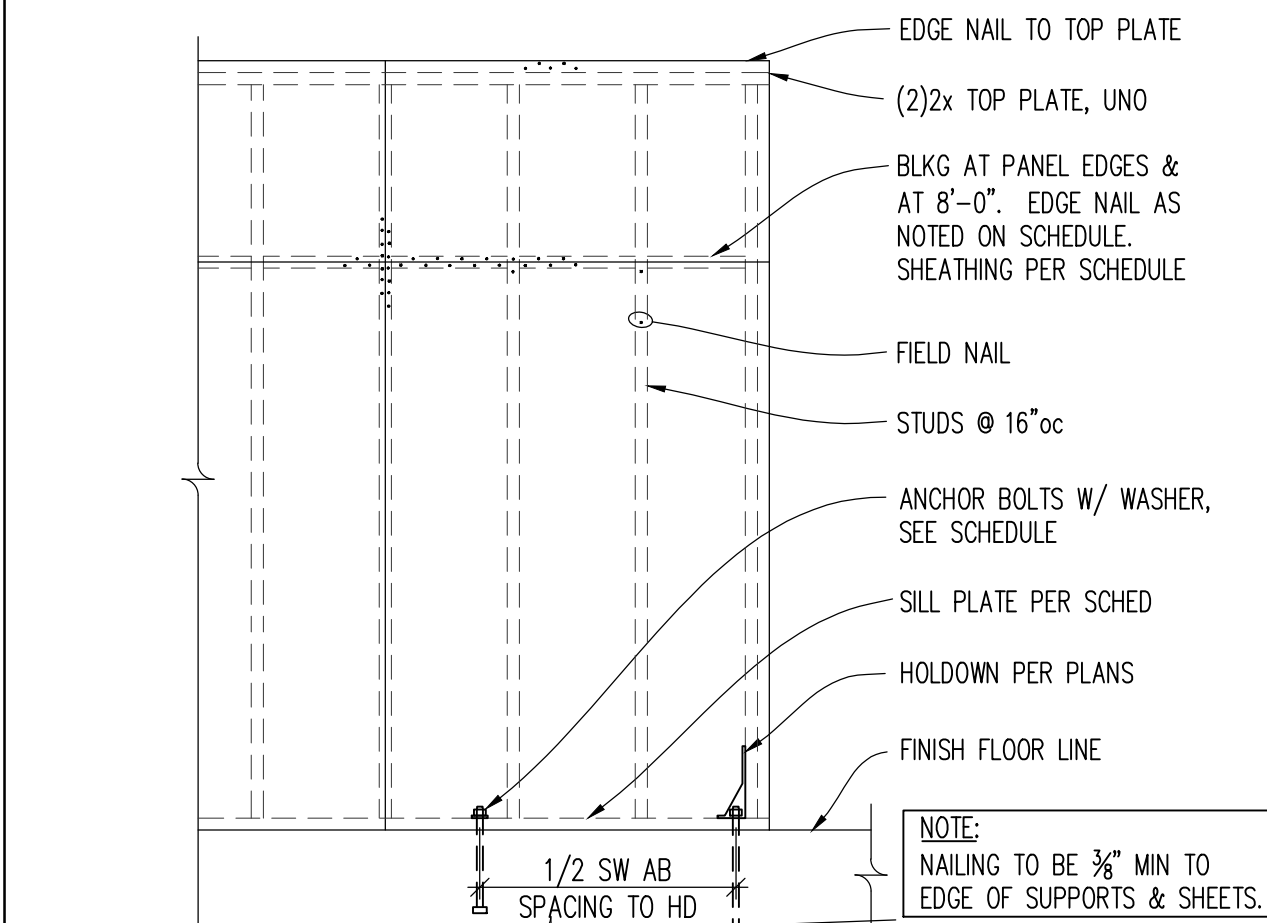


TYPICAL DOWNWARD EAVE

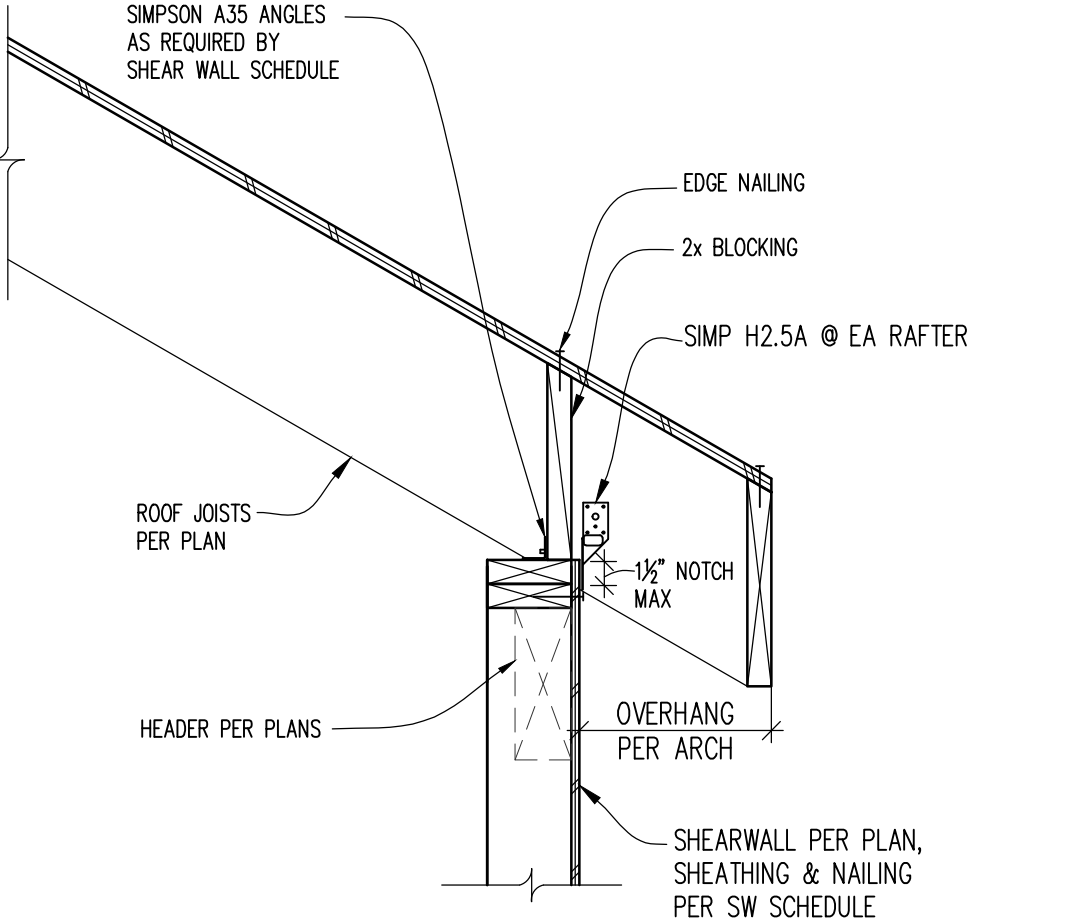

TYP STUD WALL TOP PLATE SPLICE

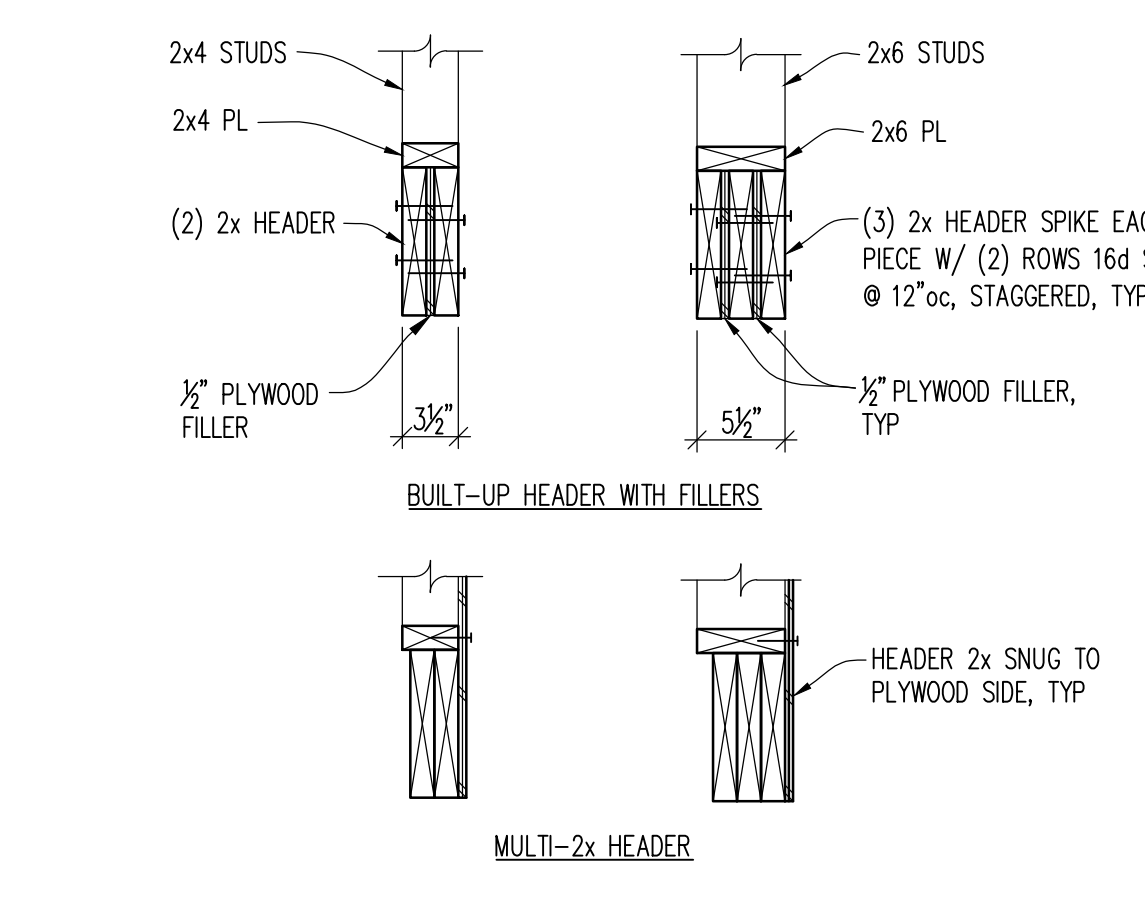

TYPICAL ROOF SHEATHING

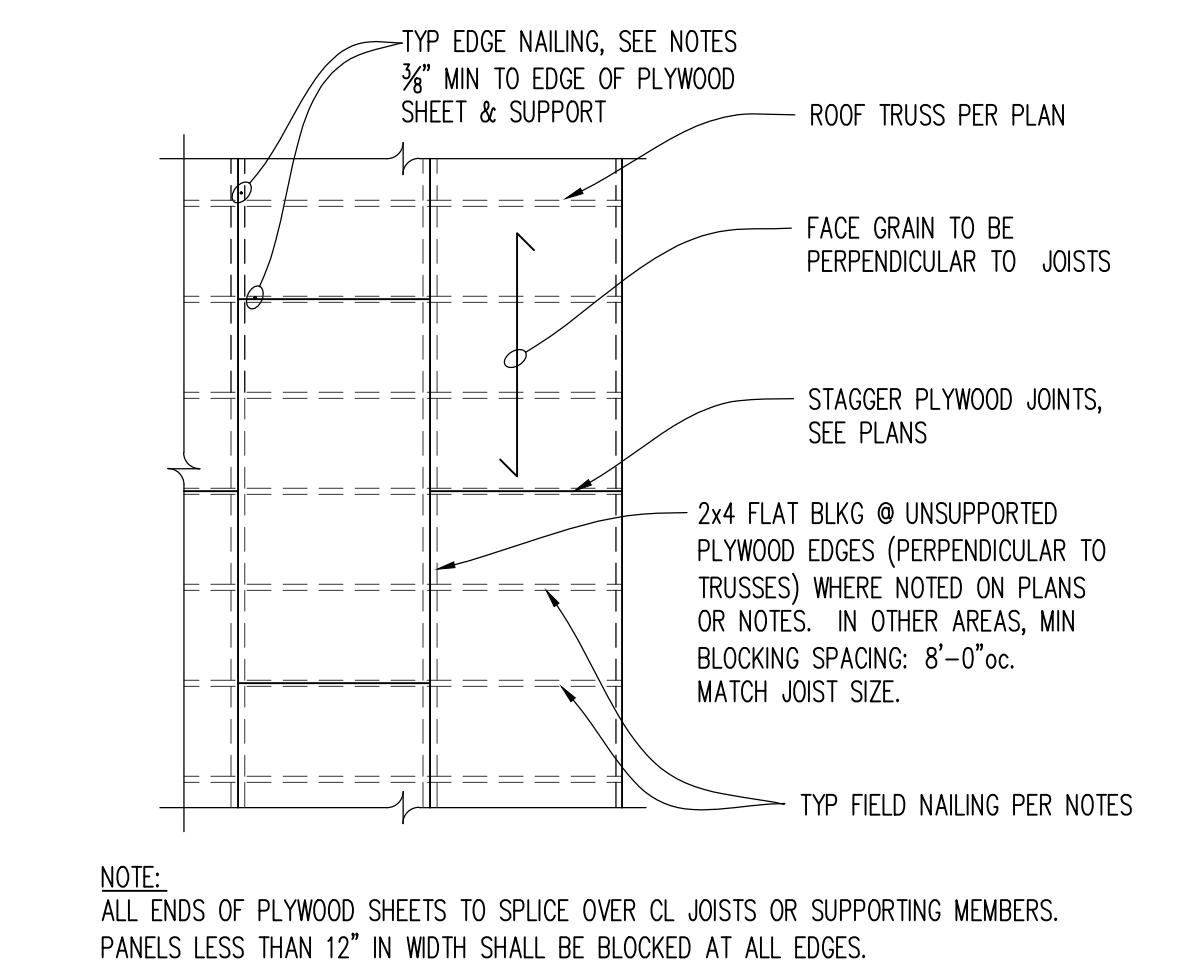

TYPICAL FLOOR SHEATHING



TYPICAL SHEAR WALL SHEATHING




TYPICAL DOWNWARD EAVE



TYPICAL BUILT-UP HEADER SECTIONS



REVISIONS	
NO.	DATE
114-20	PERMIT
20-129	JOB #
AM	DESIGN
LMS	DRAWN
FPP	CHECKED
AS NOTED	SCALE

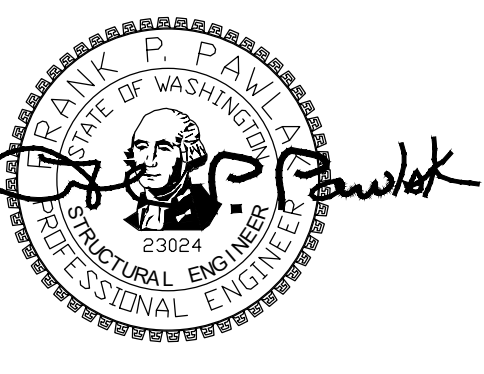

PROJECT

9820 SE 35TH PLACE  
ACHIN & MARY CHEN  
9820 SE 35TH PL  
MERCER ISLAND, WA 98040

REVISIONS

NO.	DATE	DESCRIPTION
114-20	PERMIT	

11/4/20	20-129
DATE	JOB #
AM	FPP
DESIGN	CHECKED
LMS	AS NOTED
DRAWN	SCALE


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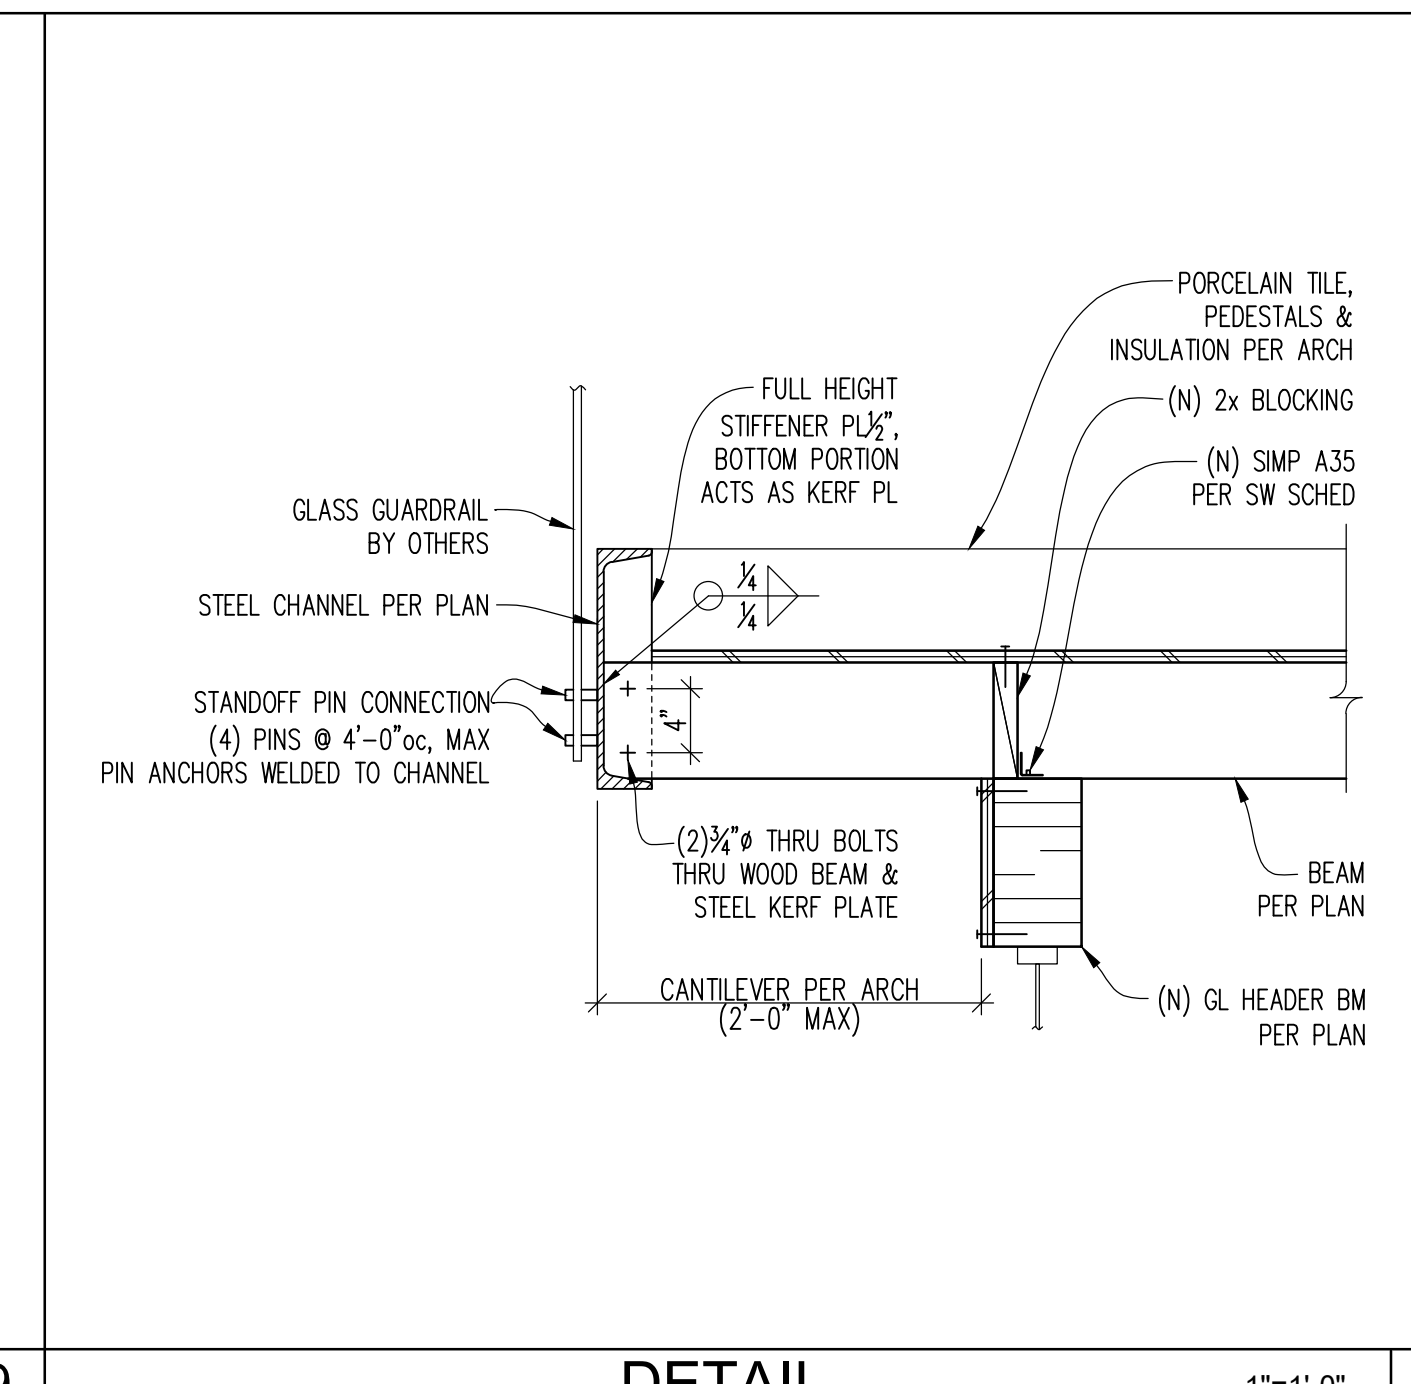
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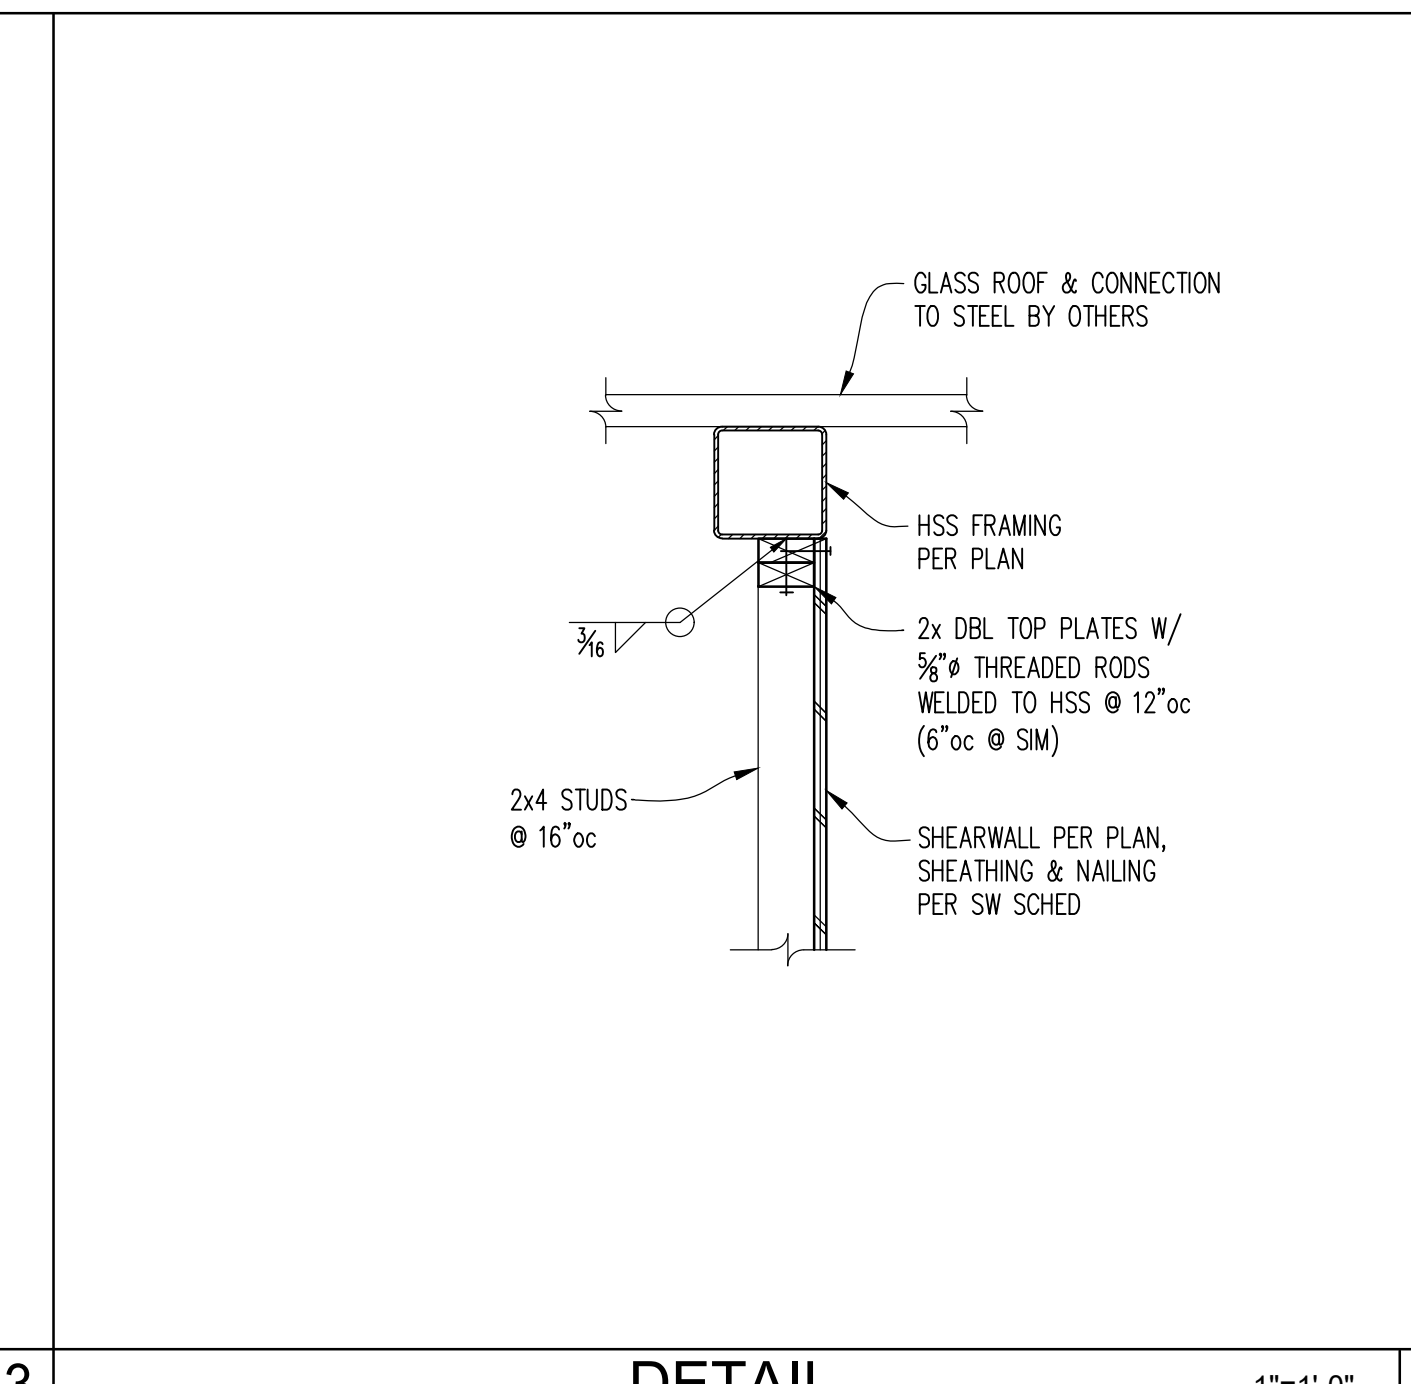
S4.2




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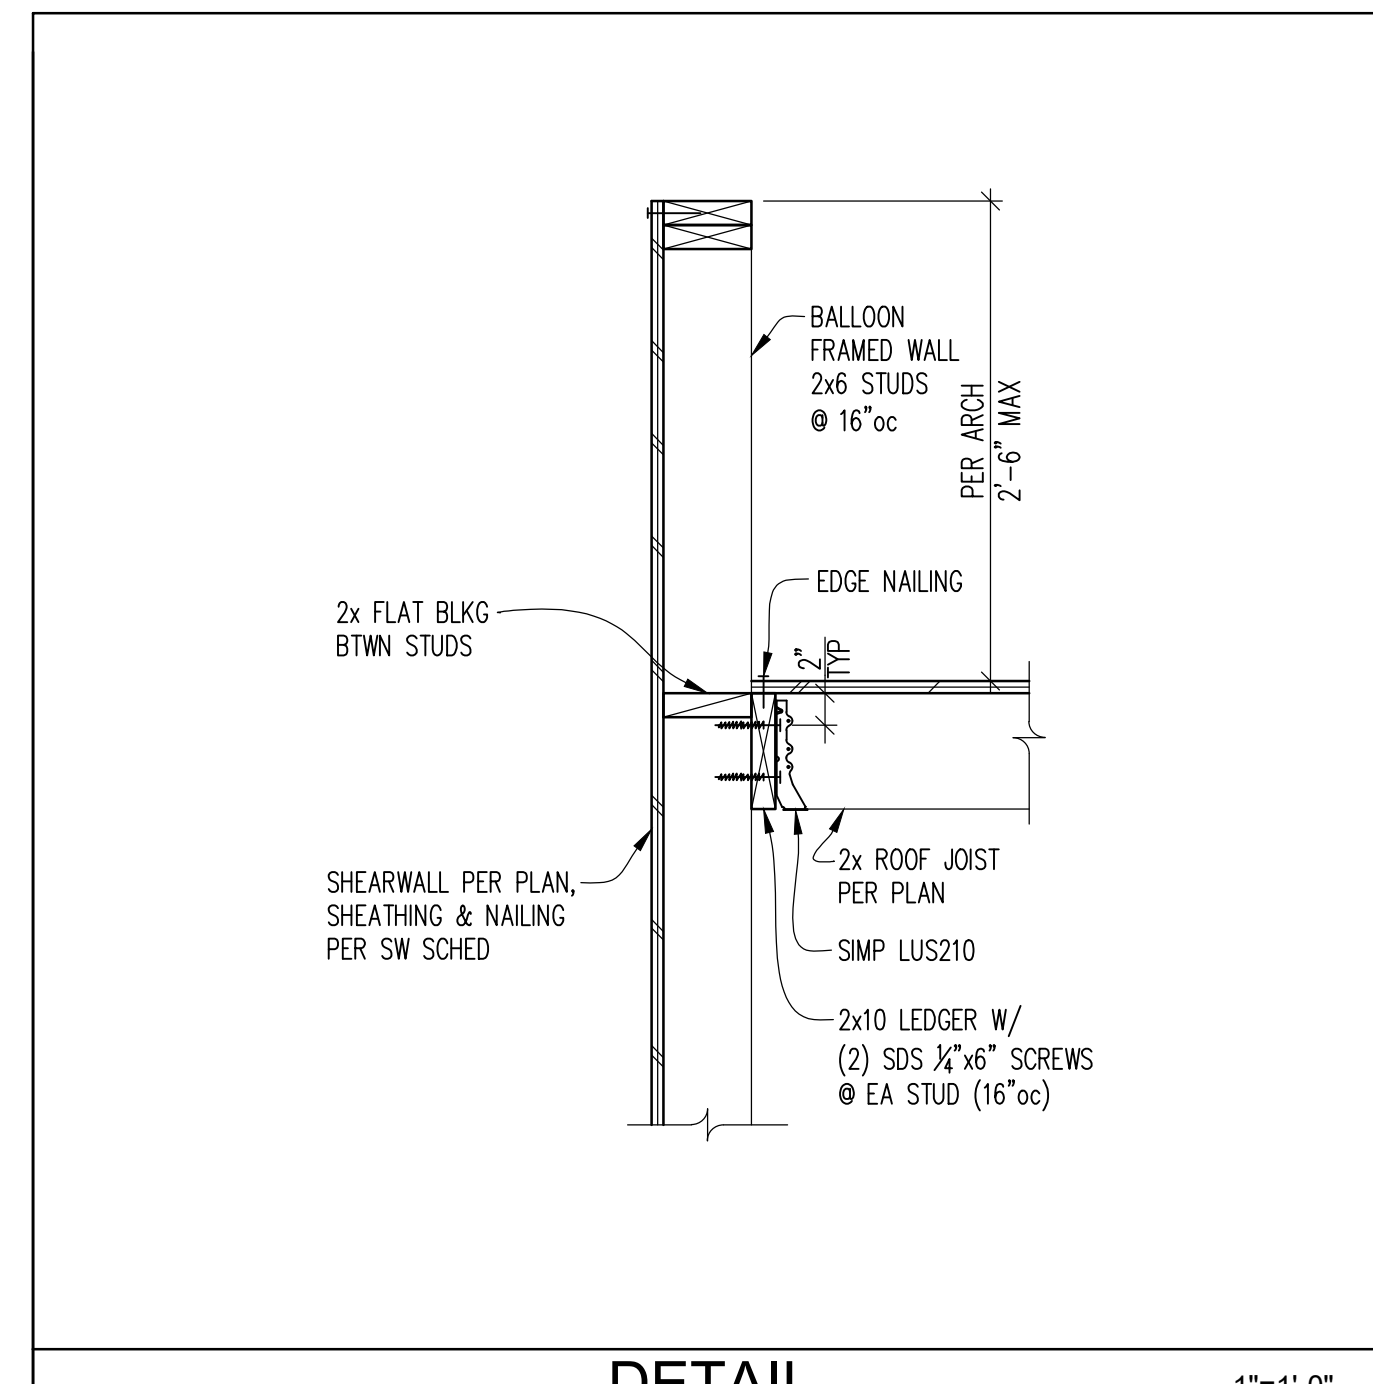
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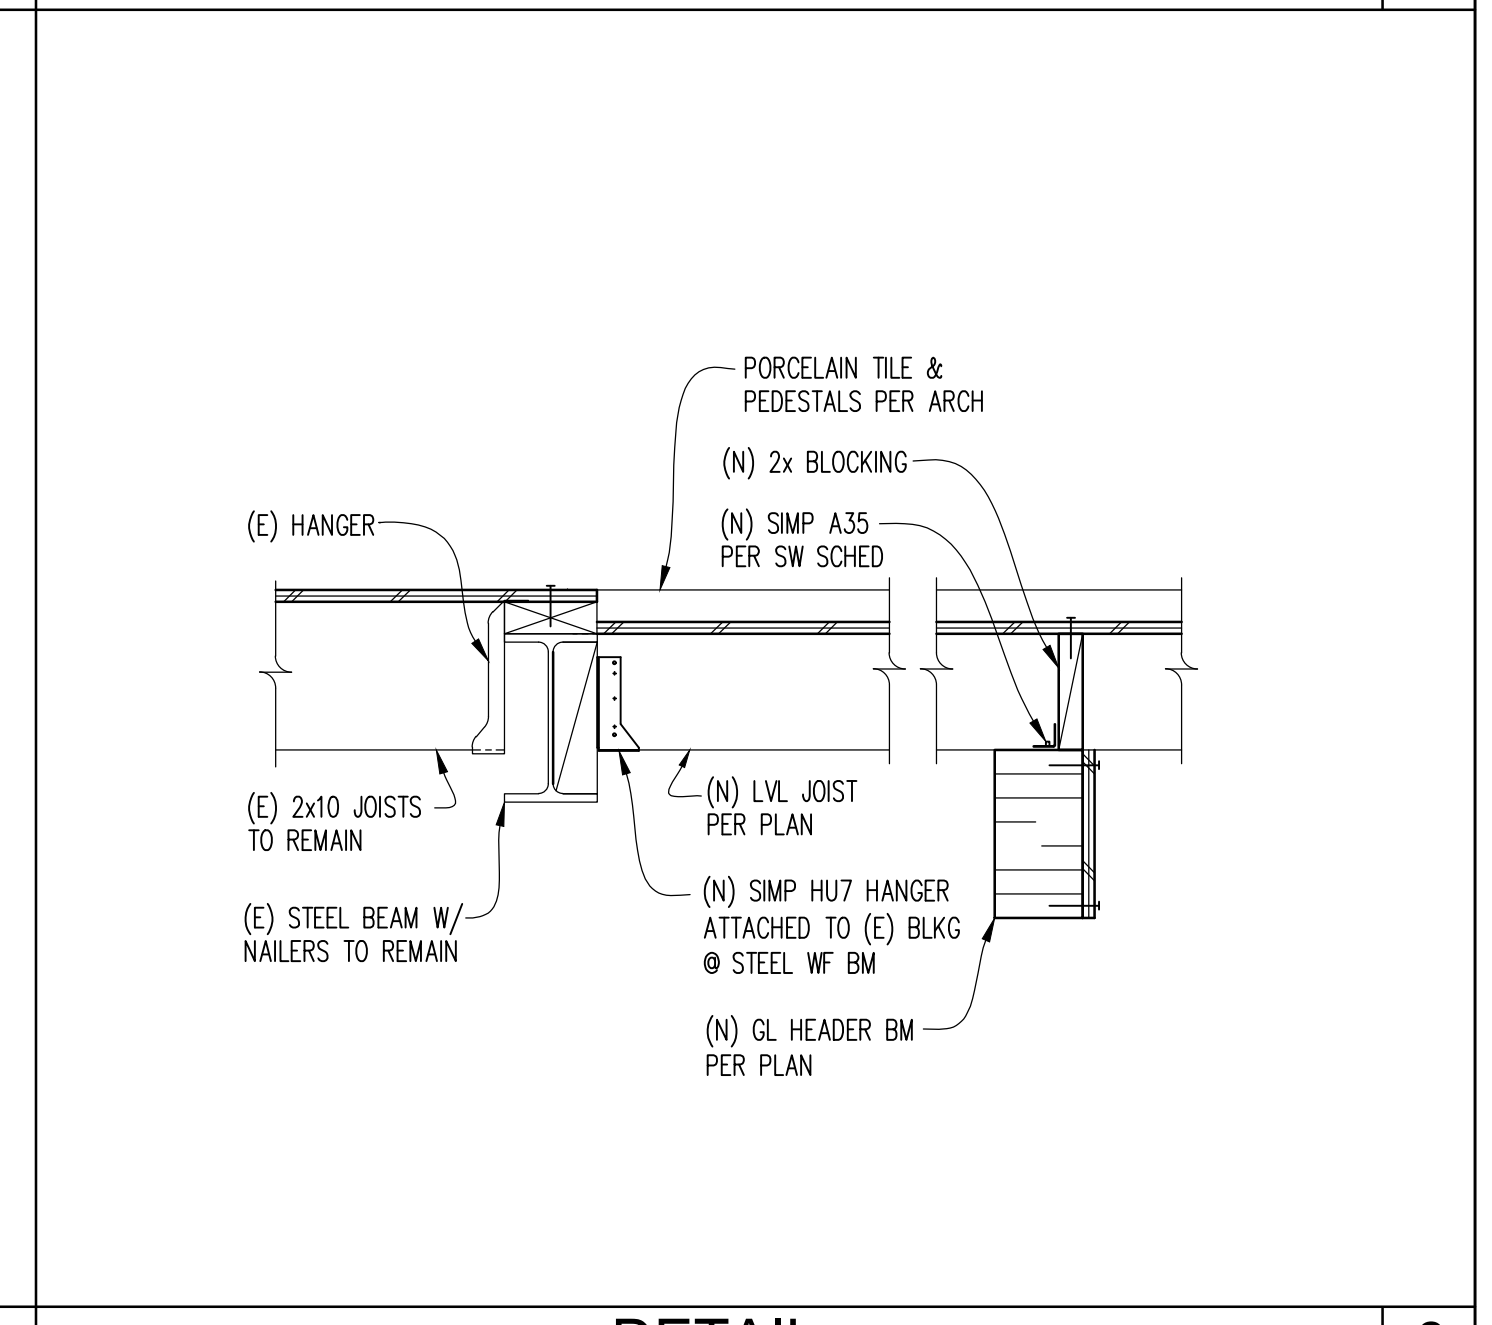
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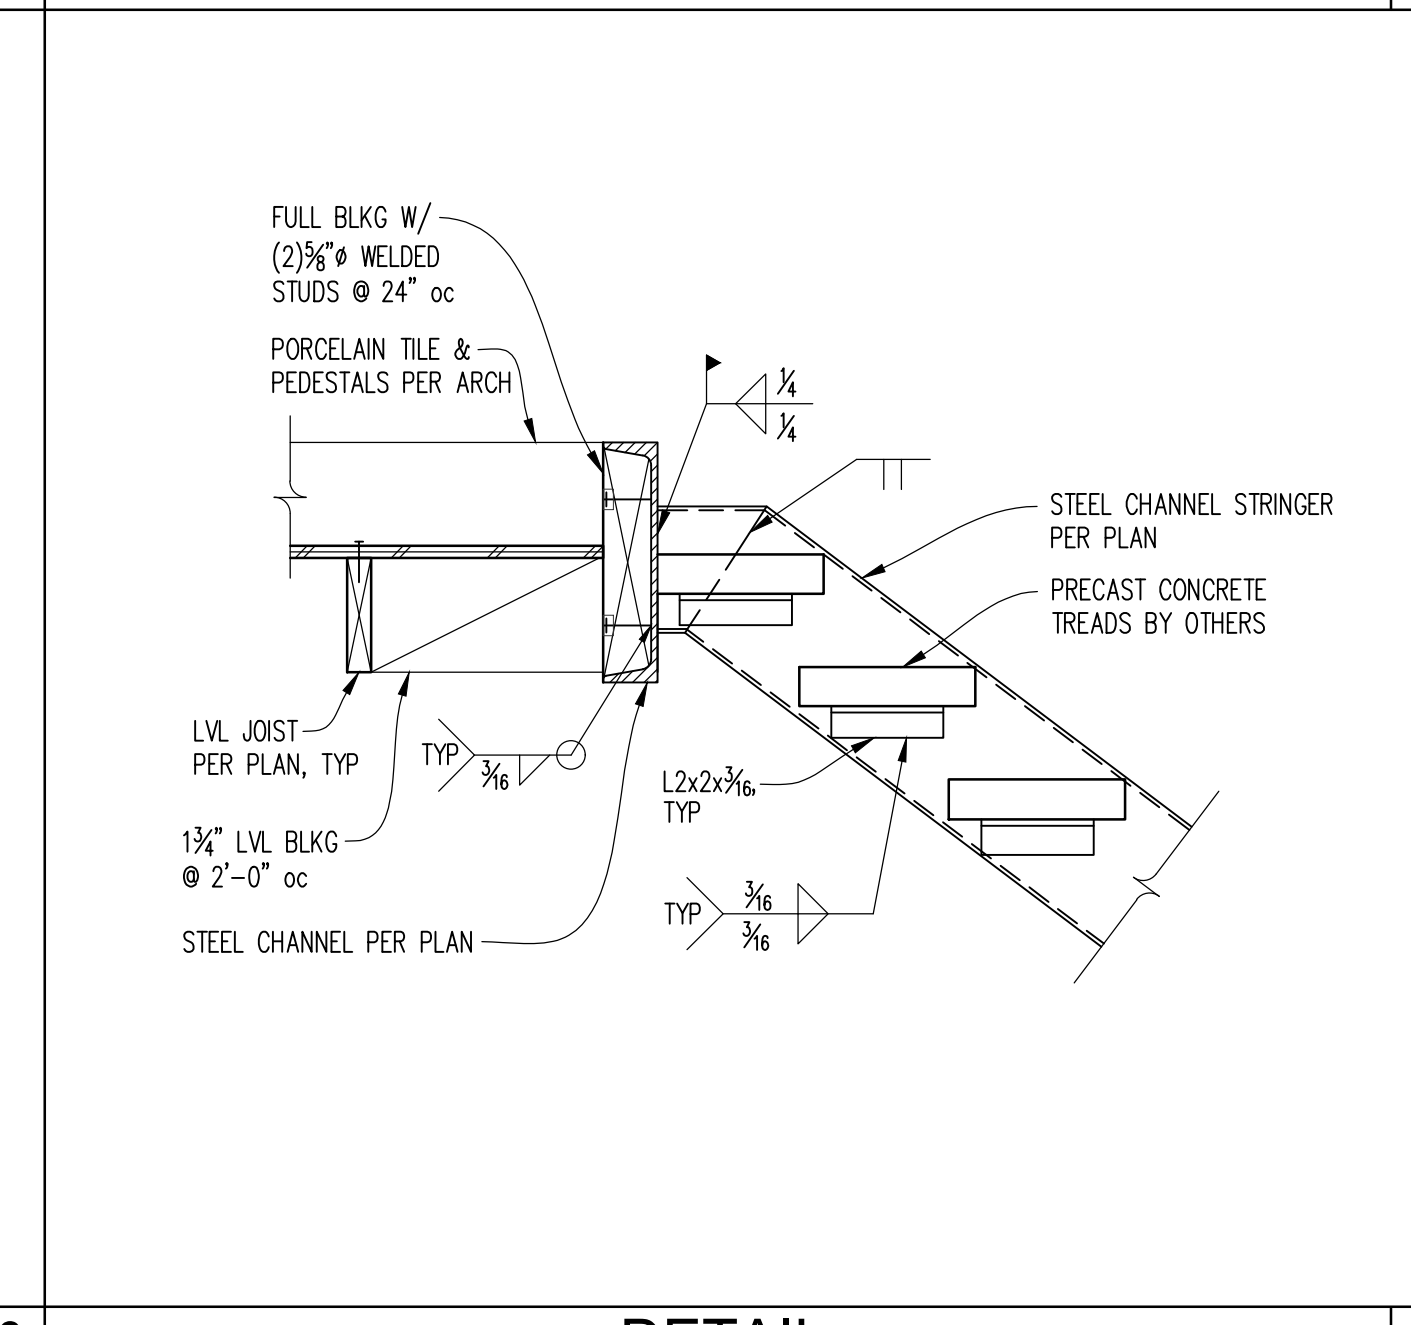
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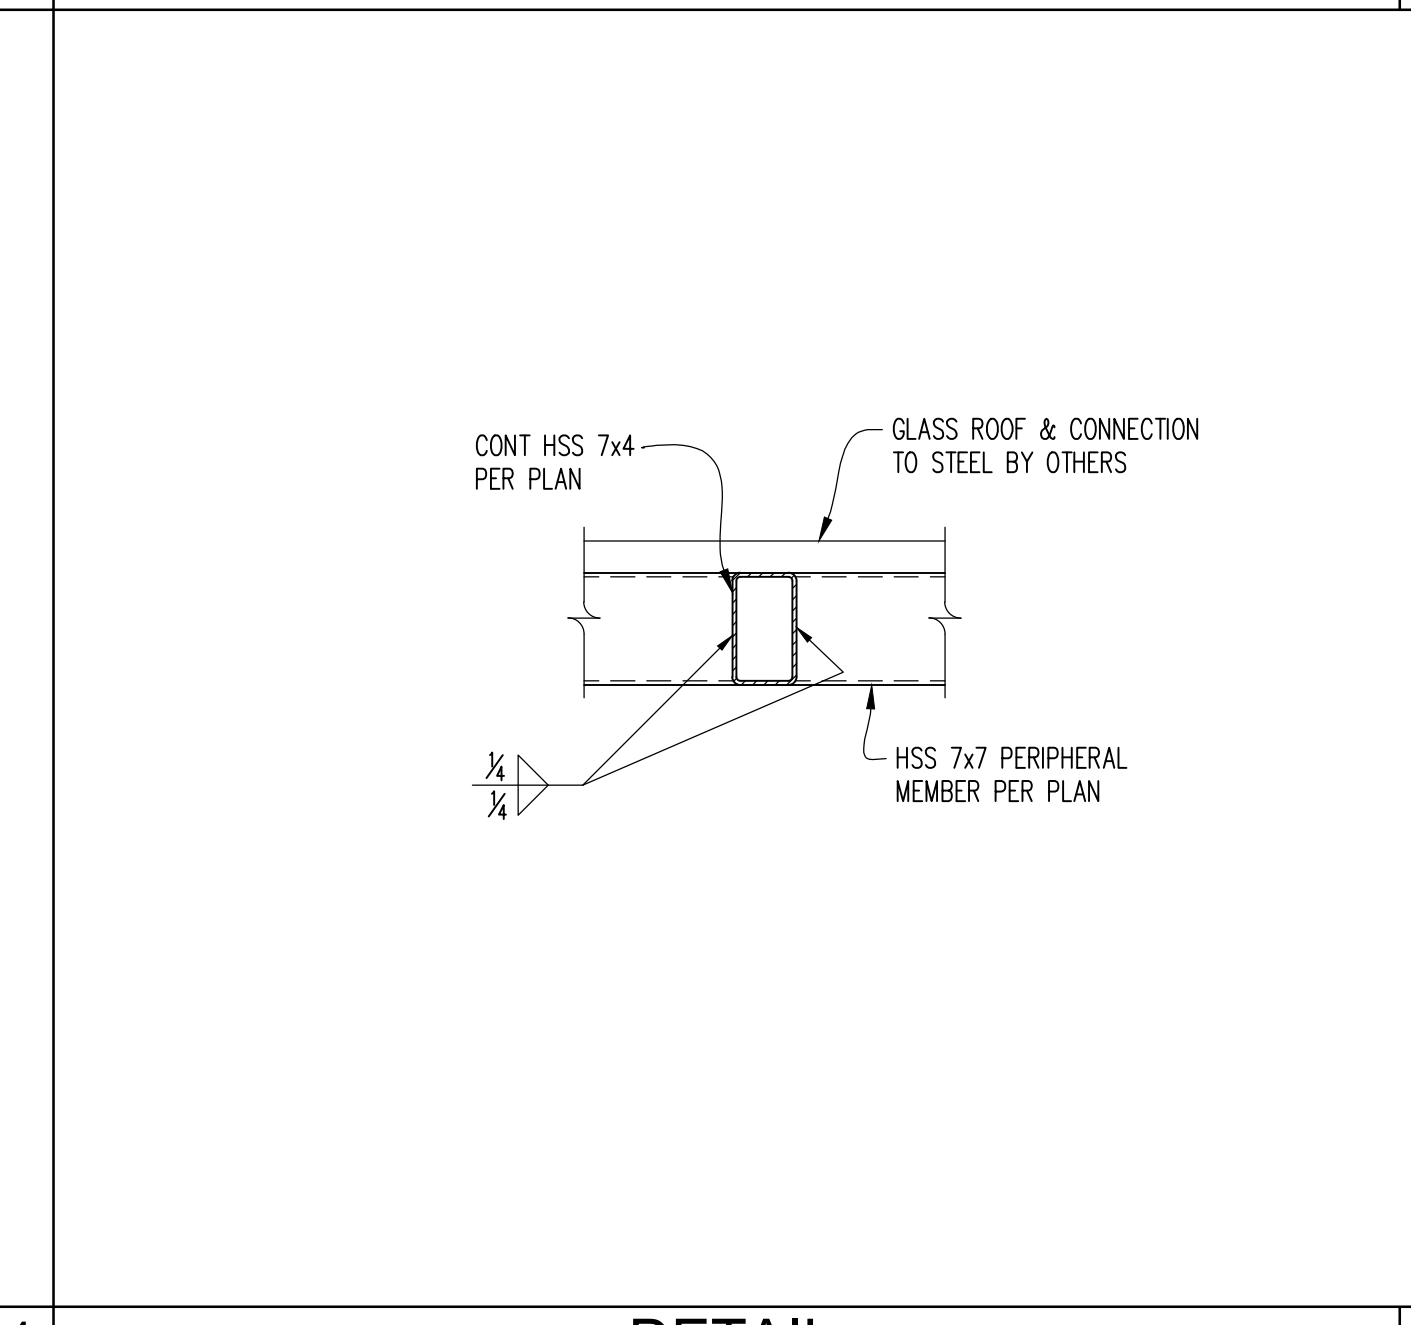
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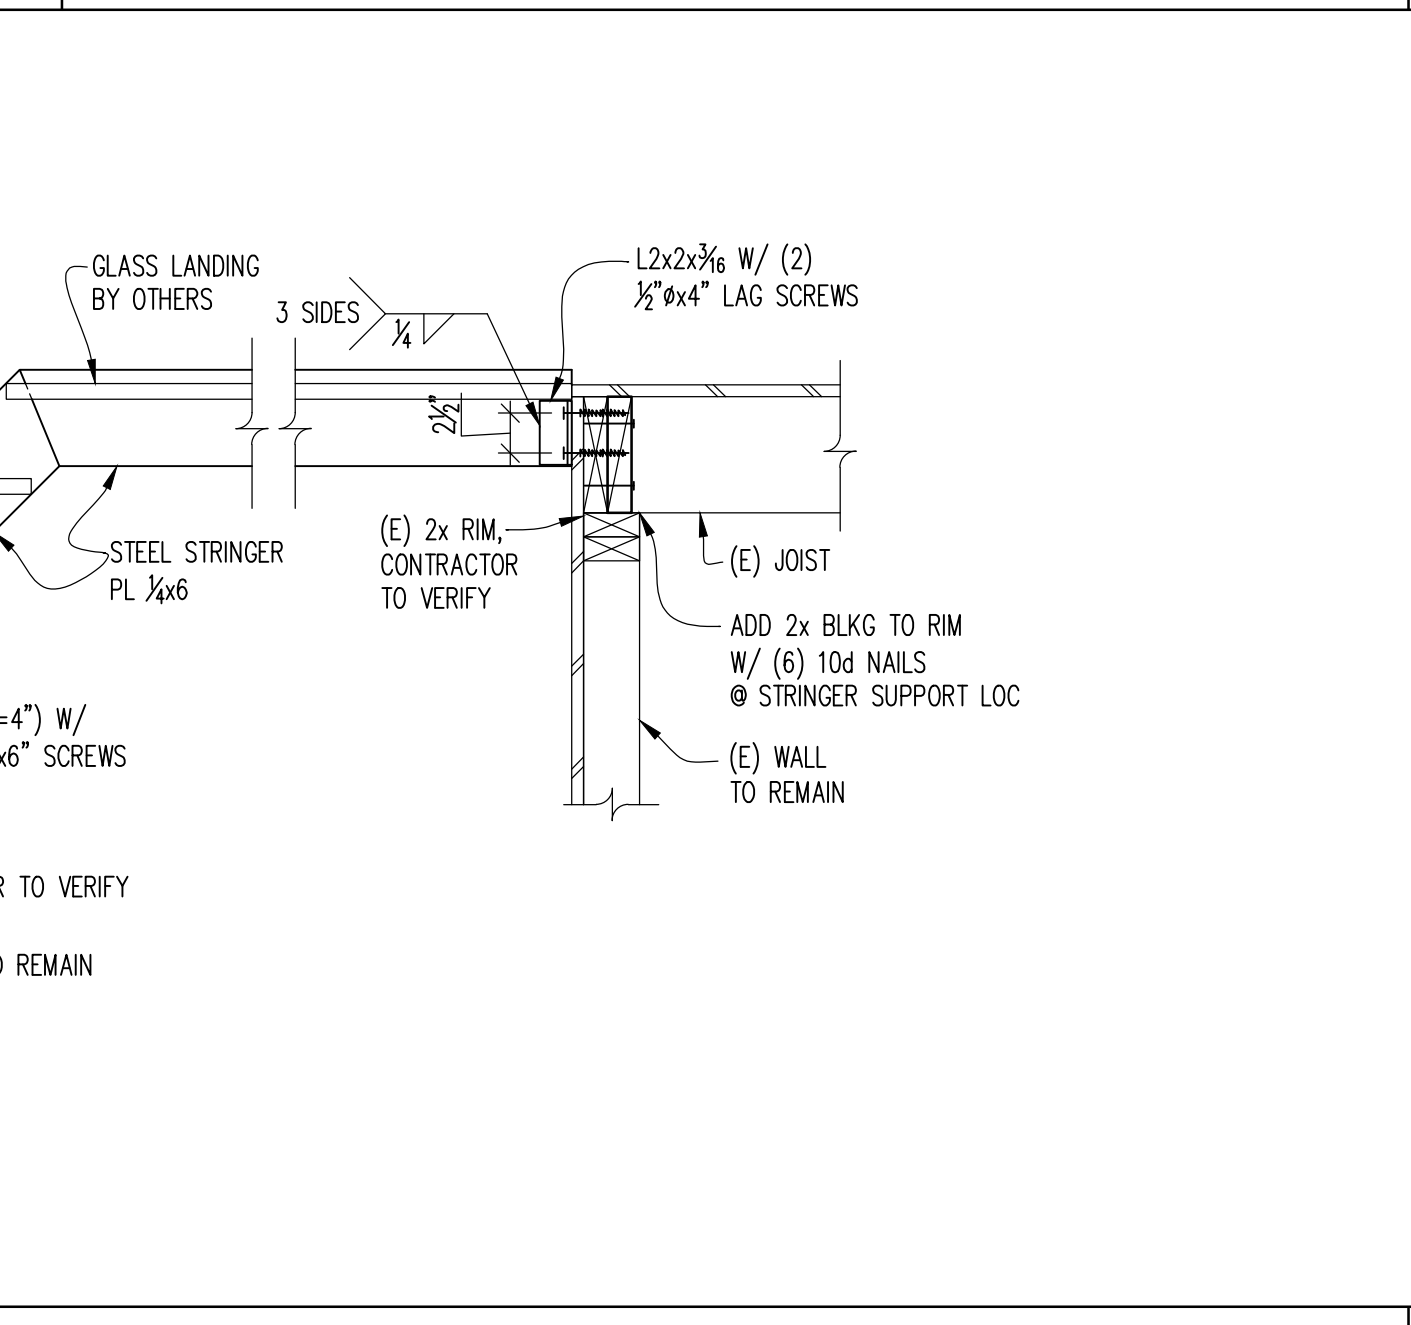
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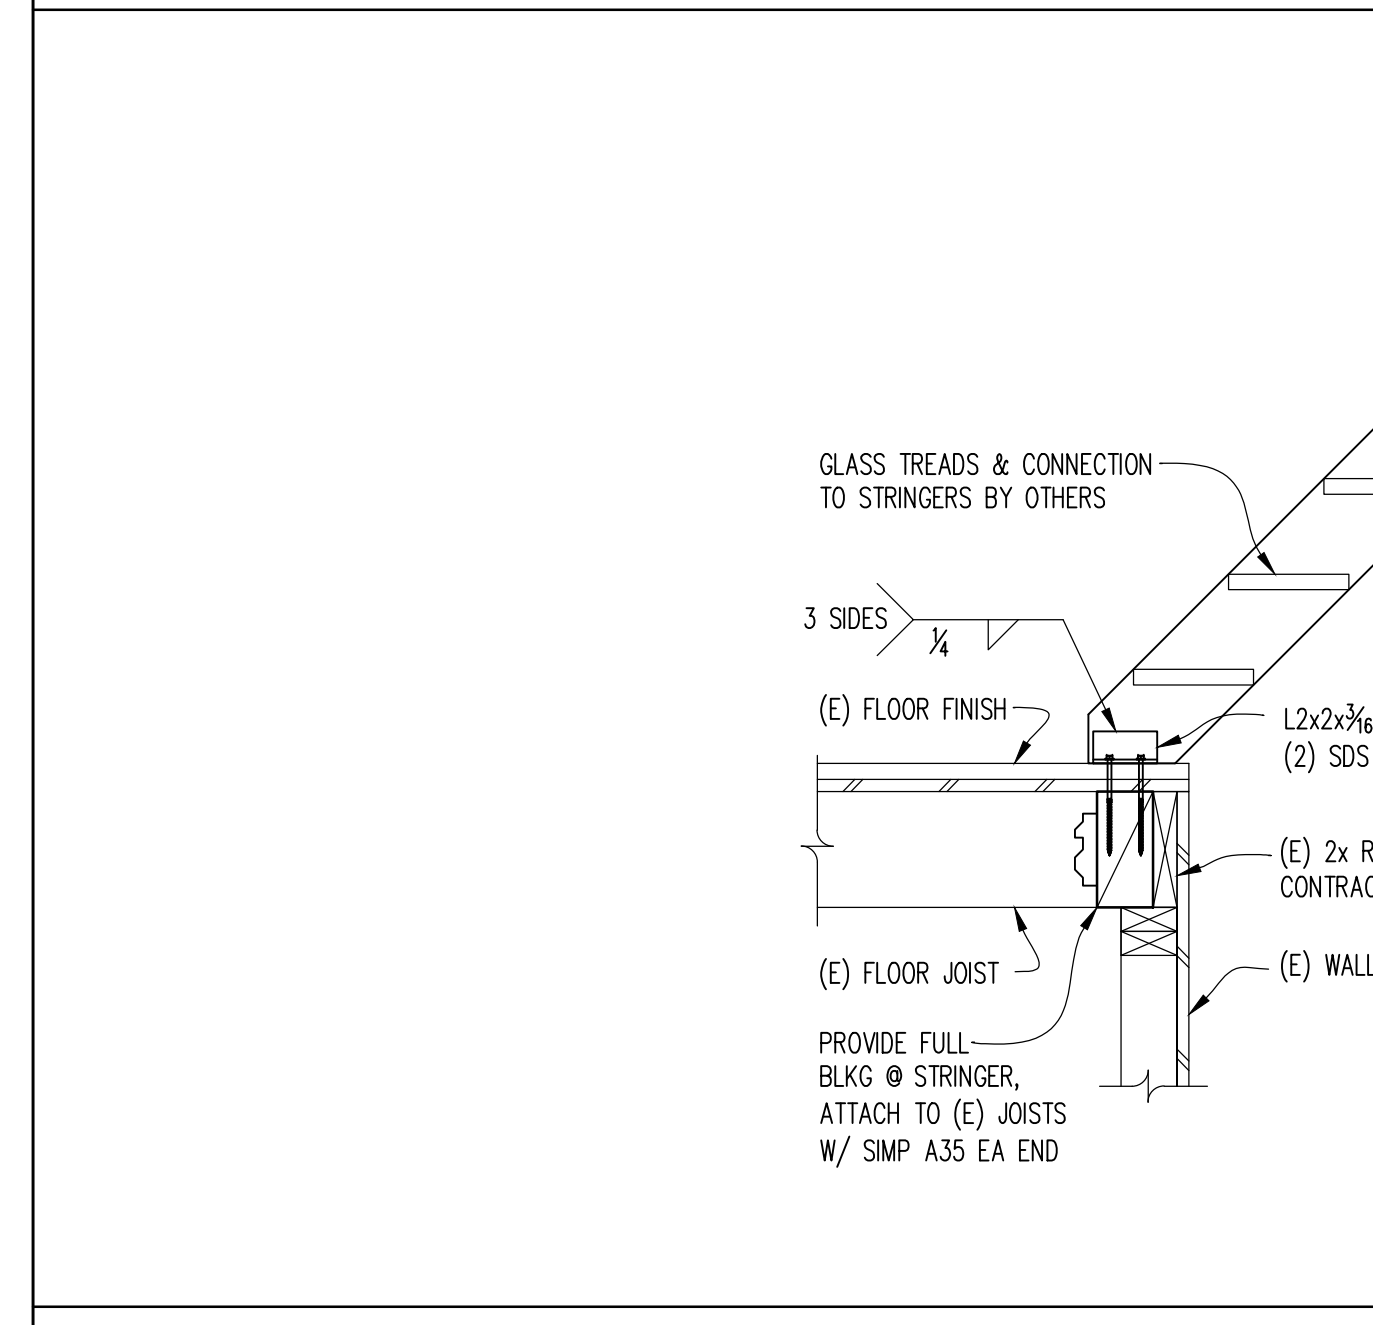
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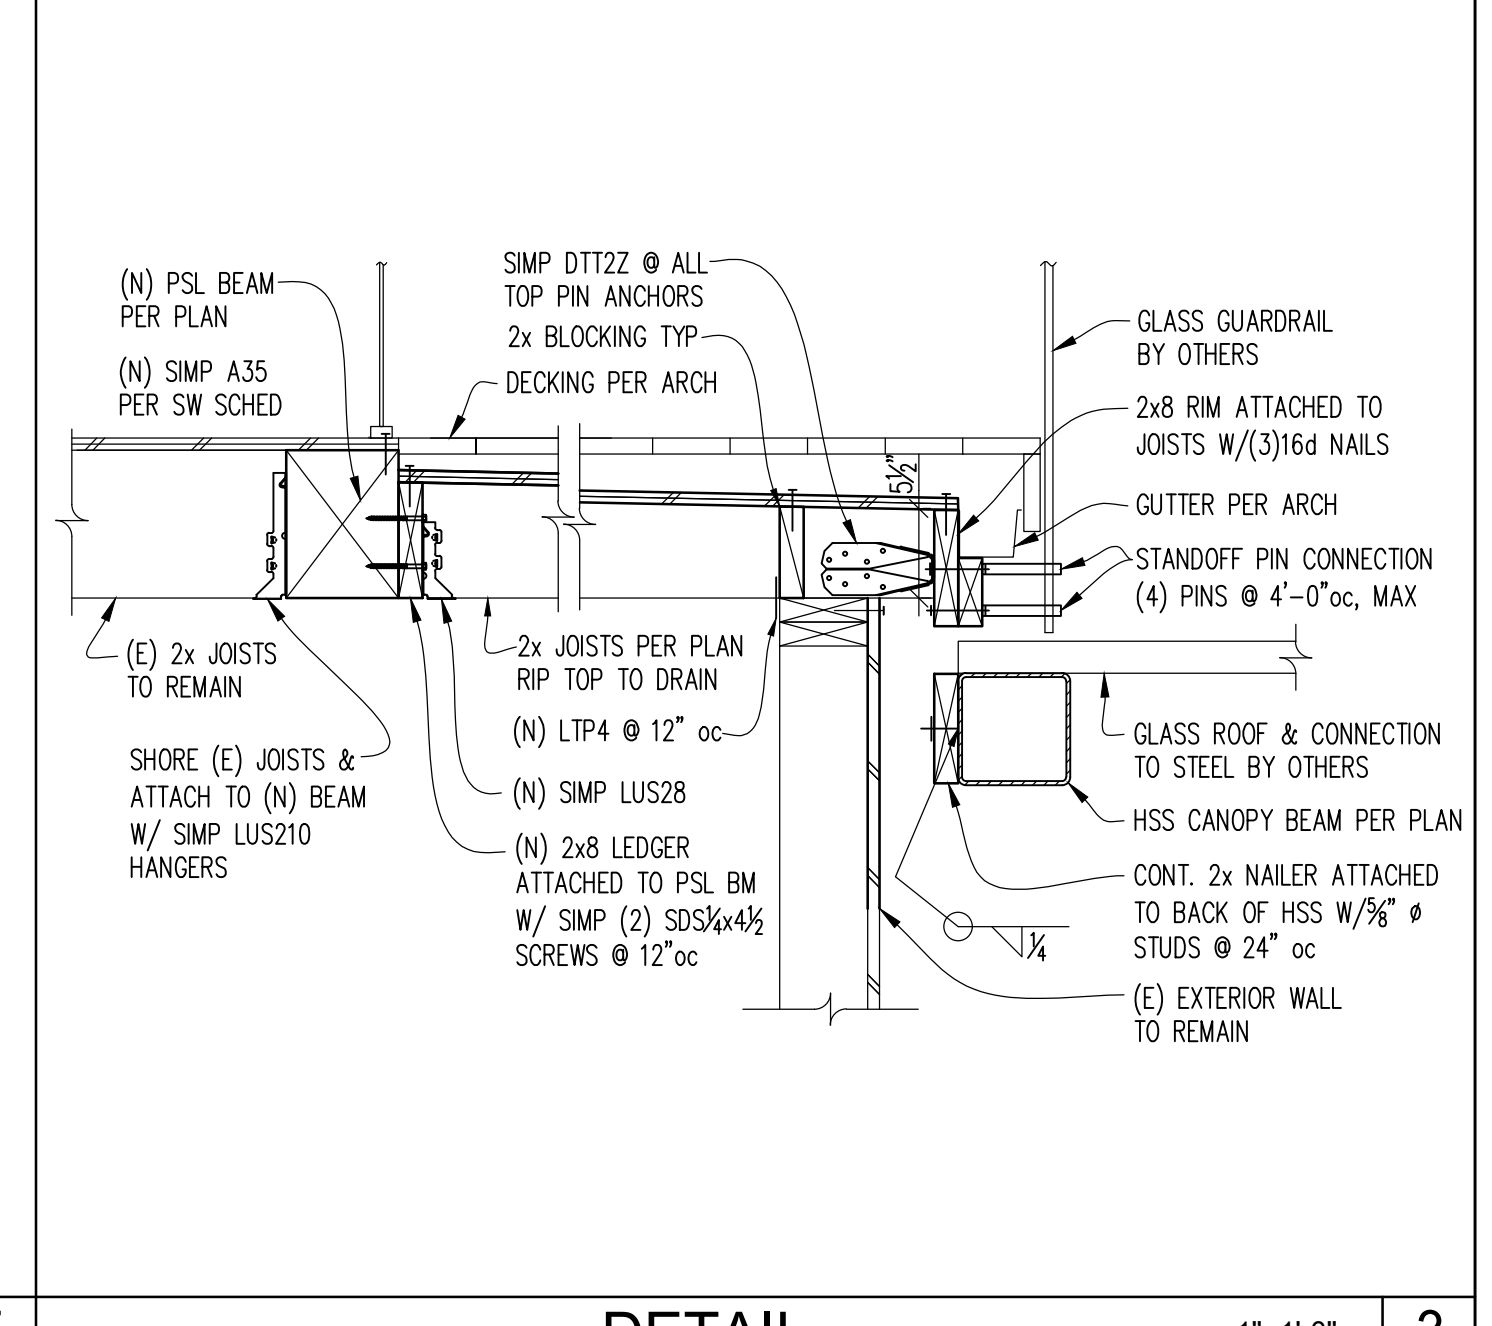
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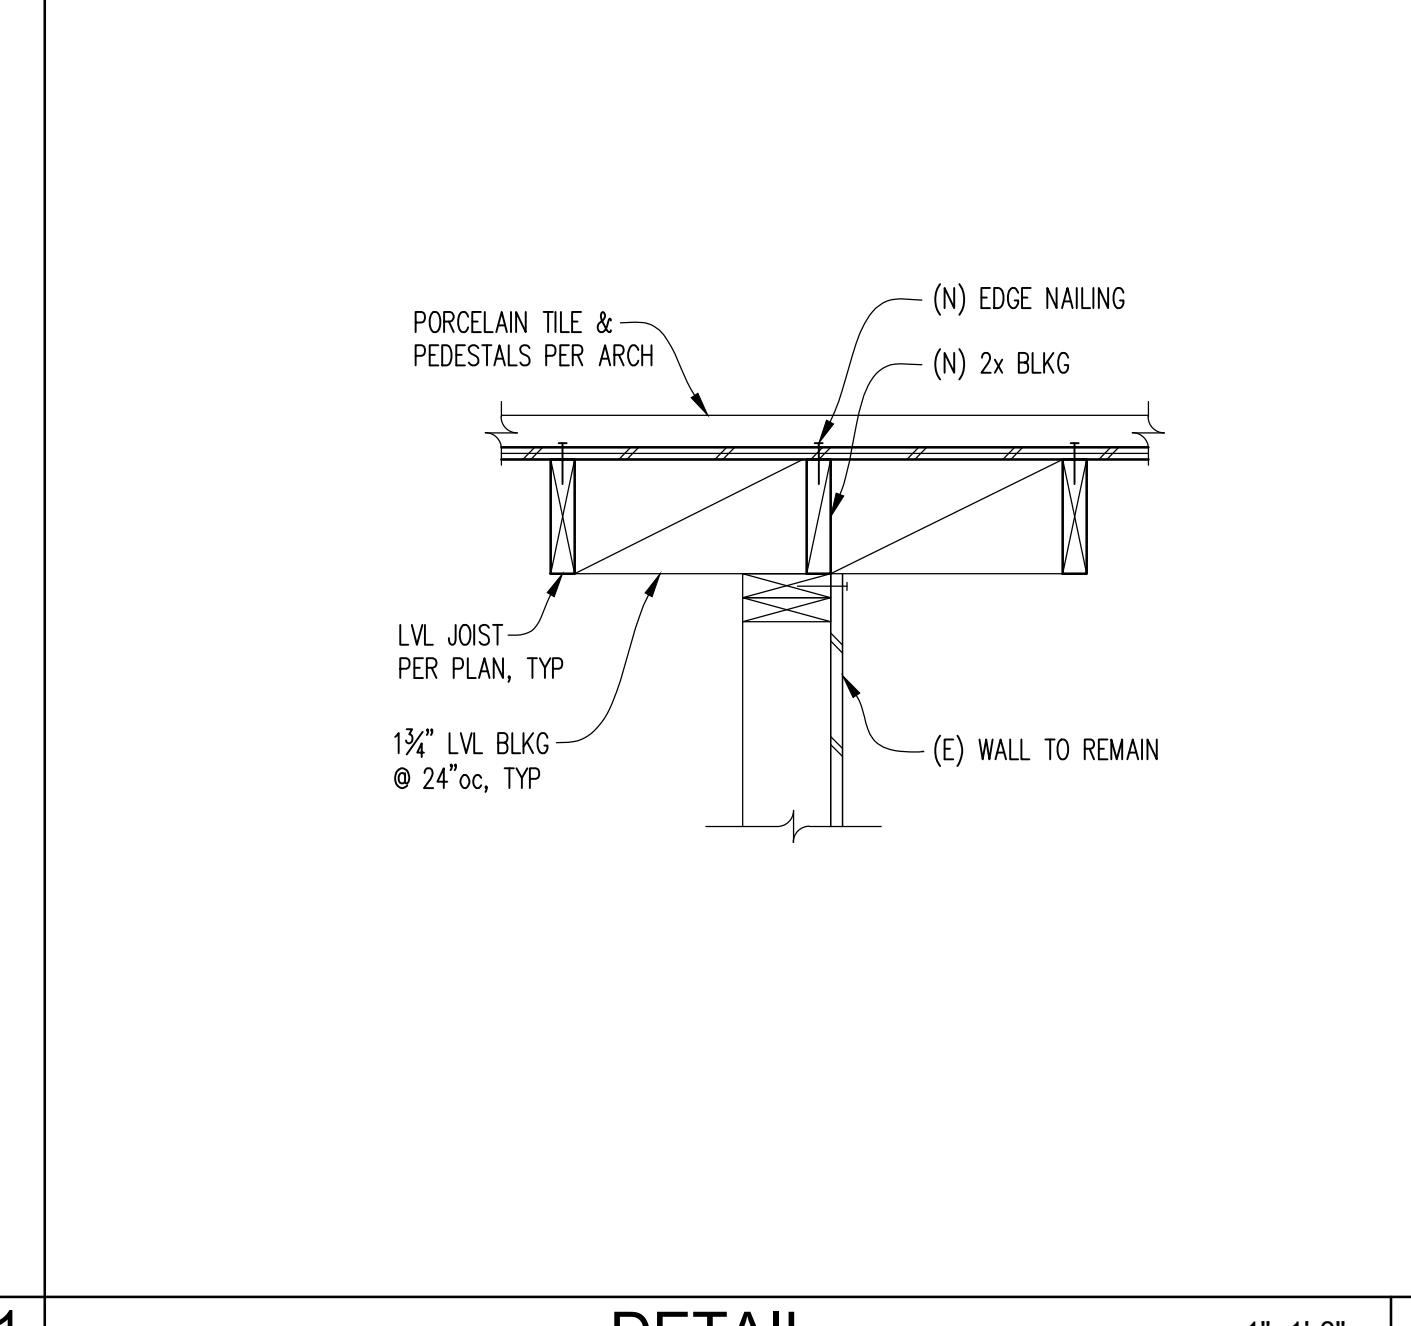
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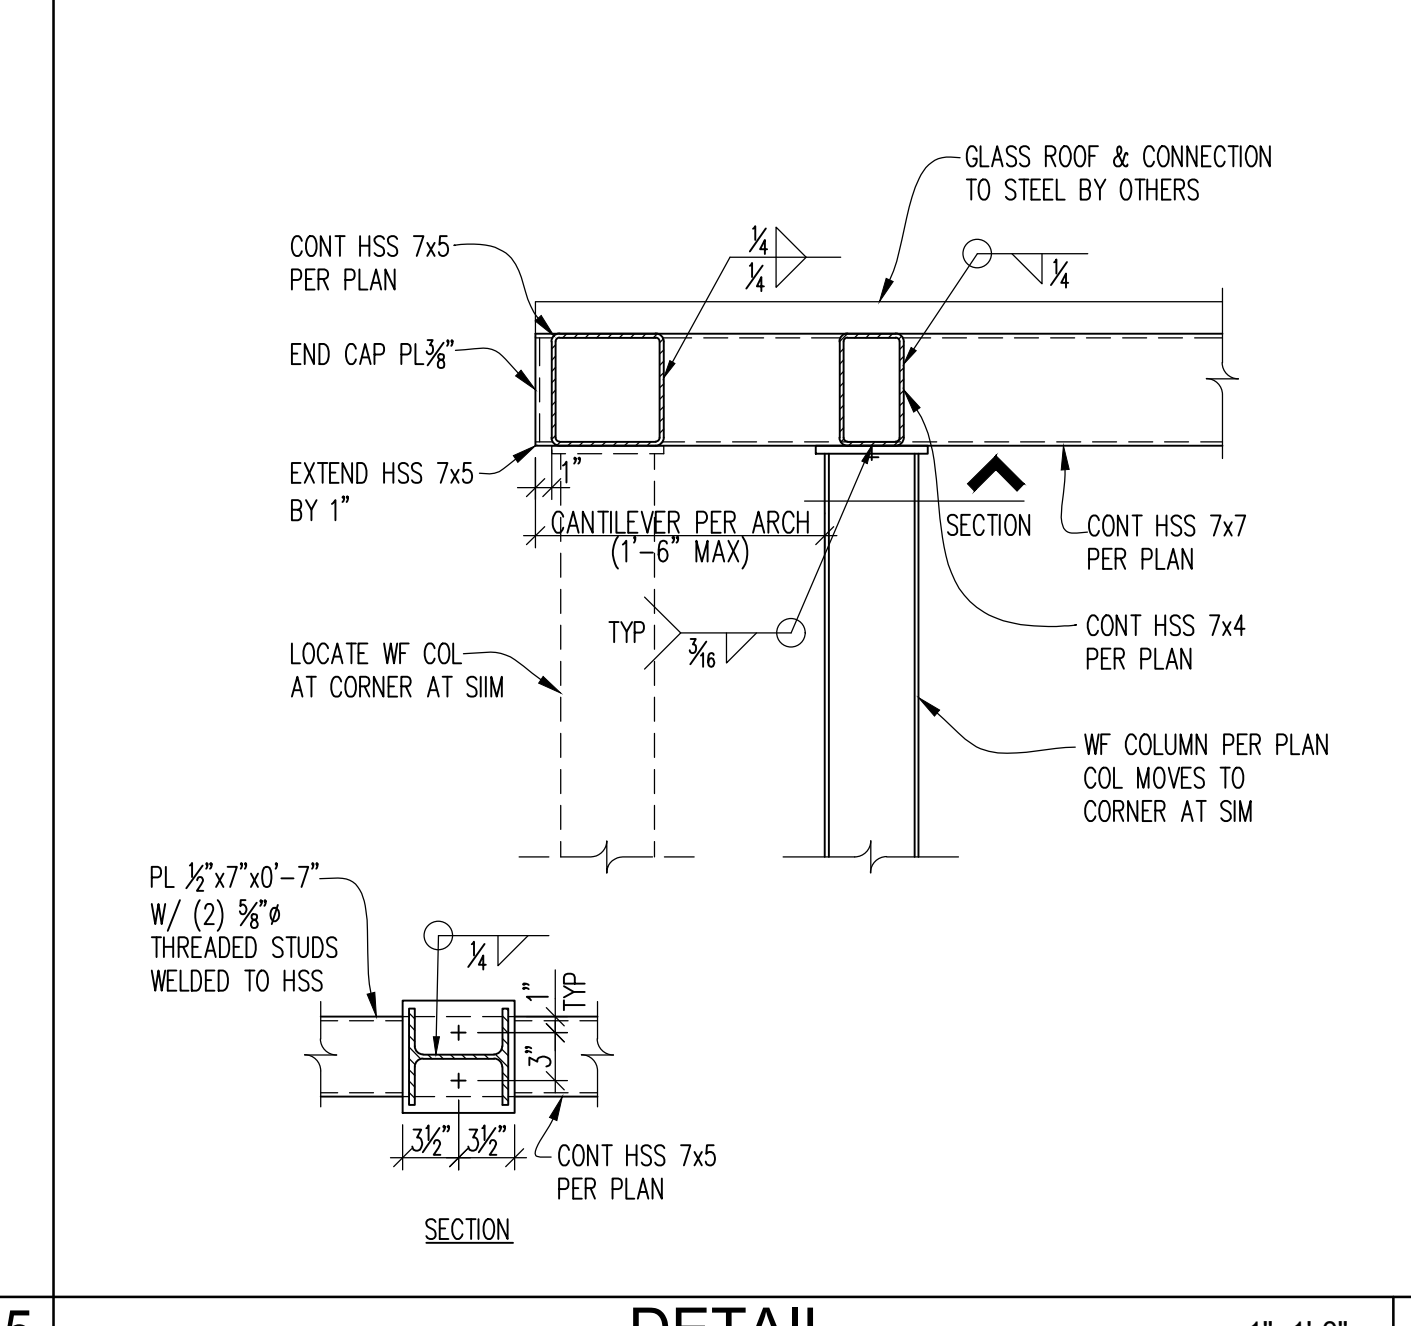
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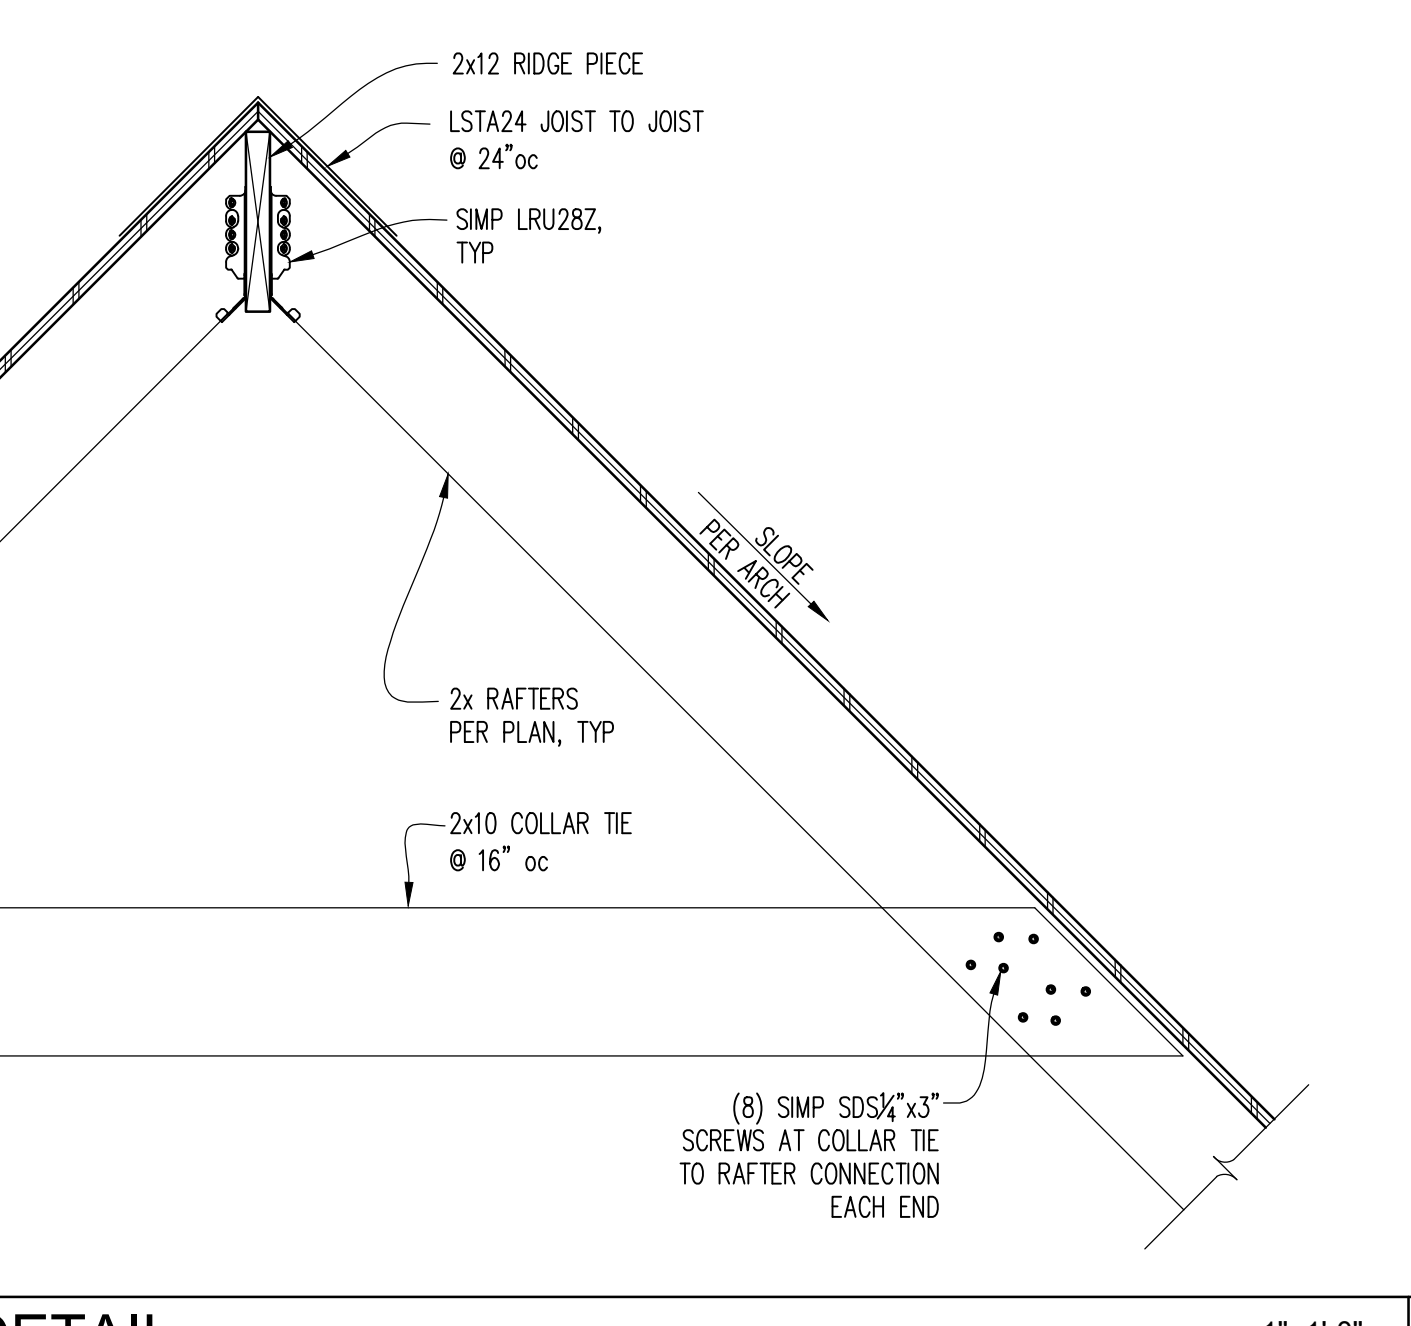
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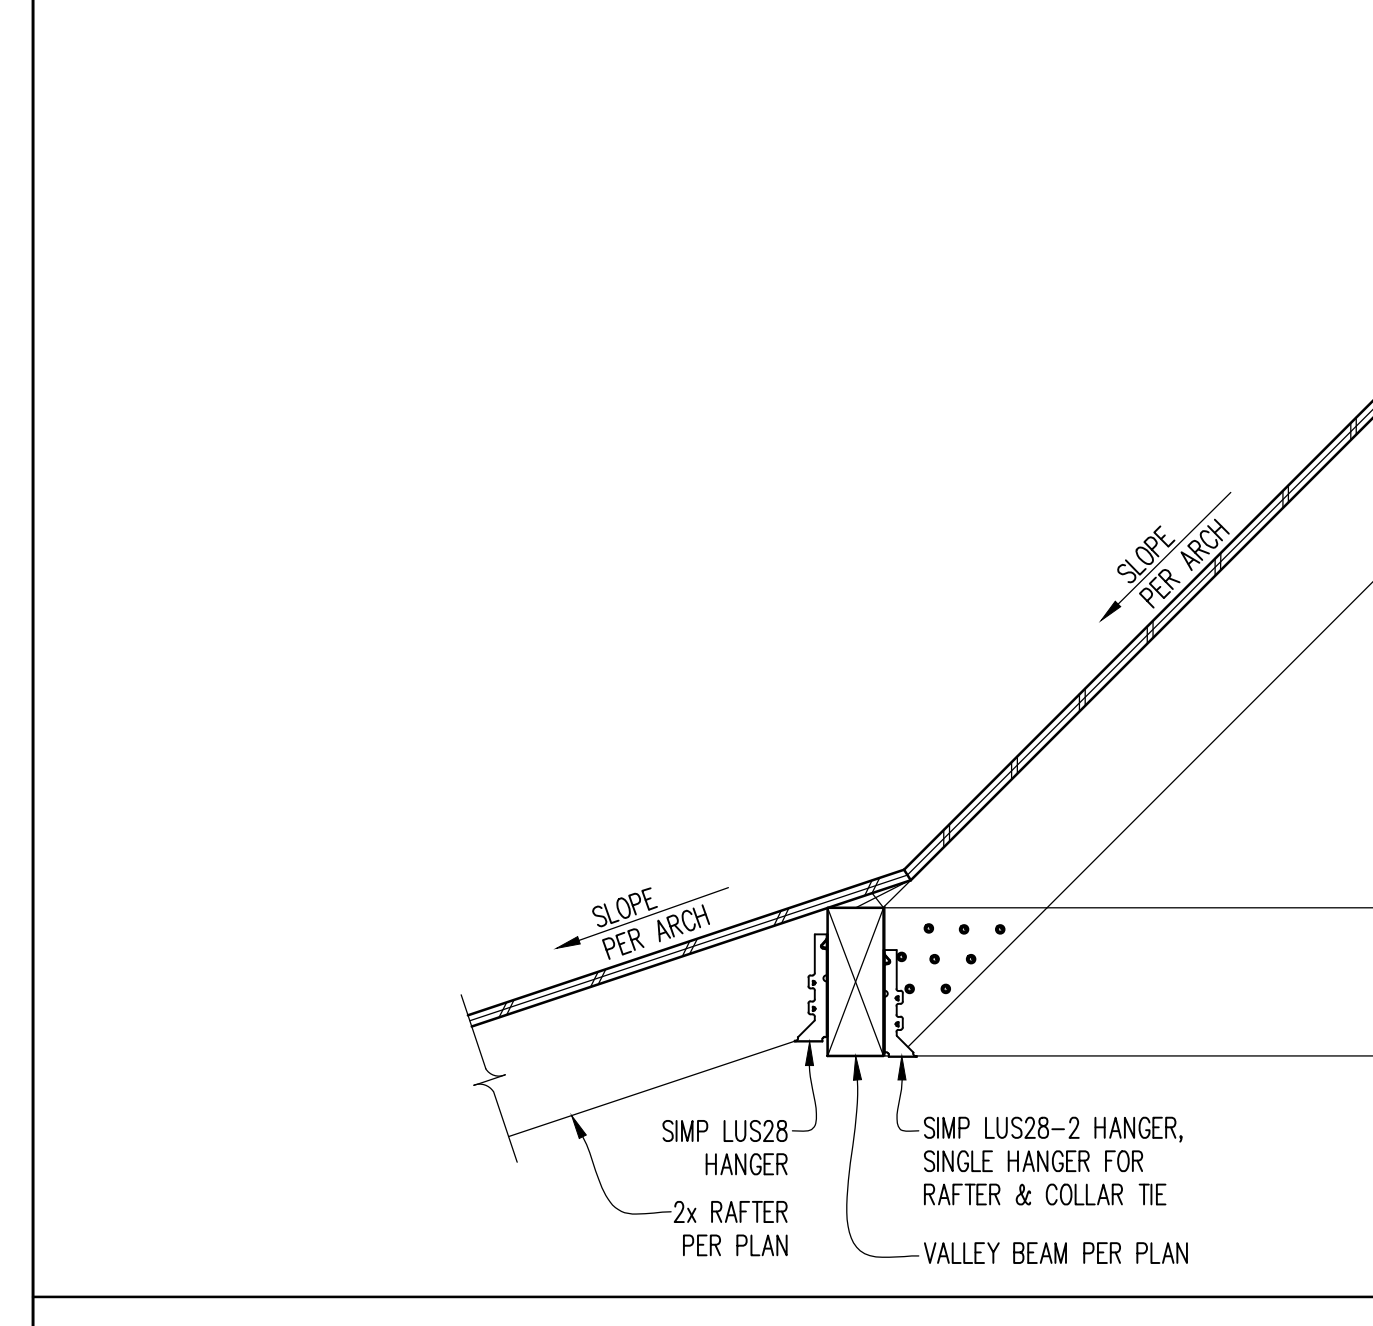
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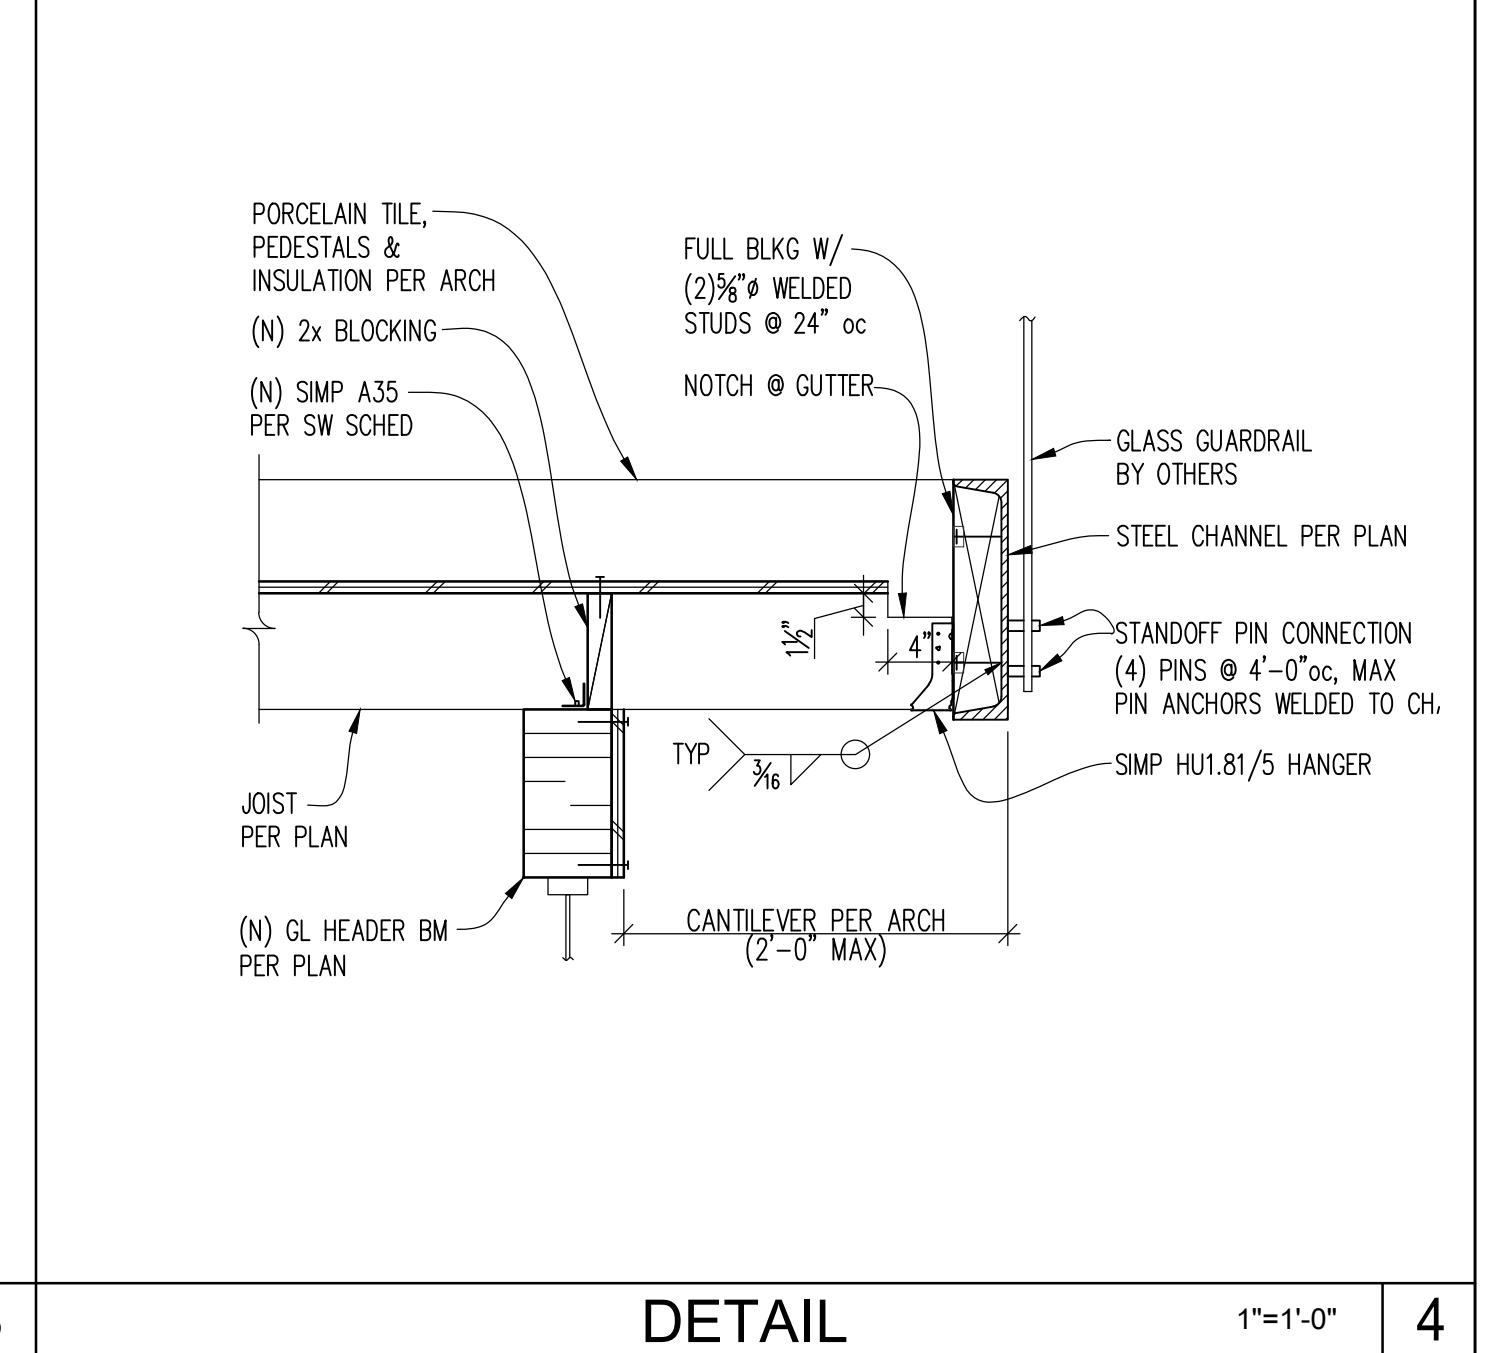
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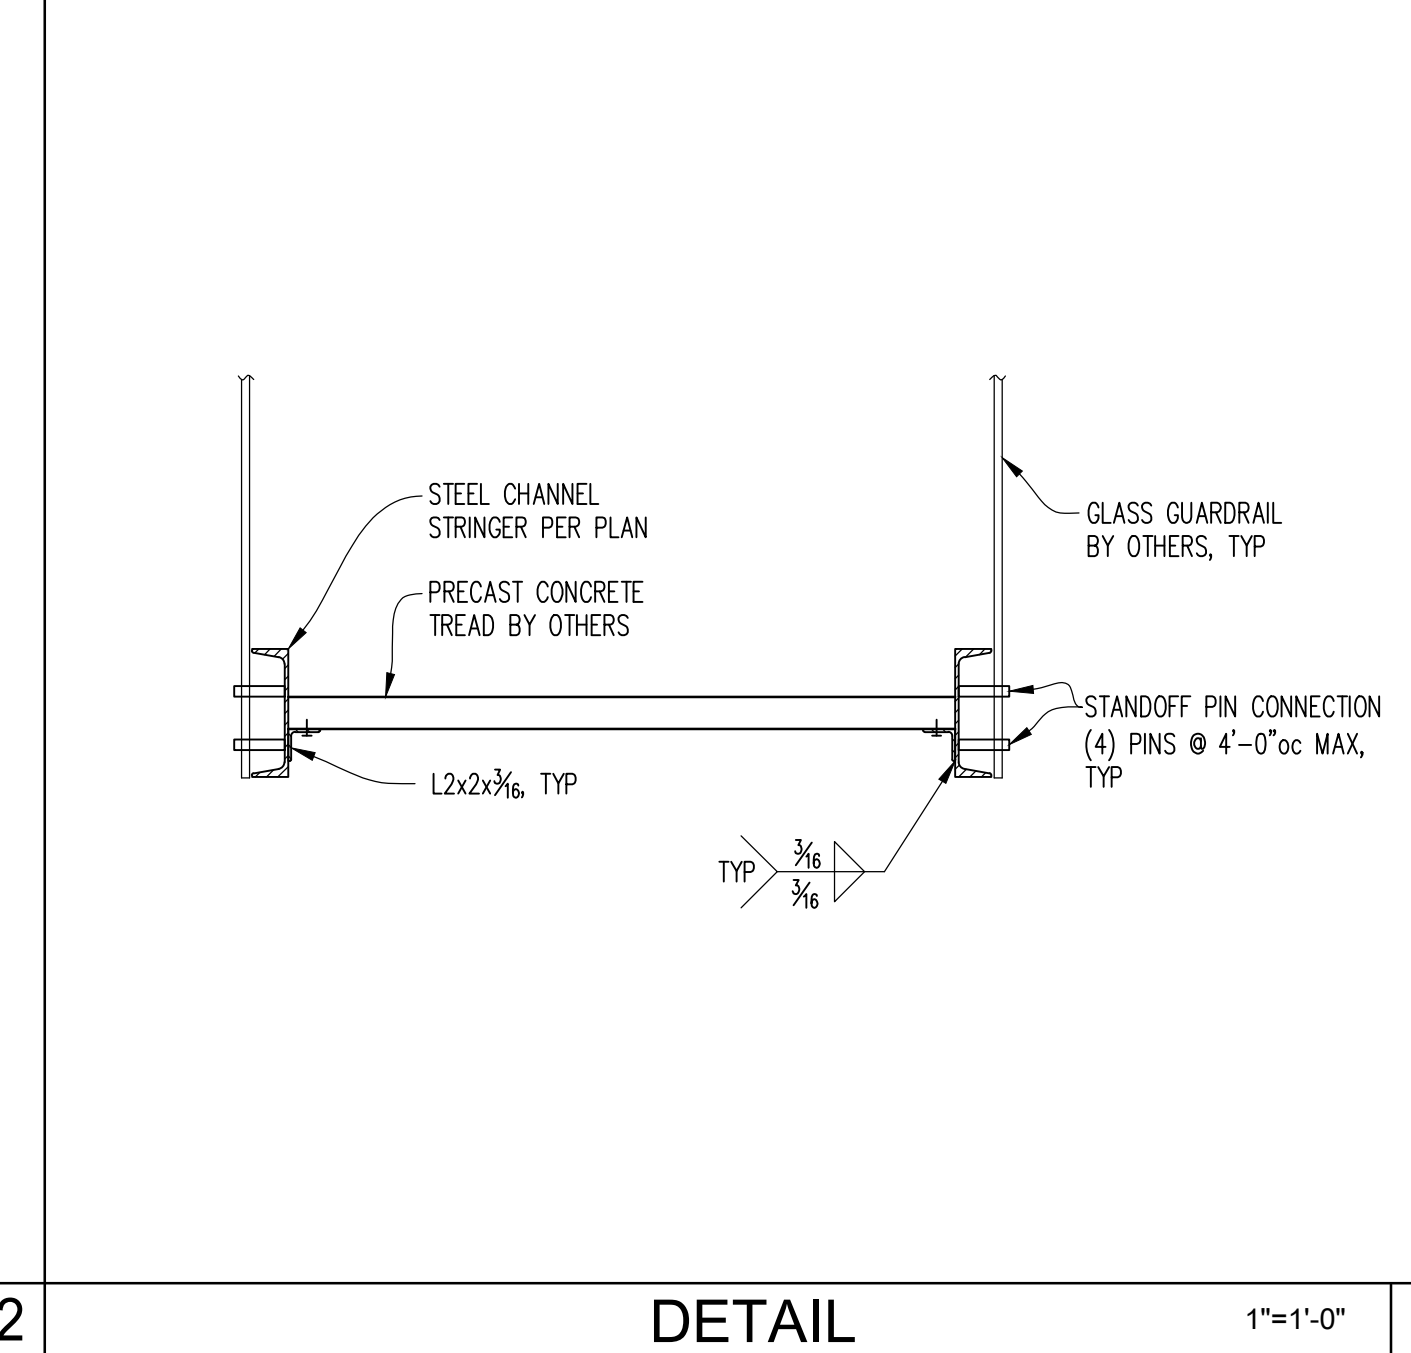
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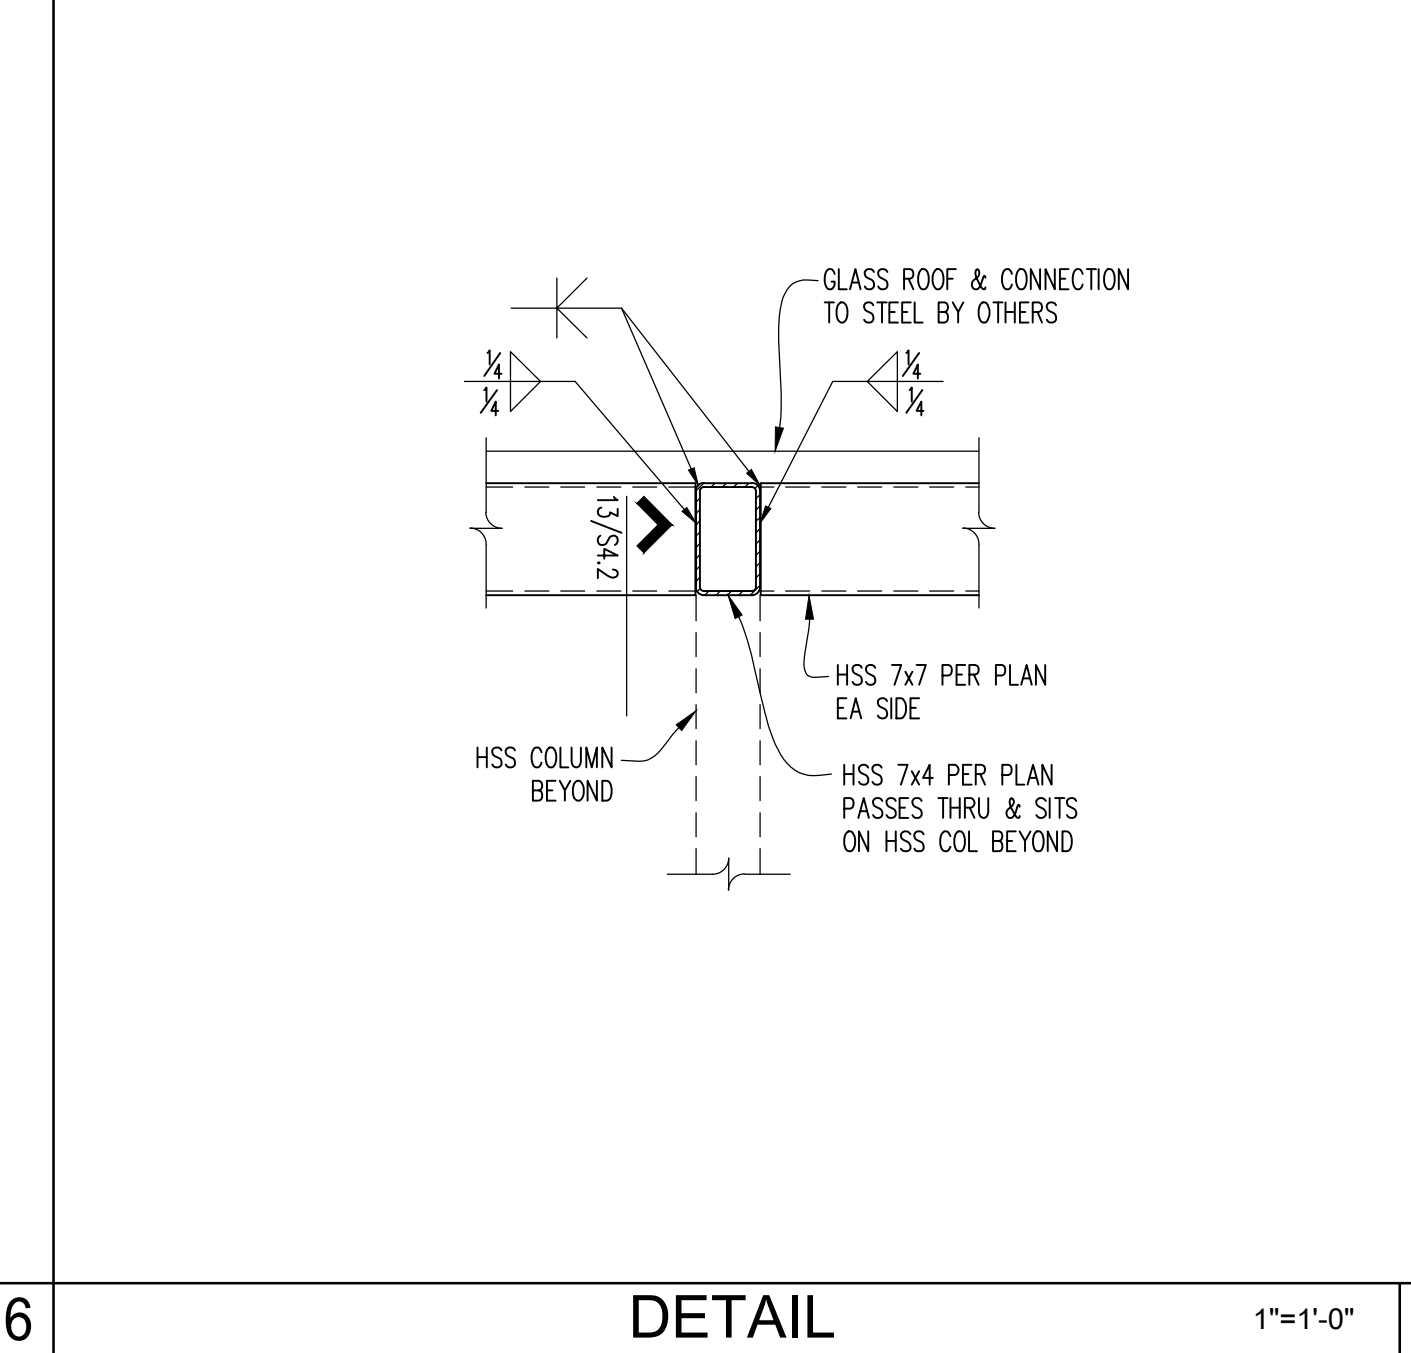
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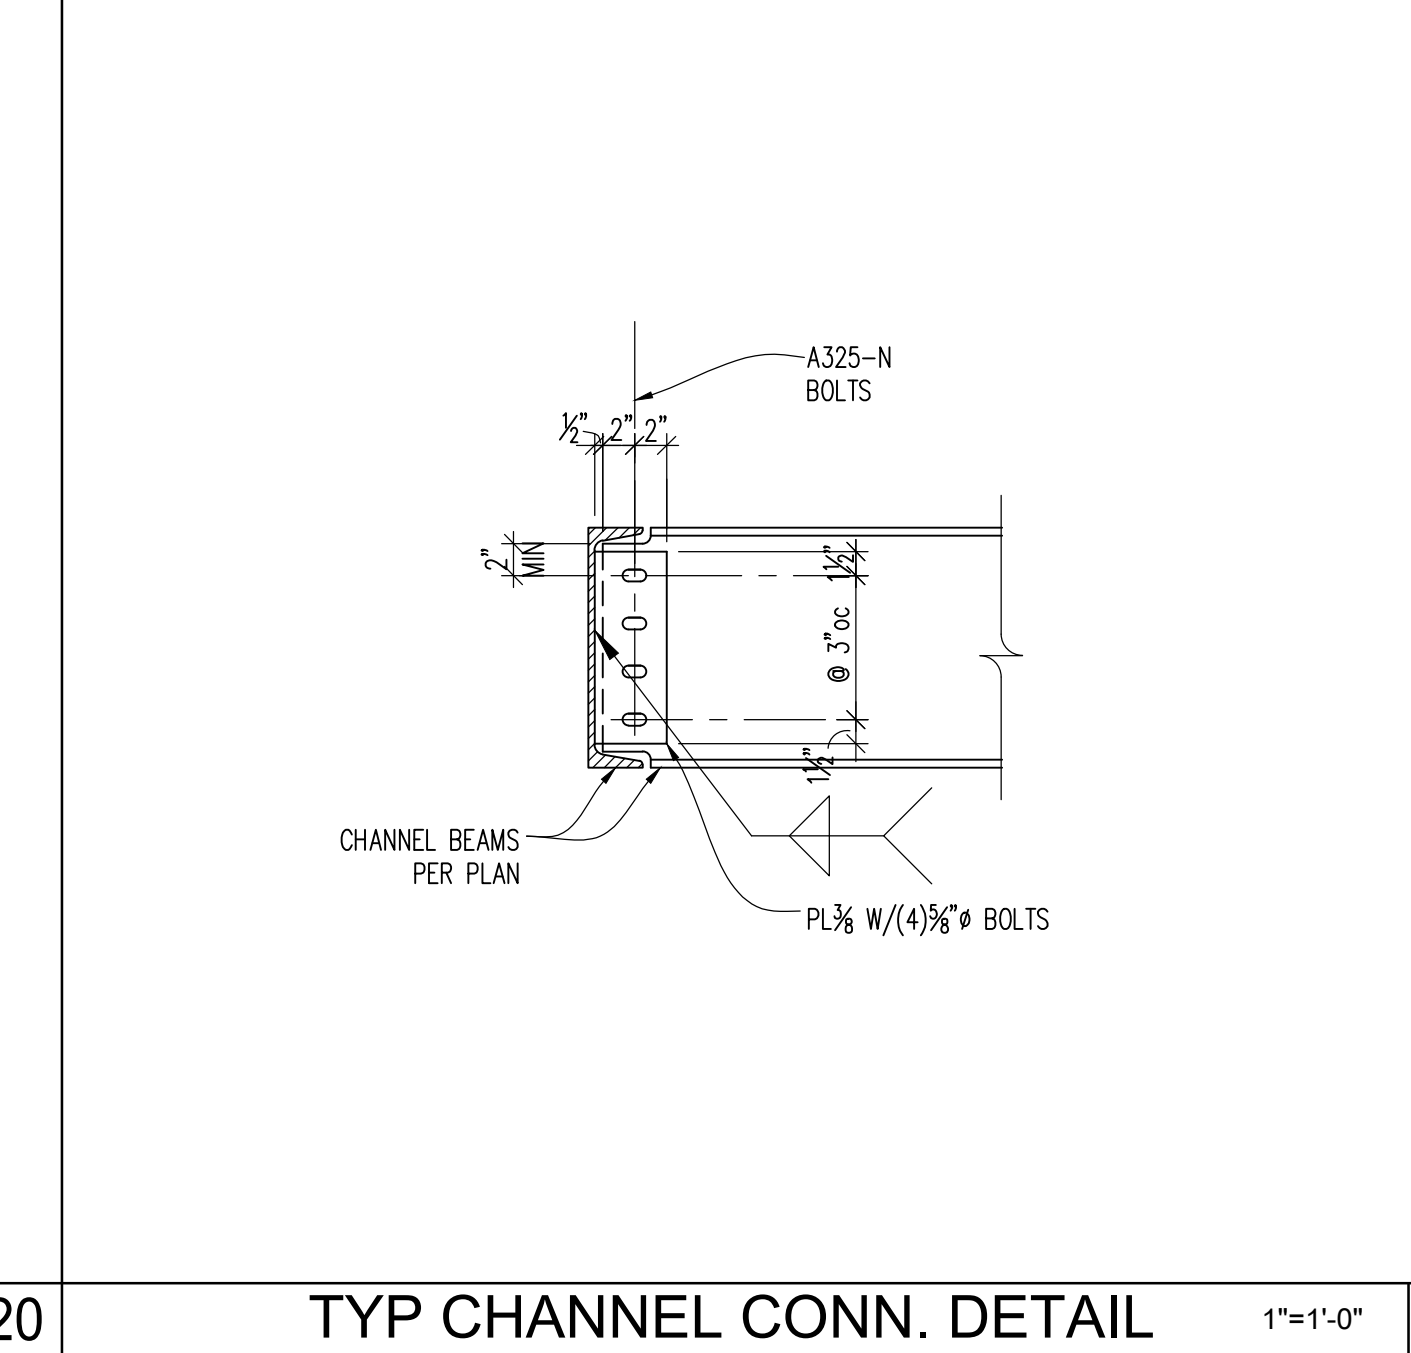
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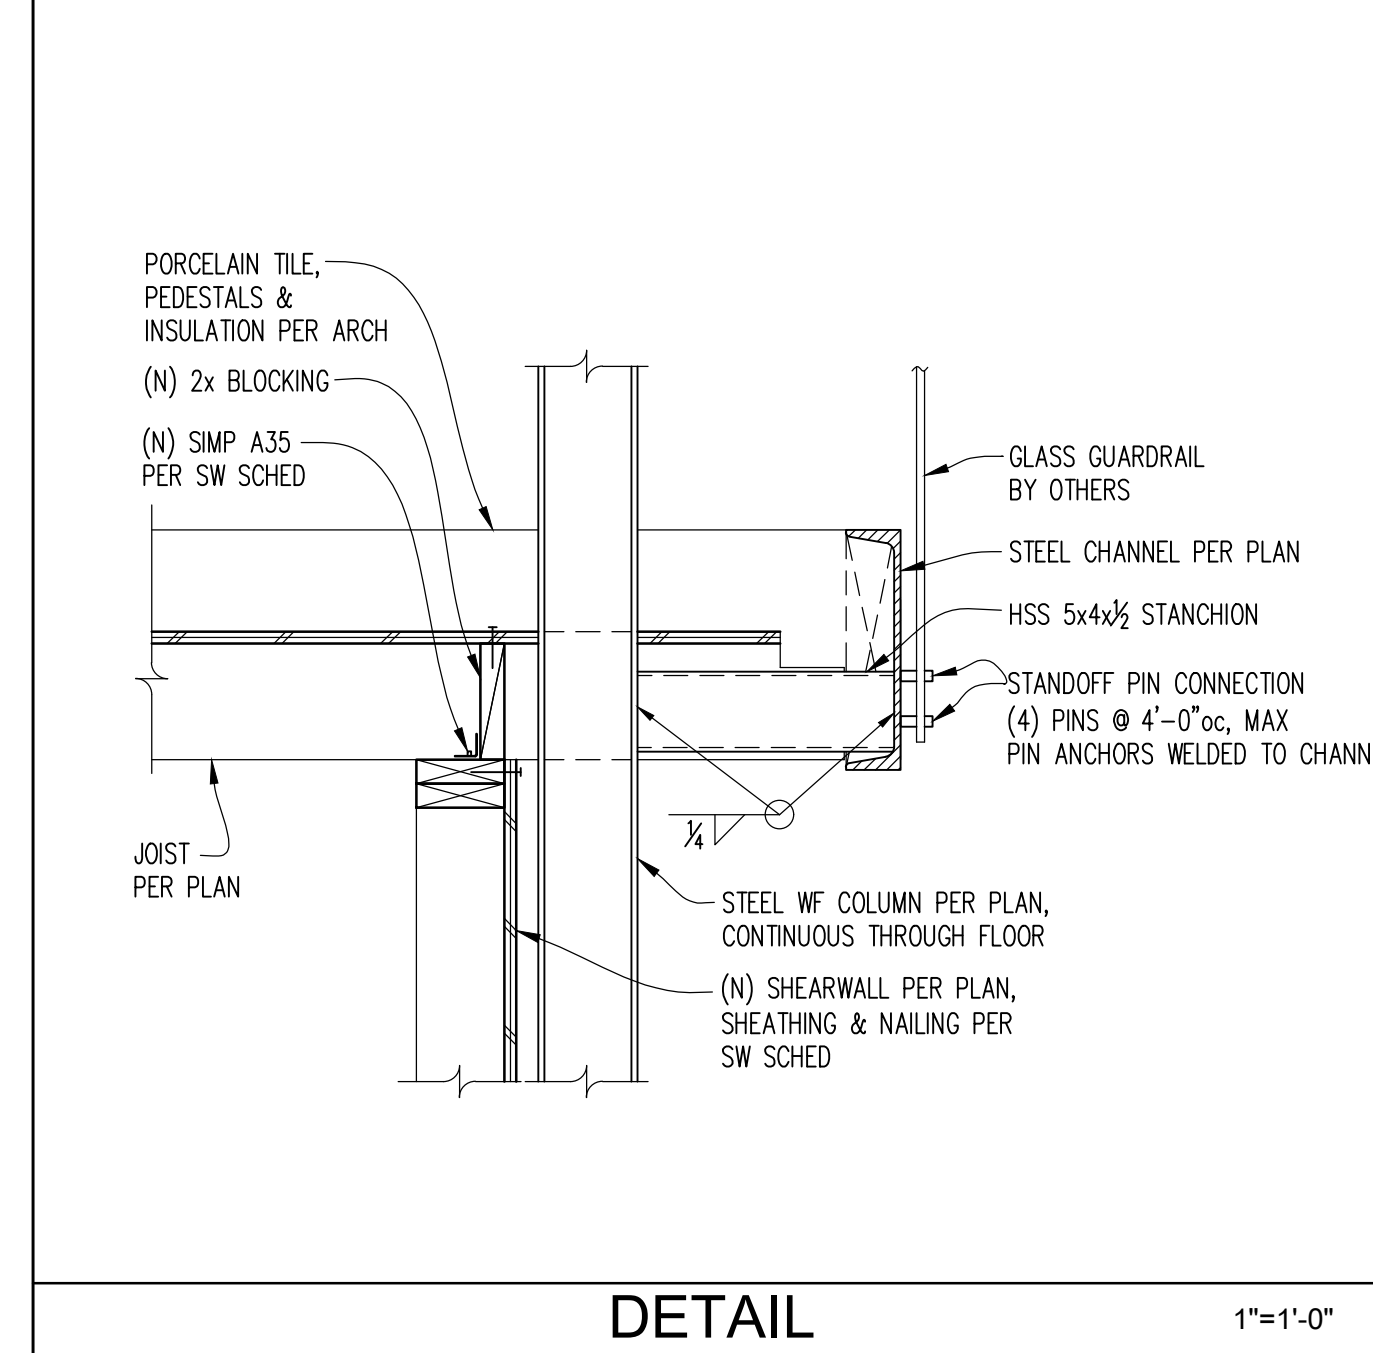
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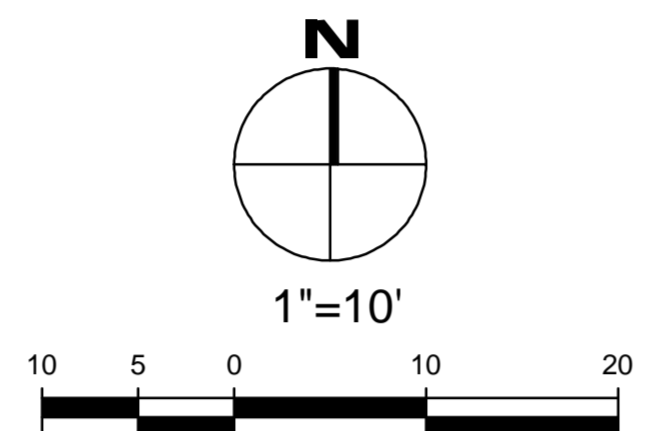
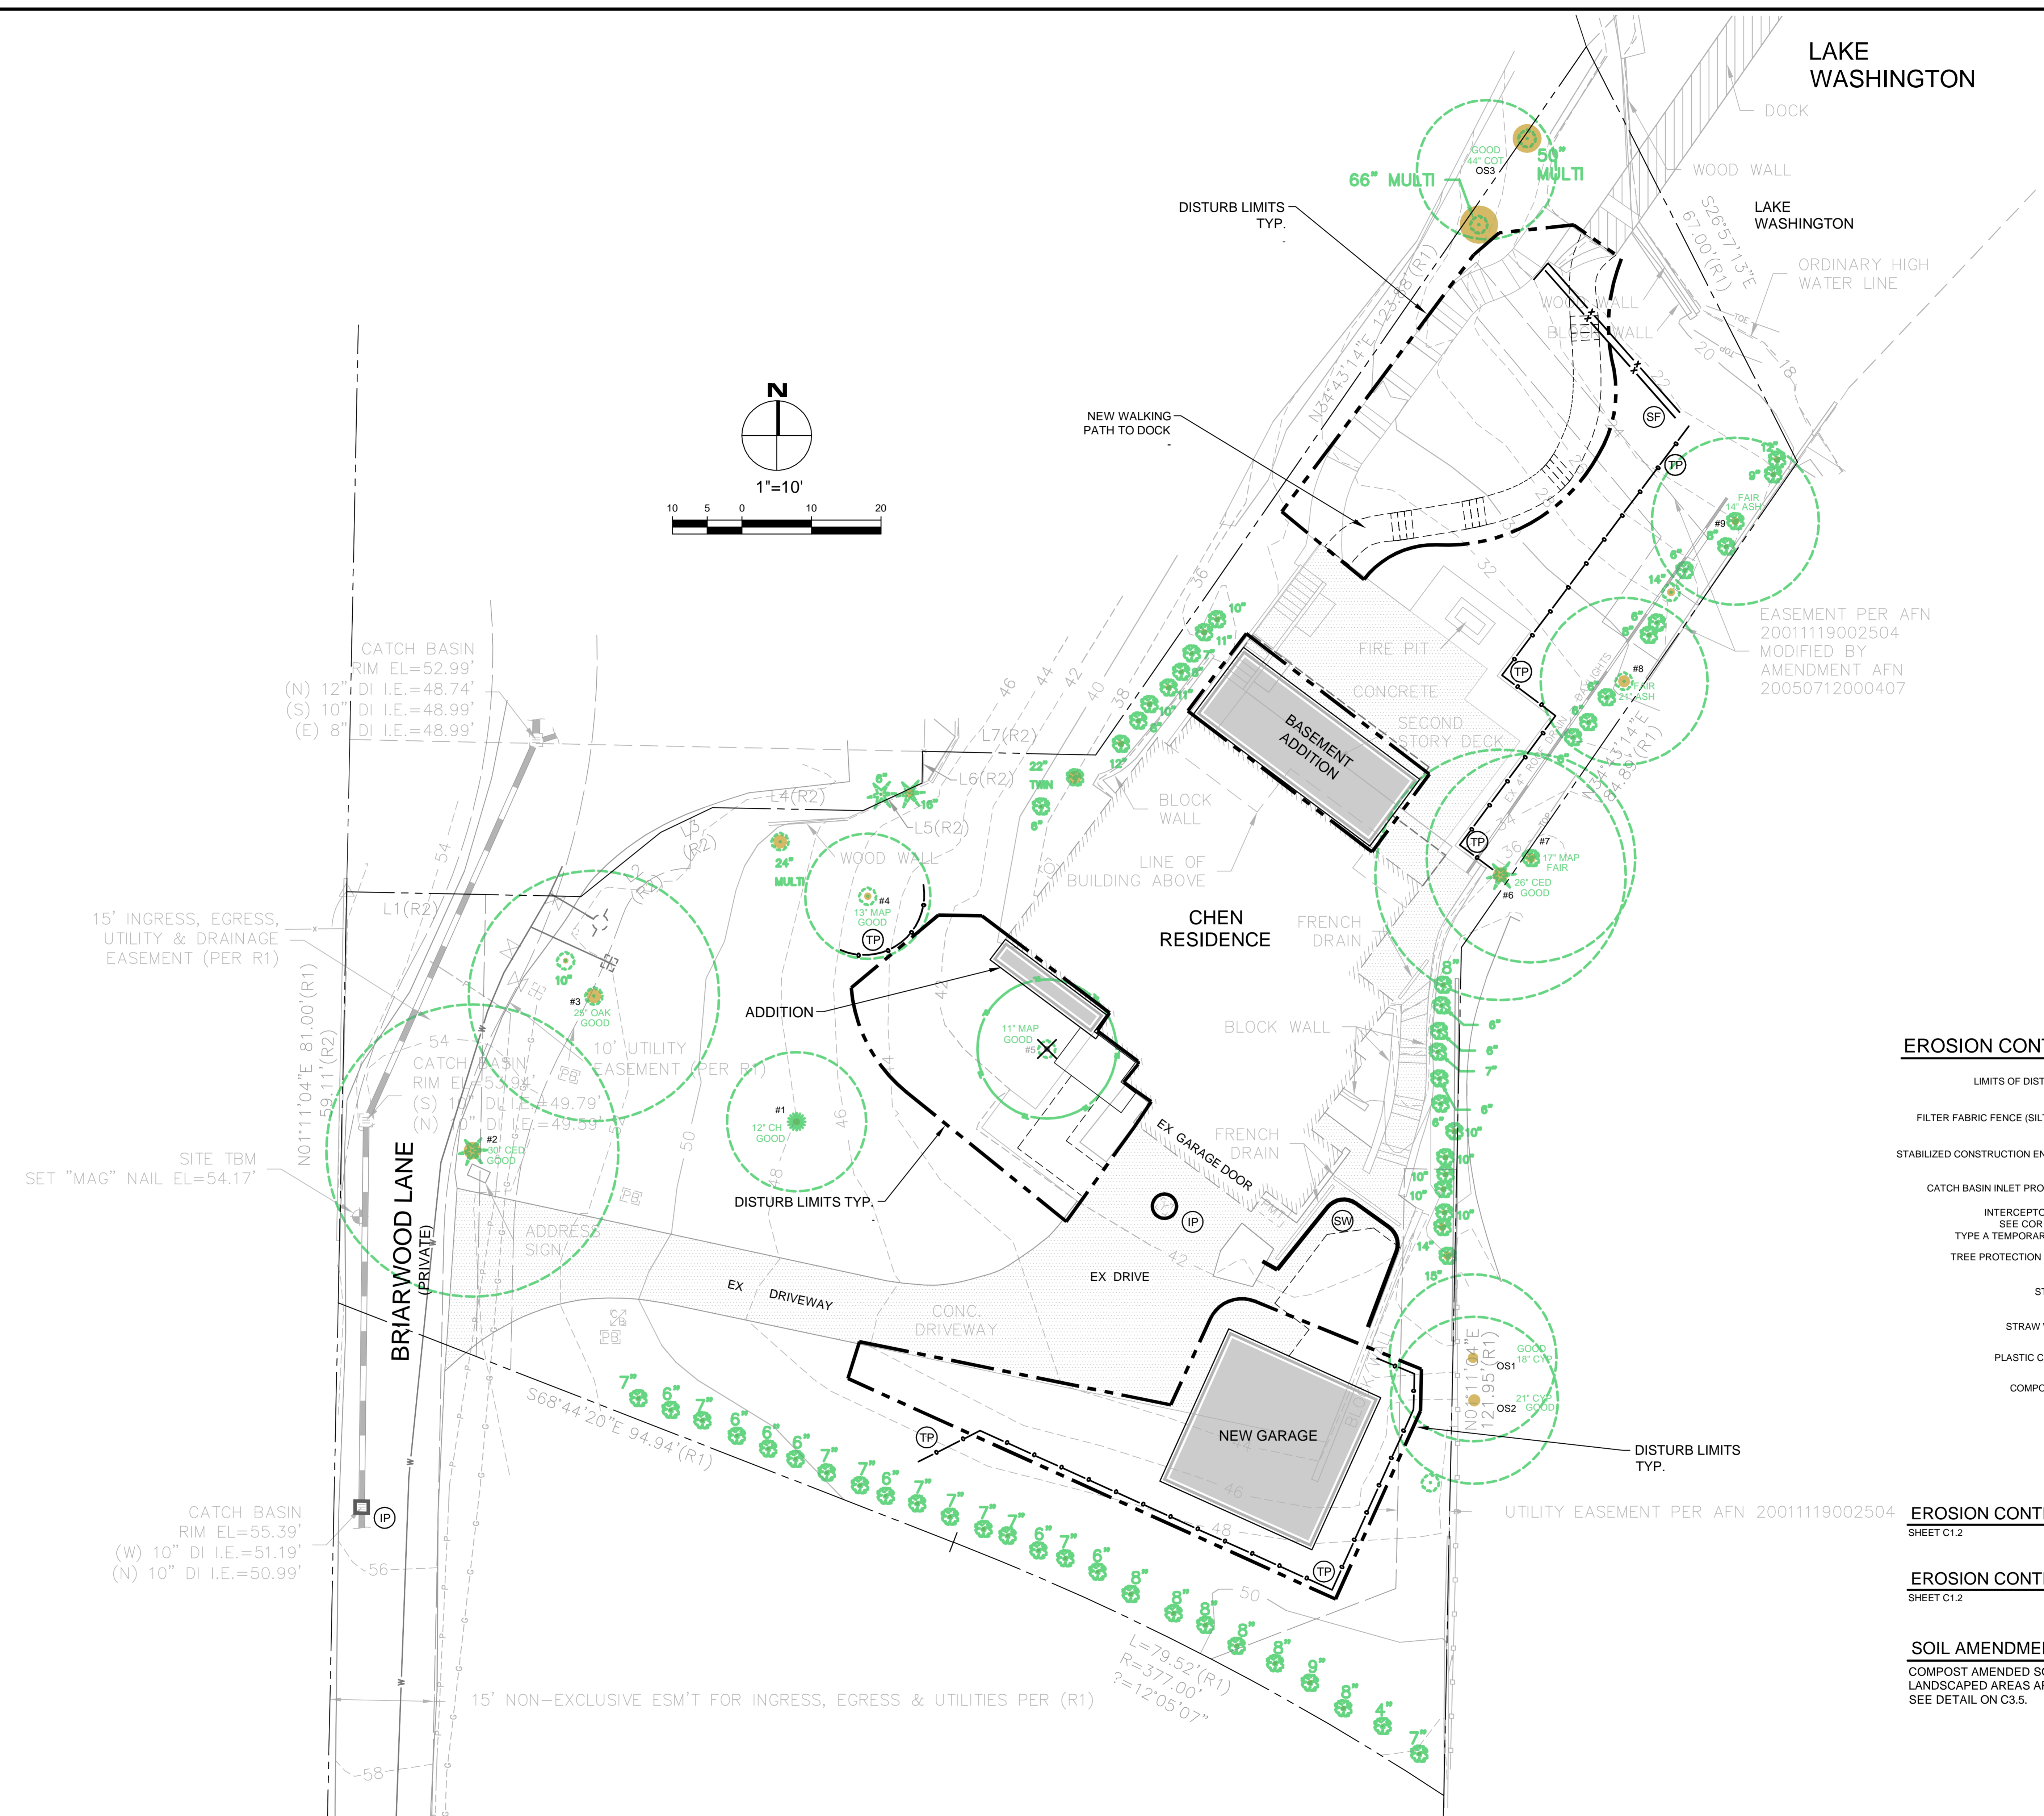
DETAIL 1"=1'-0" 12



TYP CHANNEL CONN. DETAIL 1"=1'-0" 16

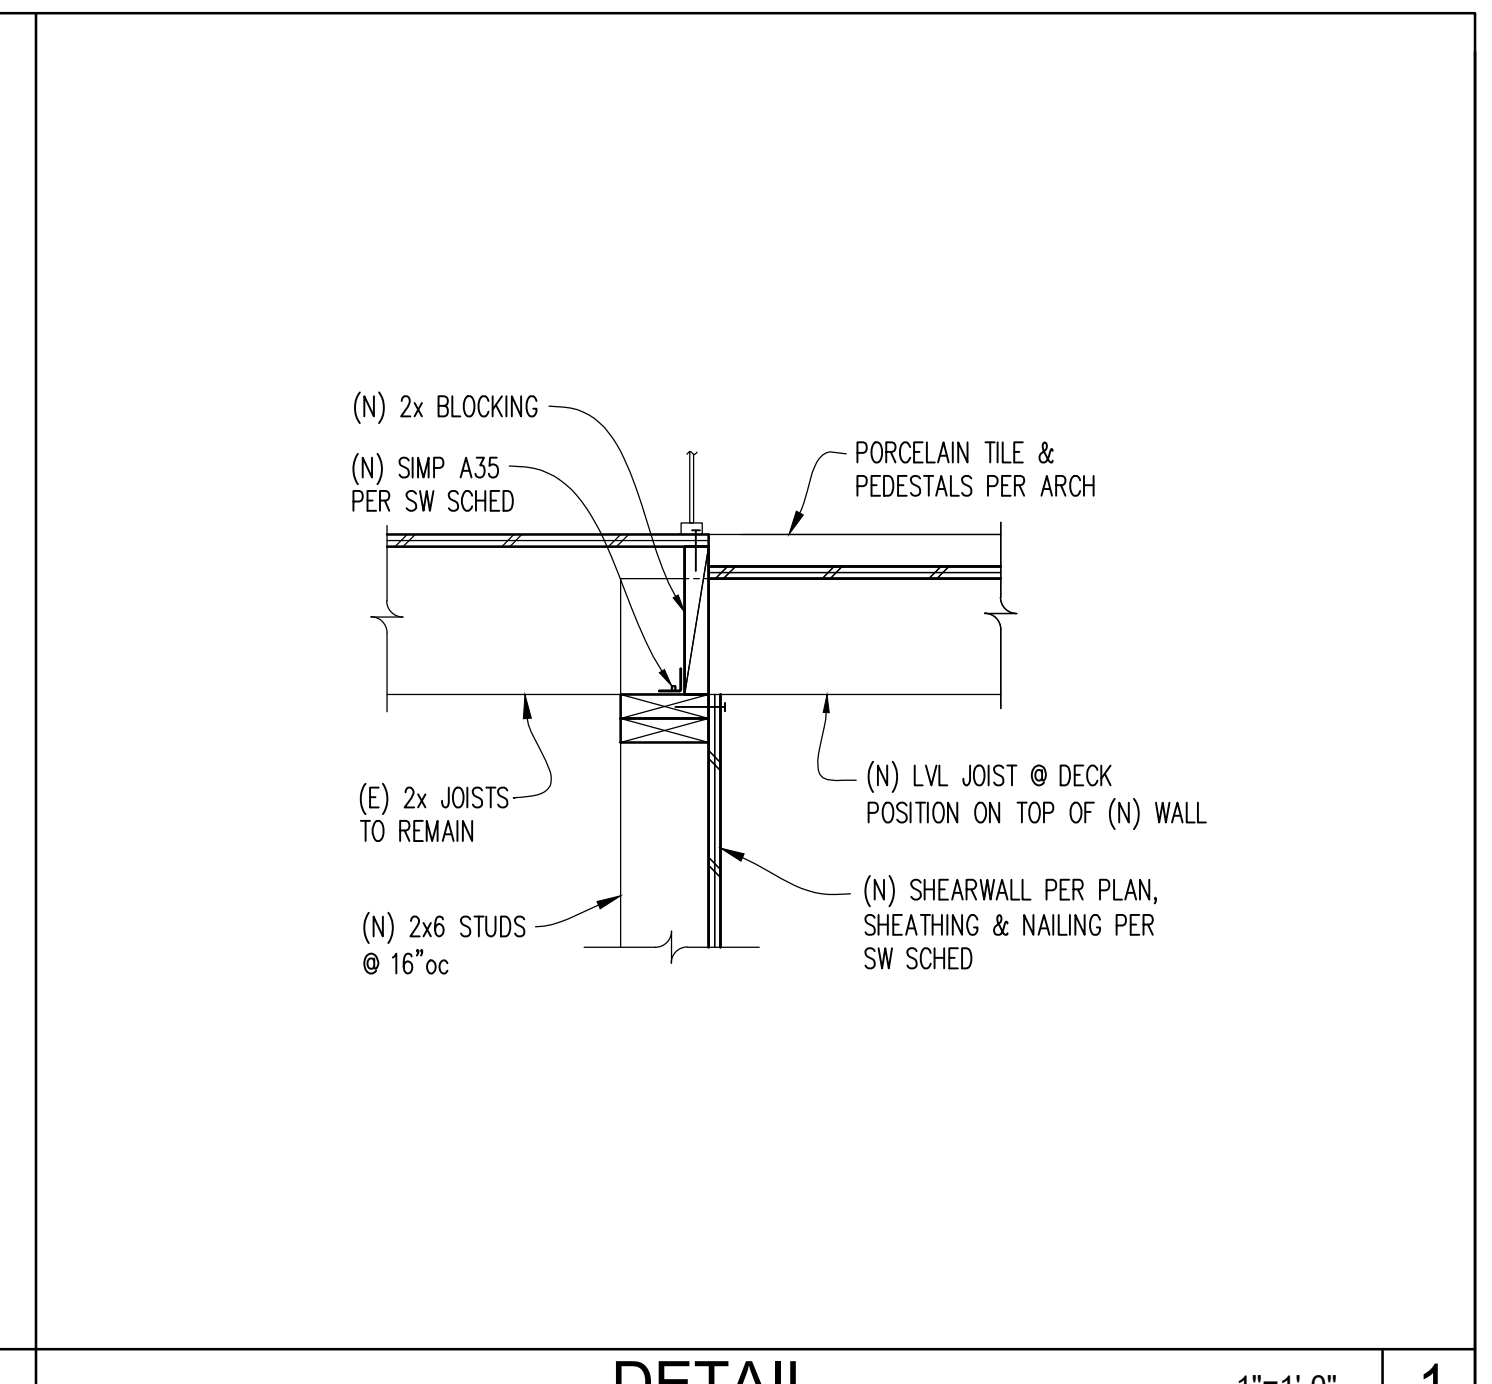

DETAIL 1"=1'-0" 20

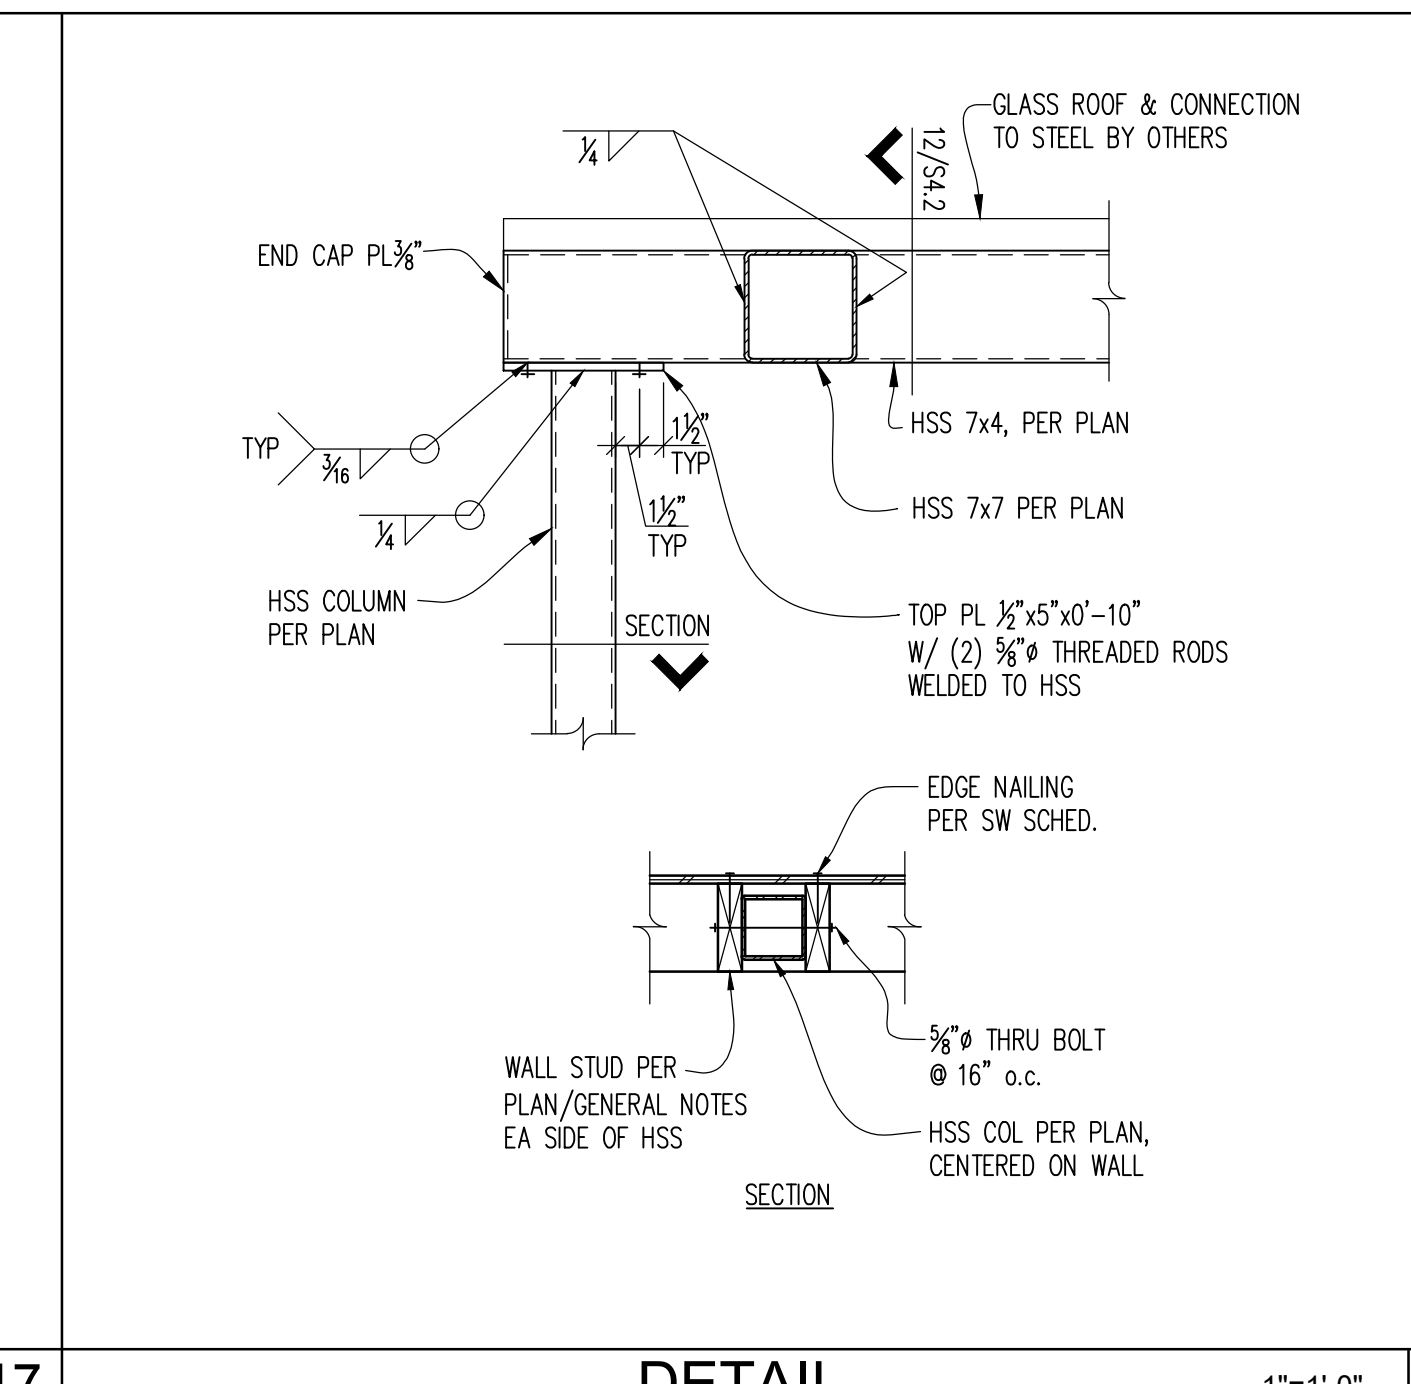

LAKE WASHINGTON

DOCK  
WOOD WALL  
LAKE WASHINGTON  
ORDINARY HIGH WATER LINE

EASEMENT PER AFN 20011119002504 MODIFIED BY AMENDMENT AFN 20050712000407

15' INGRESS, EGRESS, UTILITY & DRAINAGE EASEMENT (PER R1)

SITE TBM SET "MAG" NAIL EL=54.17'

CATCH BASIN RIM EL=55.39'  
(W) 10" DI I.E.=51.19'  
(N) 10" DI I.E.=50.99'

15' NON-EXCLUSIVE ESM'T FOR INGRESS, EGRESS & UTILITIES PER (R1)

**EROSION CONTROL LEGEND**

- LIMITS OF DISTURBANCE
  - FILTER FABRIC FENCE (SILT FENCE) (SF)
  - STABILIZED CONSTRUCTION ENTRANCE (CE)
  - CATCH BASIN INLET PROTECTION (IP)
  - INTERCEPTOR SWALE (SEE COR DWG 504, TYPE A TEMPORARY SWALE) (IS)
  - TREE PROTECTION FENCING (TP)
  - STOCKPILE (ST)
  - STRAW WATTLES (SW)
  - PLASTIC COVERING (PC)
  - COMPOST SOCK (CS)
- USE AS NEEDED  
COVER EXPOSED AREAS WITHIN MERCER ISLAND TIME LIMIT  
SEDIMENT CONTROL OPTION RECOMMENDED IN LIEU OF SILT FENCE

**EROSION CONTROL NOTES**

SHEET C1.2

**EROSION CONTROL DETAILS**

SHEET C1.2


**SOIL AMENDMENT REQUIRED**  
COMPOST AMENDED SOIL REQUIRED ON ALL LANDSCAPED AREAS AFTER CONSTRUCTION. SEE DETAIL ON C3.5.

NO.	DATE	BY	REVISIONS

APPLICANT  
MN CUSTOM HOMES: JOE NAISETH  
1412 112TH AVE. NE, SUITE #104  
BELLEVUE, WA 98004  
PHONE: 206-353-5823



DATE: Dec 22, 2020  
JOB# 1933  
DRAFTED: CH DESIGN: DE  
DIGITAL SIGNATURE

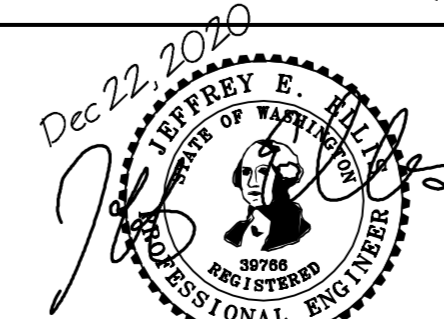


**CIVIL ENGINEERING SOLUTIONS**  
2244 NW MARKET STREET, SUITE B SEATTLE, WA 98107  
PHONE: 206-930-0342 DUFFY@CESOLUTIONS.WS

**EROSION CONTROL PLAN  
TREE RETENTION PLAN**  
CHEN RESIDENCE ADDITION  
9820 SE 35th PLACE, MERCER ISLAND, WA 98040


DRAWING NO:  
**C1.0**  
APN 082405-9027

**SILT FENCE DETAIL** **DOE**

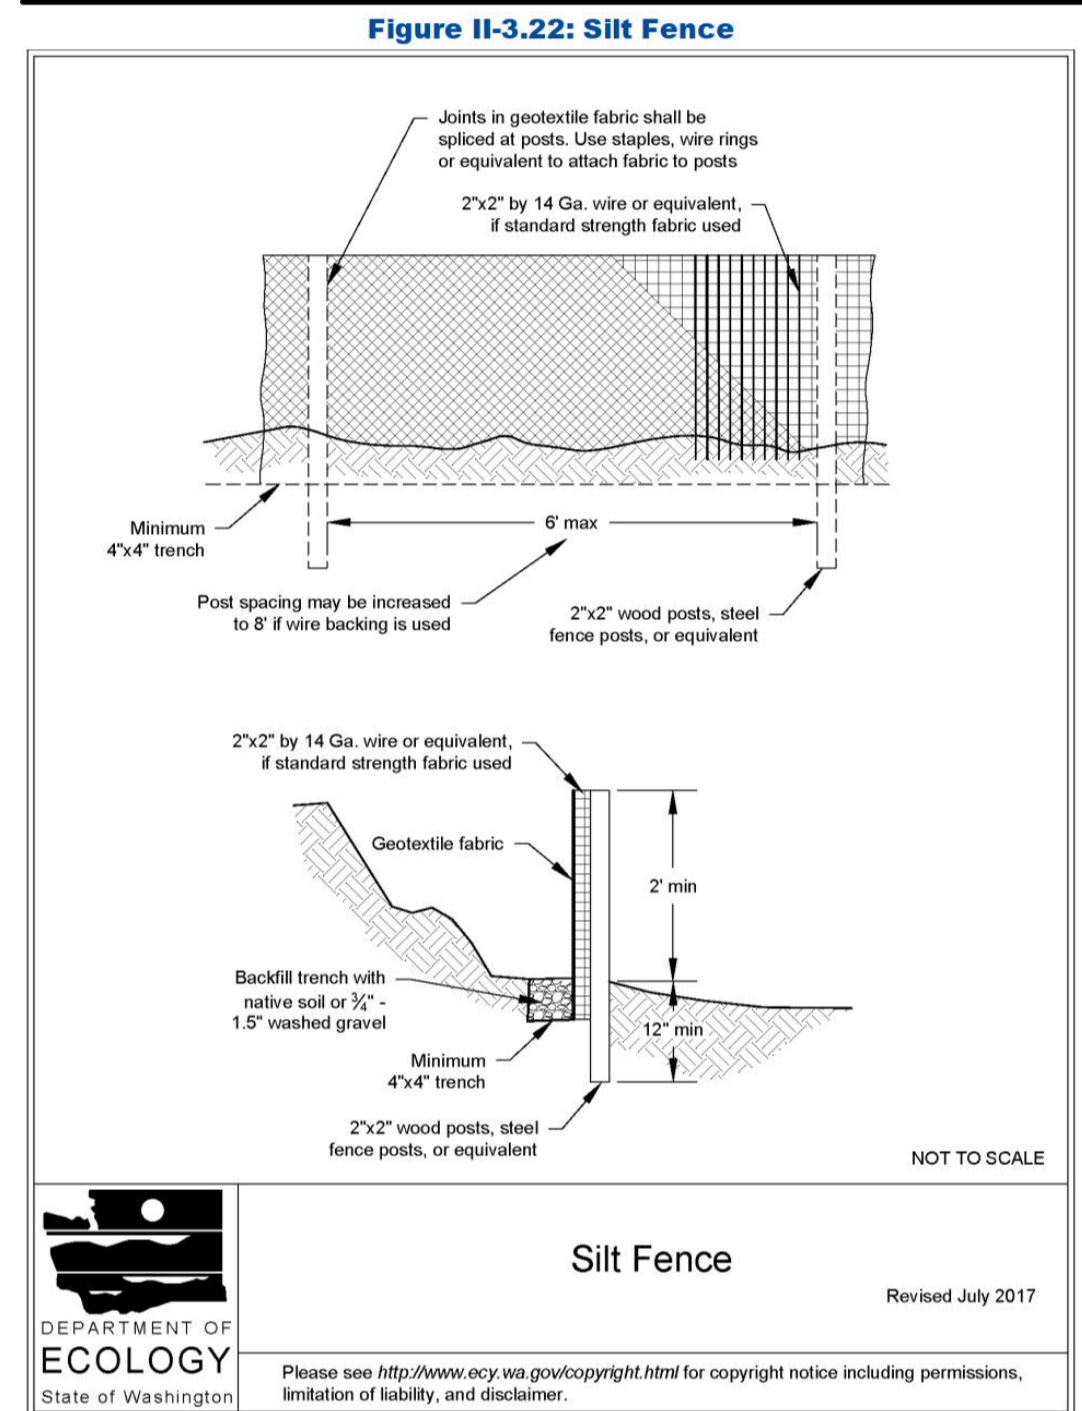

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**CONSTRUCTION ENTRANCE** **DOE**

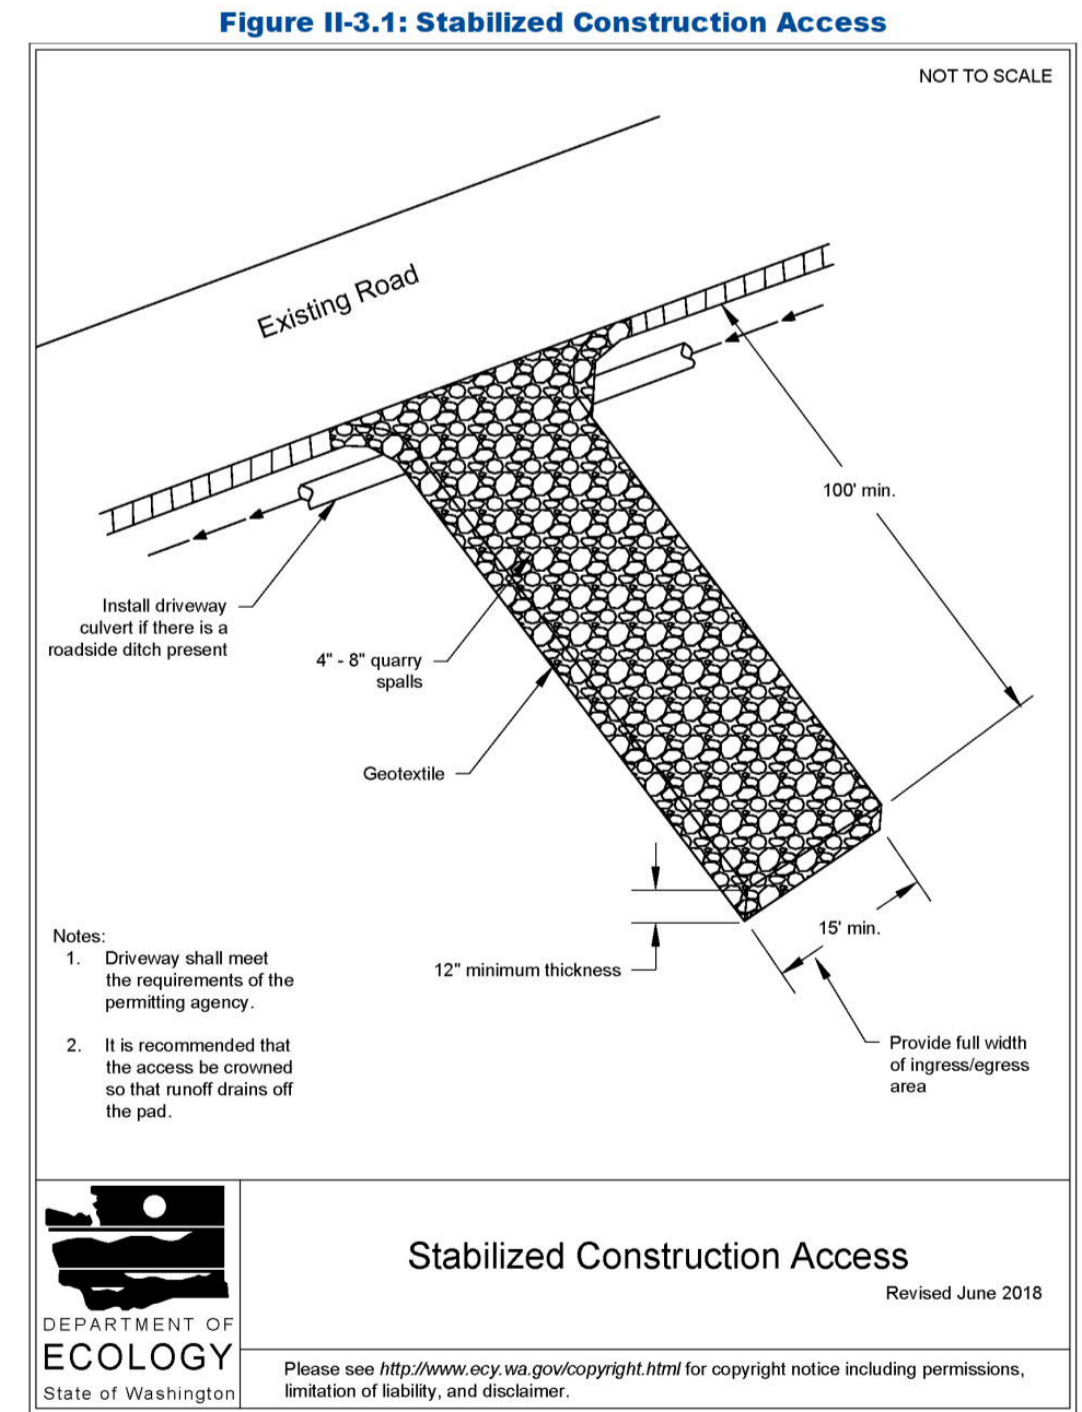

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**RECOMMENDED CONSTRUCTION SEQUENCE**

A DETAILED CONSTRUCTION SEQUENCE IS NEEDED TO ENSURE THAT EROSION AND SEDIMENT CONTROL MEASURES ARE APPLIED AT THE APPROPRIATE TIMES. A RECOMMENDED CONSTRUCTION SEQUENCE IS PROVIDED BELOW:

1. HOLD AN ONSITE PRE-CONSTRUCTION MEETING.
2. POST SIGN WITH NAME AND PHONE NUMBER OF ESC SUPERVISOR (MAY BE CONSOLIDATED WITH THE REQUIRED NOTICE OF CONSTRUCTION SIGN).
3. FLAG OR FENCE CLEARING LIMITS.
4. INSTALL CATCH BASIN PROTECTION, IF REQUIRED.
5. GRADE AND INSTALL CONSTRUCTION ENTRANCE(S).
6. INSTALL PERIMETER PROTECTION (SILT FENCE, BRUSH BARRIER, ETC.).
7. CONSTRUCT SEDIMENT PONDS AND TRAPS.
8. GRADE AND STABILIZE CONSTRUCTION ROADS.
9. CONSTRUCT SURFACE WATER CONTROLS (INTERCEPTOR DIKES, PIPE SLOPE DRAINS, ETC.) SIMULTANEOUSLY WITH CLEARING AND GRADING FOR PROJECT DEVELOPMENT.
10. MAINTAIN EROSION CONTROL MEASURES IN ACCORDANCE WITH CITY OF MERCER ISLAND STANDARDS AND MANUFACTURER'S RECOMMENDATIONS.
11. RELOCATE SURFACE WATER CONTROLS OR TESC MEASURES, OR INSTALL NEW MEASURES SO THAT AS SITE CONDITIONS CHANGE, THE TESC IS ALWAYS IN ACCORDANCE WITH CITY OF MERCER ISLAND TESC REQUIREMENTS.
12. COVER ALL AREAS THAT WILL BE UN-WORKED FOR MORE THAN SEVEN DAYS DURING THE DRY SEASON (MAY 1 TO SEPT 30) OR TWO DAYS DURING THE WET SEASON (OCT 1 TO APRIL 30) WITH STRAW, WOOD FIBER MULCH, COMPOST, PLASTIC SHEETING, OR EQUIVALENT.
13. STABILIZE ALL AREAS WITHIN SEVEN DAYS OF REACHING FINAL GRADE.
14. SEED, SOO, STABILIZE, OR COVER ANY AREAS TO REMAIN UNWORKED FOR MORE THAN 30 DAYS.
15. UPON COMPLETION OF THE PROJECT, STABILIZE ALL DISTURBED AREAS AND REMOVE B MPS IF APPROPRIATE.

**EROSION CONTROL NOTES**

D.8.2 STANDARD ESC PLAN NOTES  
THE STANDARD ESC PLAN NOTES MUST BE INCLUDED ON ALL ESC PLANS. AT THE APPLICANT'S DISCRETION, NOTES THAT IN NO WAY APPLY TO THE PROJECT MAY BE OMITTED; HOWEVER, THE REMAINING NOTES MUST NOT BE RENUMBERED. FOR EXAMPLE, IF ESC NOTE #3 WERE OMITTED, THE REMAINING NOTES SHOULD BE NUMBERED 1, 2, 4, 5, 6, ETC.

1. APPROVAL OF THIS EROSION AND SEDIMENTATION CONTROL (ESC) PLAN DOES NOT CONSTITUTE AN APPROVAL OF PERMANENT ROAD OR DRAINAGE DESIGN (E.G., SIZE AND LOCATION OF ROADS, PIPES, RESTRICTORS, CHANNELS, RETENTION FACILITIES, UTILITIES, ETC.).
2. THE IMPLEMENTATION OF THESE ESC PLANS AND THE CONSTRUCTION, MAINTENANCE, REPLACEMENT, AND UPGRADING OF THESE ESC FACILITIES IS THE RESPONSIBILITY OF THE APPLICANT/ESC SUPERVISOR UNTIL ALL CONSTRUCTION IS APPROVED.
3. THE BOUNDARIES OF THE CLEARING LIMITS SHOWN ON THIS PLAN SHALL BE CLEARLY FLAGGED BY SURVEY TAPE OR FENCING. IF REQUIRED, PRIOR TO CONSTRUCTION (BWM APPENDIX D). DURING THE CONSTRUCTION PERIOD, NO DISTURBANCE BEYOND THE CLEARING LIMITS SHALL BE PERMITTED. THE CLEARING LIMITS SHALL BE MAINTAINED BY THE APPLICANT/ESC SUPERVISOR FOR THE DURATION OF CONSTRUCTION.
4. STABILIZED CONSTRUCTION ENTRANCES SHALL BE INSTALLED AT THE BEGINNING OF CONSTRUCTION AND MAINTAINED FOR THE DURATION OF THE PROJECT. ADDITIONAL MEASURES, SUCH AS CONSTRUCTED WHEEL WASH SYSTEMS OR WASH PADS, MAY BE REQUIRED TO ENSURE THAT ALL PAVED AREAS ARE KEPT CLEAN AND TRACK OUT TO ROAD RIGHT OF WAY DOES NOT OCCUR FOR THE DURATION OF THE PROJECT.
5. THE ESC FACILITIES SHOWN ON THIS PLAN MUST BE CONSTRUCTED PRIOR TO OR IN CONJUNCTION WITH ALL CLEARING AND GRADING SO AS TO ENSURE THAT THE TRANSPORT OF SEDIMENT TO SURFACE WATERS, DRAINAGE SYSTEMS, AND ADJACENT PROPERTIES IS MINIMIZED.
6. THE ESC FACILITIES SHOWN ON THIS PLAN ARE THE MINIMUM REQUIREMENTS FOR ANTICIPATED SITE CONDITIONS. DURING THE CONSTRUCTION PERIOD, THESE ESC FACILITIES SHALL BE UPGRADED AS NEEDED FOR UNEXPECTED STORM EVENTS AND MODIFIED TO ACCOUNT FOR CHANGING SITE CONDITIONS (E.G. ADDITIONAL COVER MEASURES, ADDITIONAL SUMP PUMPS, RELOCATION OF DITCHES AND SILT FENCES, PERIMETER PROTECTION ETC.) AS DIRECTED BY CITY OF MERCER ISLAND.
7. THE ESC FACILITIES SHALL BE INSPECTED DAILY BY THE APPLICANT/ESC SUPERVISOR AND MAINTAINED TO ENSURE CONTINUED PROPER FUNCTIONING. WRITTEN RECORDS SHALL BE KEPT OF WEEKLY REVIEWS OF THE ESC FACILITIES.
8. ANY AREAS OF EXPOSED SOILS, INCLUDING ROADWAY EMBANKMENTS, THAT WILL NOT BE DISTURBED FOR TWO CONSECUTIVE DAYS DURING THE WET SEASON OR SEVEN DAYS DURING THE DRY SEASON SHALL BE IMMEDIATELY STABILIZED WITH THE APPROVED ESC METHODS (E.G., SEEDING, MULCHING, PLASTIC COVERING, ETC.).
9. ANY AREA NEEDING ESC MEASURES THAT DO NOT REQUIRE IMMEDIATE ATTENTION SHALL BE ADDRESSED WITHIN SEVEN (7) DAYS.
10. THE ESC FACILITIES ON INACTIVE SITES SHALL BE INSPECTED AND MAINTAINED A MINIMUM OF ONCE A MONTH DURING THE DRY SEASON, BI-MONTHLY DURING THE WET SEASON, OR WITHIN TWENTY FOUR (24) HOURS FOLLOWING A STORM EVENT.
11. AT NO TIME SHALL MORE THAN ONE (1) FOOT OF SEDIMENT BE ALLOWED TO ACCUMULATE WITHIN A CATCH BASIN. ALL CATCH BASINS AND CONVEYANCE LINES SHALL BE CLEANED PRIOR TO PAVING. THE CLEANING OPERATION SHALL NOT FLUSH SEDIMENT-LADEN WATER INTO THE DOWNSTREAM SYSTEM.
12. ANY PERMANENT RETENTION/DETENTION FACILITY USED AS A TEMPORARY SETTLING BASIN SHALL BE MODIFIED WITH THE NECESSARY EROSION CONTROL MEASURES AND SHALL PROVIDE ADEQUATE STORAGE CAPACITY. IF THE FACILITY IS TO FUNCTION ULTIMATELY AS AN INFILTRATION SYSTEM, THE TEMPORARY FACILITY MUST BE ROUGH GRADED SO THAT THE BOTTOM AND SIDES ARE AT LEAST THREE FEET ABOVE THE FINAL GRADE OF THE PERMANENT FACILITY.
13. COVER MEASURES WILL BE APPLIED IN CONFORMANCE WITH APPENDIX D OF THE SURFACE WATER DESIGN MANUAL.
14. PRIOR TO THE BEGINNING OF THE WET SEASON (OCT. 1), ALL DISTURBED AREAS SHALL BE REVIEWED TO IDENTIFY WHICH ONES CAN BE SEEDED IN PREPARATION FOR THE WINTER RAINS. DISTURBED AREAS SHALL BE SEEDED WITHIN ONE WEEK OF THE BEGINNING OF THE WET SEASON.


**CITY NOTES**

1. ANY CHANGES TO THE APPROVED PLANS REQUIRES CITY APPROVAL THROUGH A REVISION.
2. APPLICANT IS RESPONSIBLE FOR ANY DAMAGES TO UNDERGROUND UTILITIES CAUSED FROM THIS CONSTRUCTION.
3. CATCH BASIN FILTERS SHOULD BE PROVIDED FOR ALL STORM DRAIN CATCH BASINS/INLETS DOWNSLOPE AND WITHIN 500 FEET OF THE CONSTRUCTION AREA. CATCH BASIN FILTERS SHOULD BE DESIGNED BY THE MANUFACTURER FOR USE AT CONSTRUCTION SITES AND APPROVED BY THE CITY INSPECTOR. CATCH BASIN FILTERS SHOULD BE INSPECTED FREQUENTLY, ESPECIALLY AFTER STORM EVENTS. IF THE FILTER BECOMES CLOGGED, IT SHOULD BE CLEANED OR REPLACED.
4. CONTRACTORS SHALL VERIFY LOCATIONS AND DEPTHS OF UTILITIES.
5. AT LEAST 48 HOURS PRIOR TO CONSTRUCTION, CALL 'ONE CALL' AT 1.800.424.5555
6. DO NOT BACKFILL WITH NATIVE MATERIAL ON PUBLIC RIGHT-OF-WAY. ALL MATERIAL MUST BE IMPORTED
7. EROSION CONTROL: ALL "LAND DISTURBING ACTIVITY" IS SUBJECT TO PROVISIONS OF MERCER ISLAND ORDINANCE 96C-118 "STORM WATER MANAGEMENT." SPECIFIC ITEMS TO BE FOLLOWED AT YOUR SITE:
8. PROTECT ADJACENT PROPERTIES FROM ANY INCREASED RUNOFF OR SEDIMENTATION DUE TO THE CONSTRUCTION PROJECT THROUGH THE USE OF APPROPRIATE "BEST MANAGEMENT PRACTICES" (BMP) EXAMPLES INCLUDE, BUT ARE NOT LIMITED TO, SEDIMENT TRAPS, SEDIMENT PONDS, FILTER FABRIC FENCES, VEGETATIVE BUFFER STRIPS OR BIOENGINEERED SWALES.
9. CONSTRUCTION ACCESS TO THE SITE SHOULD BE LIMITED TO ONE ROUTE. STABILIZE ENTRANCE WITH QUARRY SPALLS TO PREVENT SEDIMENT FROM LEAVING THE SITE OR ENTERING THE STORM DRAINS.
10. PREVENT SEDIMENT, CONSTRUCTION DEBRIS, PAINTS, SOLVENTS, ETC., OR OTHER TYPES OF POLLUTION FROM ENTERING PUBLIC STORM DRAINS. KEEP ALL POLLUTION ON YOUR SITE.
11. ALL EXPOSED SOILS SHALL REMAIN DENUDED FOR NO LONGER THAN SEVEN (7) DAYS AND SHALL BE STABILIZED WITH MULCH, HAY, OR THE APPROPRIATE GROUND COVER. ALL EXPOSED SOILS SHALL BE COVERED IMMEDIATELY DURING ANY RAIN EVENT.
12. INSTALLATION OF CONCRETE DRIVEWAYS, TREES, SHRUBS, IRRIGATION BOULDERS, BERMS, WALLS, GATES, AND OTHER IMPROVEMENTS ARE NOT ALLOWED IN THE PUBLIC RIGHT-OF-WAY WITHOUT PRIOR APPROVAL, AND AN ENCROACHMENT AGREEMENT AND RIGHT OF WAY PERMIT FROM THE SENIOR DEVELOPMENT ENGINEER.
13. OWNER SHALL CONTROL DISCHARGE OF SURFACE DRAINAGE RUNOFF FROM EXISTING AND NEW IMPERVIOUS AREAS IN A RESPONSIBLE MANNER. CONSTRUCTION OF NEW GUTTERS AND DOWNSPOUTS, DRY WELLS, LEVEL SPREADERS OR DOWNSTREAM CONVEYANCE PIPE MAY BE NECESSARY TO MINIMIZE DRAINAGE IMPACT TO YOUR NEIGHBORS. CONSTRUCTION OF MINIMUM DRAINAGE IMPROVEMENTS SHOWN OR CALLED OUT ON THIS PLAN DOES NOT IMPLY RELIEF FROM CIVIL LIABILITY FOR YOUR DOWNSTREAM DRAINAGE.
14. POT HOLING THE PUBLIC UTILITIES IS REQUIRED PRIOR TO ANY GRADING ACTIVITIES LESS THAN 6" OVER THE PUBLIC MAINS (WATER, SEWER AND STORM SYSTEMS). IF THERE IS A CONFLICT, THE APPLICANT IS REQUIRED TO SUBMIT A REVISION FOR APPROVAL PRIOR TO ANY GRADING ACTIVITIES OVER THE PUBLIC MAINS.
15. REMEMBER: EROSION CONTROL IS YOUR FIRST INSPECTION.
16. ROOF DRAINS MUST BE CONNECTED TO THE STORM DRAIN SYSTEM AND INSPECTED BY THE PUBLIC WORKS DEPARTMENT PRIOR TO ANY BACKFILLING OF PIPE.
17. SILENT FENCE: CLEAN AND PROVIDE REGULAR MAINTENANCE OF THE SILT FENCE. THE FENCE IS TO REMAIN VERTICAL AND IS TO FUNCTION PROPERLY THROUGHOUT THE TERM OF THE PROJECT.
18. WORK IN PUBLIC RIGHT OF WAY REQUIRES A RIGHT-OF-WAY USE PERMIT.
19. REFER TO WATER SERVICE PERMIT FOR ACTUAL LOCATION OF NEW WATER METER AND SERVICE LINE DETERMINED BY MERCER ISLAND WATER DEPARTMENT.
20. THE TV INSPECTION OF THE EXISTING SIDE SEWER TO THE CITY SEWER MAIN IS REQUIRED. IF THE RESULT OF THE TV INSPECTION IS NOT IN SATISFACTORY CONDITION, AS DETERMINED BY THE CITY OF MERCER ISLAND INSPECTOR, THE REPLACEMENT OF THE EXISTING SIDE SEWER IS REQUIRED. ALTERNATELY, A PRESSURE TEST OF THE SIDE SEWER, FROM SEWER MAIN TO POINT OF CONNECTION, MAY BE SUBSTITUTED FOR THE VIDEO INSPECTION.
21. NEWLY INSTALLED SIDE SEWER REQUIRES A 4 P.S.I. AIR TEST OR PROVIDE 10' OF HYDROSTATIC HEAD TEST.
22. POT HOLING THE PUBLIC UTILITIES IS REQUIRED PRIOR TO ANY GRADING ACTIVITIES LESS THAN 6" OVER THE PUBLIC MAINS (WATER, SEWER AND STORM SYSTEMS). IF THERE IS A CONFLICT, THE APPLICANT IS REQUIRED TO SUBMIT A REVISION FOR APPROVAL PRIOR TO ANY GRADING ACTIVITIES OVER THE PUBLIC MAINS.
23. THE LIMITS AND EXTENDS OF THE PAVEMENT IN THE PUBLIC RIGHT OF WAY SHALL BE DETERMINED BY THE CITY ENGINEER PRIOR TO FINALIZE THE PROJECT.

NO.	DATE	BY	REVISIONS

APPLICANT  
MIN CUSTOM HOMES, JOE NAISETH  
1412 112TH AVE. NE, SUITE #104  
BELLEVUE, WA 98004  
PHONE: 206-353-5823

DATE: Dec 21, 2020  
JOB#: 1933  
DRAFTED: SS DESIGN: DE  
DIGITAL SIGNATURE

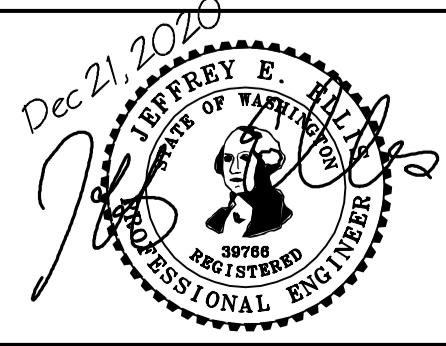

**CIVIL ENGINEERING SOLUTIONS**  
2244 NW MARKET STREET, SUITE B SEATTLE, WA 98107  
PHONE: 206.930.0342  
DUFFY@CESOLUTIONS.WA

**TESC & CITY NOTES**  
**TESC DETAILS**  
CHEN RESIDENCE ADDITION  
9820 SE 35th PLACE, MERCER ISLAND, WA 98040

DRAWING NO:  
**C1.2**  
APN 082405-9027

**SANITARY SEWER IMPROVEMENTS**

- ①
- ②
- ③
- ④
- ⑦

**WATER IMPROVEMENTS**

- ⑩
- ⑪
- ⑫
- ⑭

**STORM DRAIN**

- ⑳ 4" STORM DRAIN (3034 PVC) @ MIN 2 % GRADE
- ㉑ 4" FOUNDATION DRAIN (3034 PVC) @ MIN 1 % GRADE

**STORM DRAIN STRUCTURES**

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**STORM BMP's**

- ⑤① DETAIL NDP-1: COMPOST AMENDED SOIL TO ALL DISTURBED AREAS (SEE DETAIL SHEET C3.5). TILL 2-3" OF COMPOST INTO UPPER 8" OF SOIL. LOOSEN COMPACTED SUBSOIL, IF NEEDED BY RIPPING TO 12" DEPTH. MULCH LANDSCAPE BEDS AFTER PLANTING.

**PRIVATE PVC STORM STRUCTURES**

- ⑩①
- ⑩②
- ⑩③
- ⑩④
- ⑩⑤
- ⑩⑥

**SURVEYOR**

TOPOGRAPHIC & BOUNDARY SURVEY BY:  
 informed land survey  
 PO BOX 5137  
 TACOMA, WA 98415-0137  
 PHONE 253-627-2070  
 admin@i-landsurvey.com  
 www.i-landsurvey.com

**VERTICAL DATUM**

NAVD 1988 PER RTK GPS TIES AND THE WASHINGTON STATE REFERENCE NETWORK (WSRN)  
 SEE SURVEY

**SOIL AMENDMENT REQUIRED**

COMPOST AMENDED SOIL REQUIRED ON ALL LANDSCAPED AREAS AFTER CONSTRUCTION. SEE DETAIL ON C3.5.

**SOIL INSPECTION REQUIRED BY ENGINEER**

A POST CONSTRUCTION INSPECTION & CERTIFICATION OF AMENDED SOILS IS REQUIRED BY A LICENSED CIVIL ENGINEER. THIS IS REQUIRED BEFORE FINAL SIGN-OFF BY CITY.

**LEGAL DESCRIPTION**

**PARCEL A:**  
 LOT 1, CITY OF MERCER ISLAND SHORT PLAT NO. 82-11-26, ACCORDING TO SHORT PLAT RECORDED MARCH 10, 1983 UNDER RECORDING NO. 8303100004, RECORDS OF KING COUNTY, WASHINGTON.

EXCEPT THE PORTION LYING NORTHERLY AND WESTERLY OF THE FOLLOWING DESCRIBED LINE:

COMMENCING AT THE NORTHWEST CORNER OF SAID LOT 1:

THENCE SOUTH 88°49'28" EAST ALONG THE NORTH LINE THEREOF, A DISTANCE OF 82.40 FEET TO THE TRUE POINT OF BEGINNING OF THE HEREIN DESCRIBED LINE; THENCE SOUTH 01°10'32" WEST A DISTANCE OF 4.54 FEET;

THENCE SOUTH 64°49'53" WEST A DISTANCE OF 9.36 FEET;

THENCE NORTH 88°49'28" WEST A DISTANCE OF 21.64 FEET;

THENCE SOUTH 64°21'02" WEST A DISTANCE OF 8.31 FEET;

THENCE SOUTH 51°11'48" WEST A DISTANCE OF 14.70 FEET;

THENCE NORTH 88°49'28" WEST A DISTANCE OF 33.69 FEET, MORE OR LESS TO THE WEST LINE OF SAID LOT 1, AND THE TERMINUS OF THE HEREIN DESCRIBED LINE;



TOGETHER WITH SECOND CLASS SHORELANDS ADJOINING THEREOF;

(ALSO KNOWN AS LOT 1 OF CITY OF MERCER ISLAND LOT LINE ADJUSTMENT NUMBER SUB01-009, RECORDED UNDER RECORDING NUMBER 20021125900027).

**PARCEL B:**

A NON-EXCLUSIVE EASEMENT FOR INGRESS AND EGRESS OVER THAT PORTION OF THE WEST 15 FEET OF THE EAST 80.44 FEET OF SAID GOVERNMENT LOT 5, SECTION 7, TOWNSHIP 24 NORTH, RANGE 5 EAST, WILLAMETTE MERIDIAN IN KING COUNTY, WASHINGTON, LYING SOUTHERLY OF SAID PROPOSED NORTHERLY RIGHT OF WAY LINE OF RELOCATED NORTH MERCER WAY.

SITUATE IN THE CITY OF MERCER ISLAND, COUNTY OF KING, STATE OF WASHINGTON.

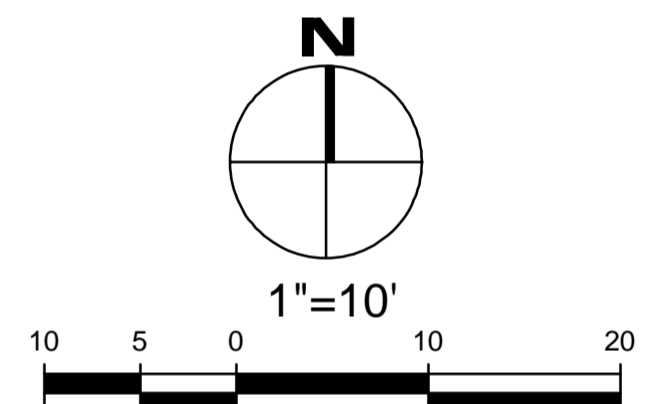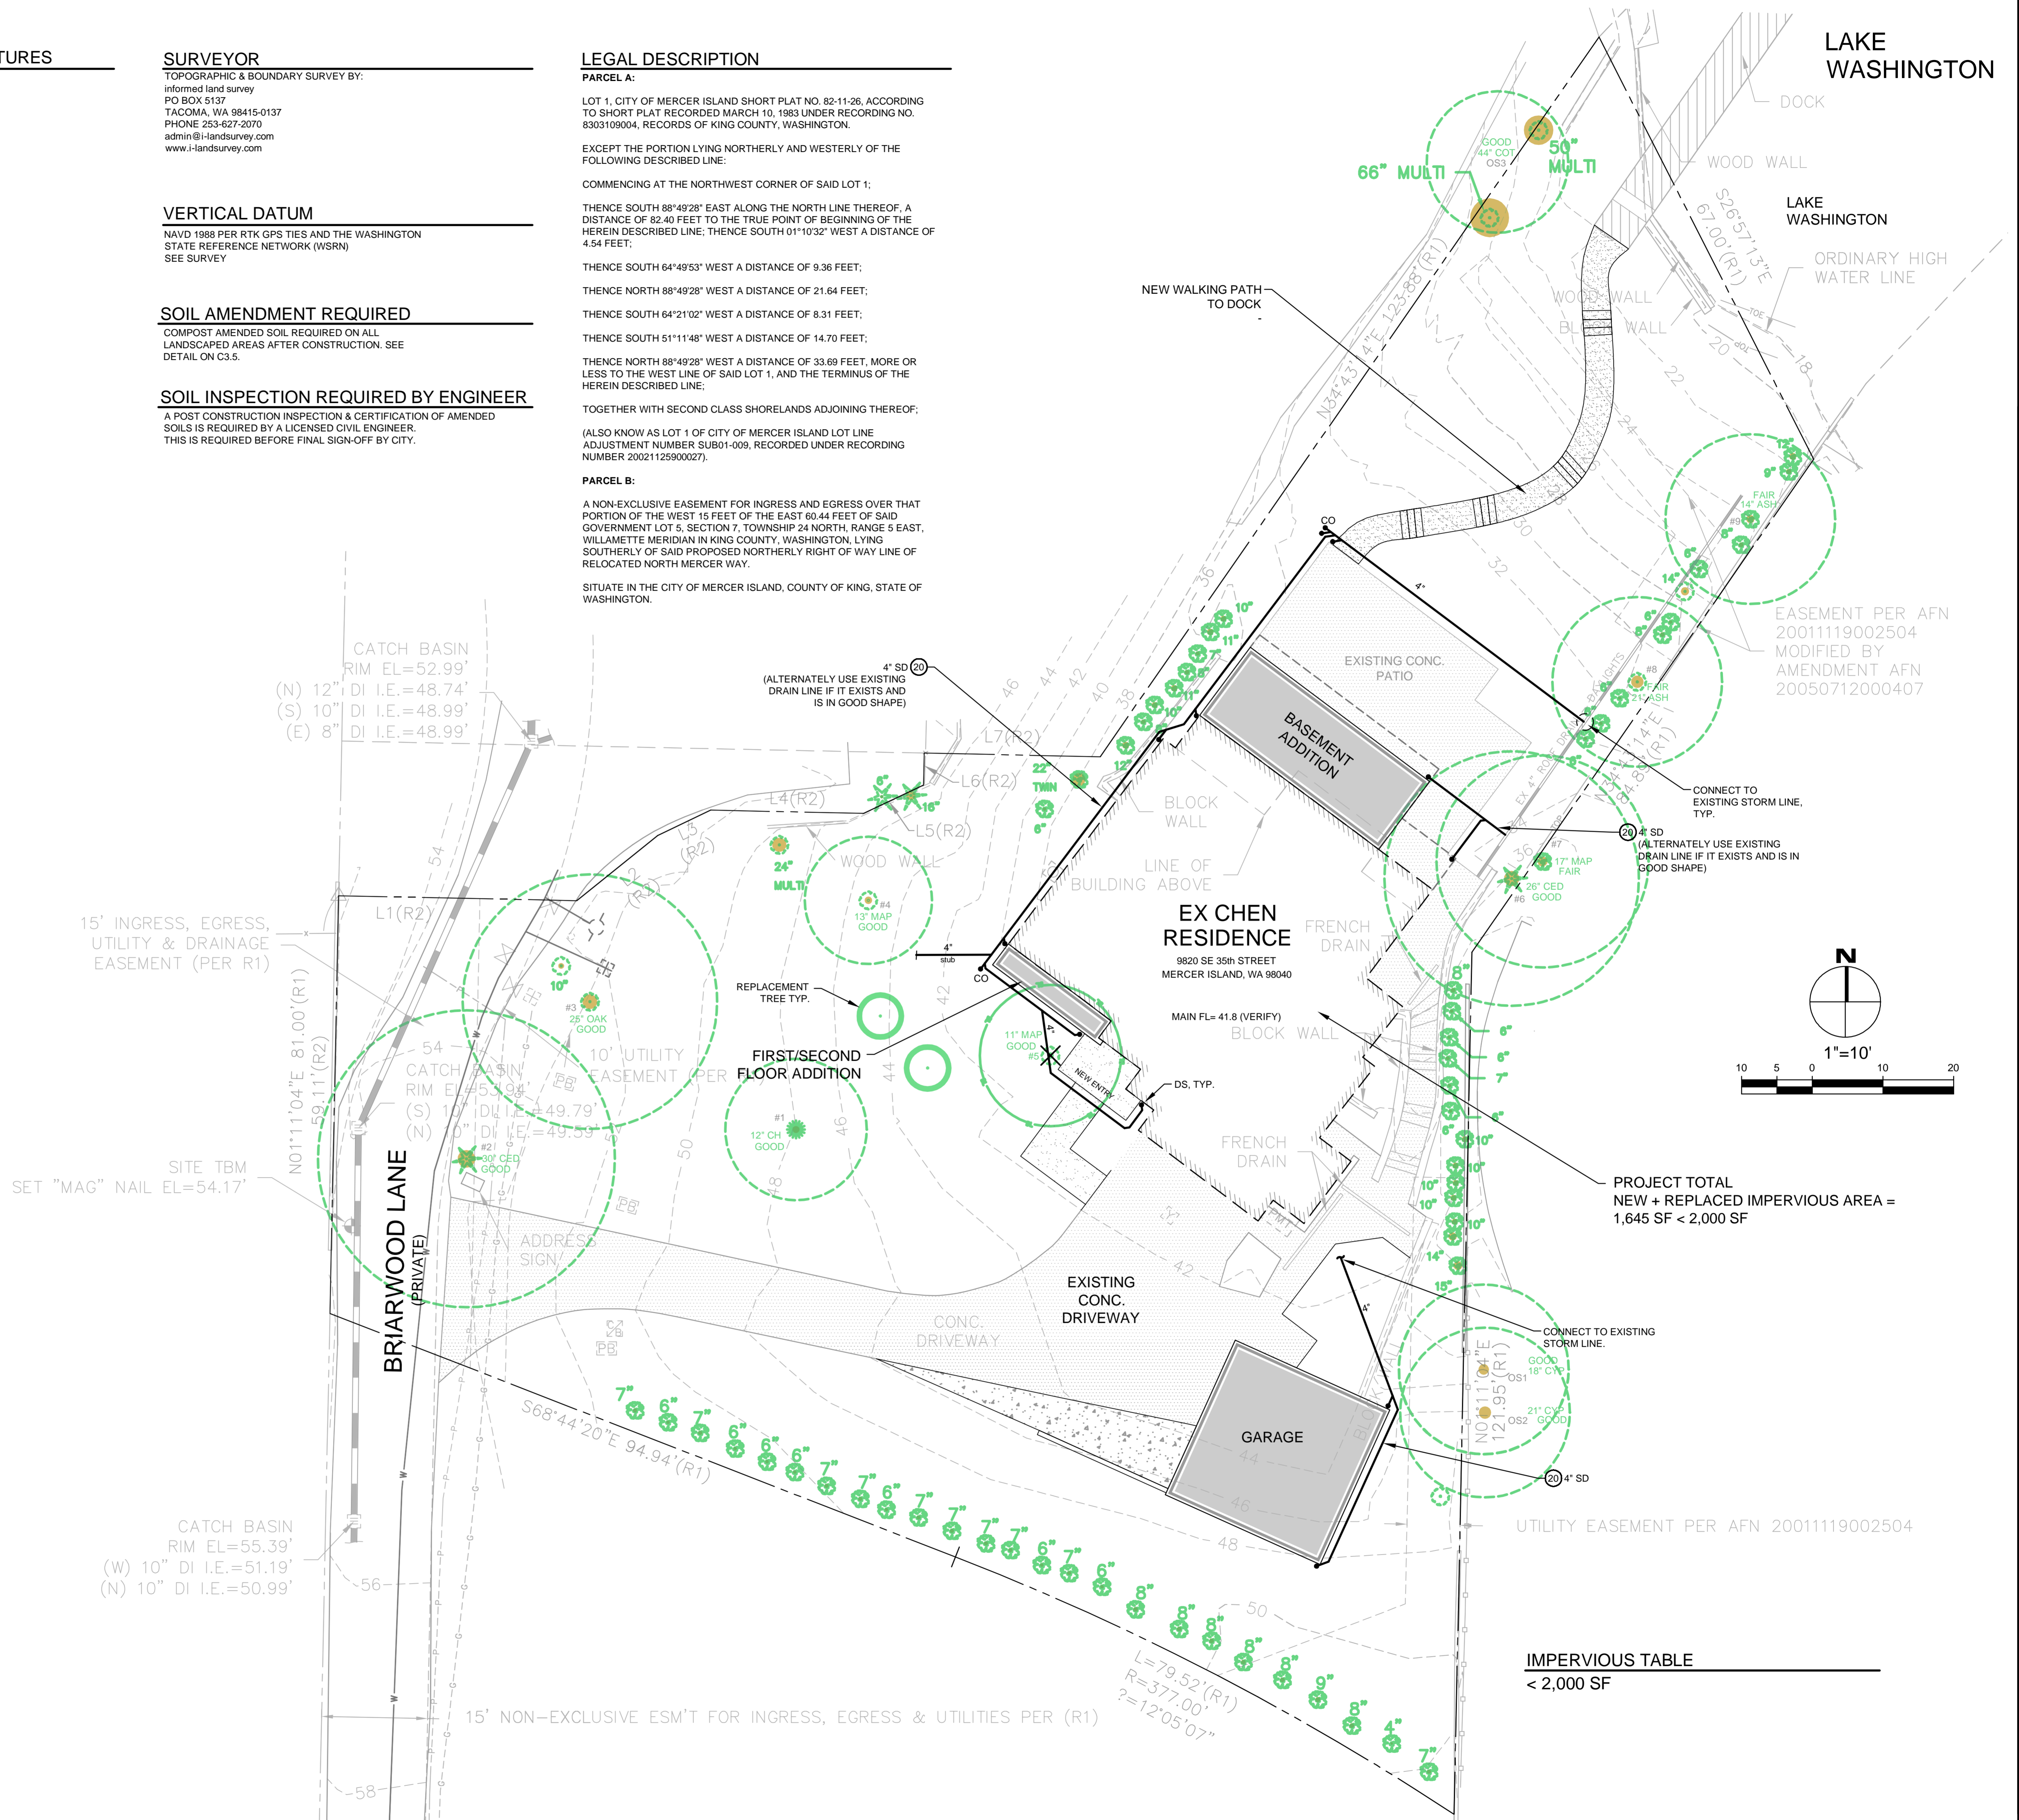


PROJECT TOTAL  
 NEW + REPLACED IMPERVIOUS AREA =  
 1,645 SF < 2,000 SF

IMPERVIOUS TABLE  
 < 2,000 SF

NO.	DATE	BY	REVISIONS

APPLICANT  
 MN CUSTOM HOMES: JOE NAISETH  
 1412 112TH AVE. NE, SUITE #104  
 BELLEVUE, WA 98004  
 PHONE: 206-353-5823

DATE: Dec 22, 2020  
 JOB# 1933  
 DRAFTED: DE DESIGN: DE  
 DIGITAL SIGNATURE

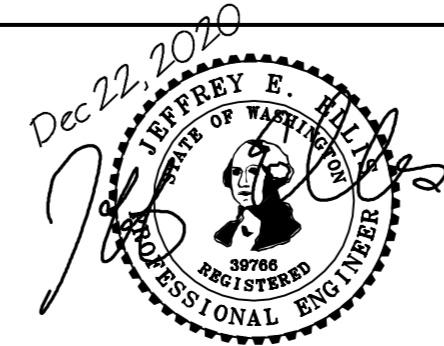

**CIVIL ENGINEERING SOLUTIONS**  
 2244 NW MARKET STREET, SUITE B SEATTLE, WA 98107  
 PHONE: 206-930-0342 DUFFY@CESOLUTIONS.WS

**DRAINAGE / CIVIL PLAN**  
 CHEN RESIDENCE ADDITION  
 9820 SE 35th PLACE, MERCER ISLAND, WA 98040

DRAWING NO:  
**C2.0**  
 APN 082405-9027


**SOIL AMENDMENT REQUIRED**

COMPOST AMENDED SOIL REQUIRED ON ALL LANDSCAPED AREAS AFTER CONSTRUCTION. SEE DETAIL BELOW.

**SOIL INSPECTION REQUIRED BY ENGINEER**

A POST CONSTRUCTION INSPECTION & CERTIFICATION OF AMENDED SOILS IS REQUIRED BY A LICENSED CIVIL ENGINEER. THIS IS REQUIRED BEFORE FINAL SIGN-OFF BY CITY.


**COMPOST AMENDED SOIL SPEC**

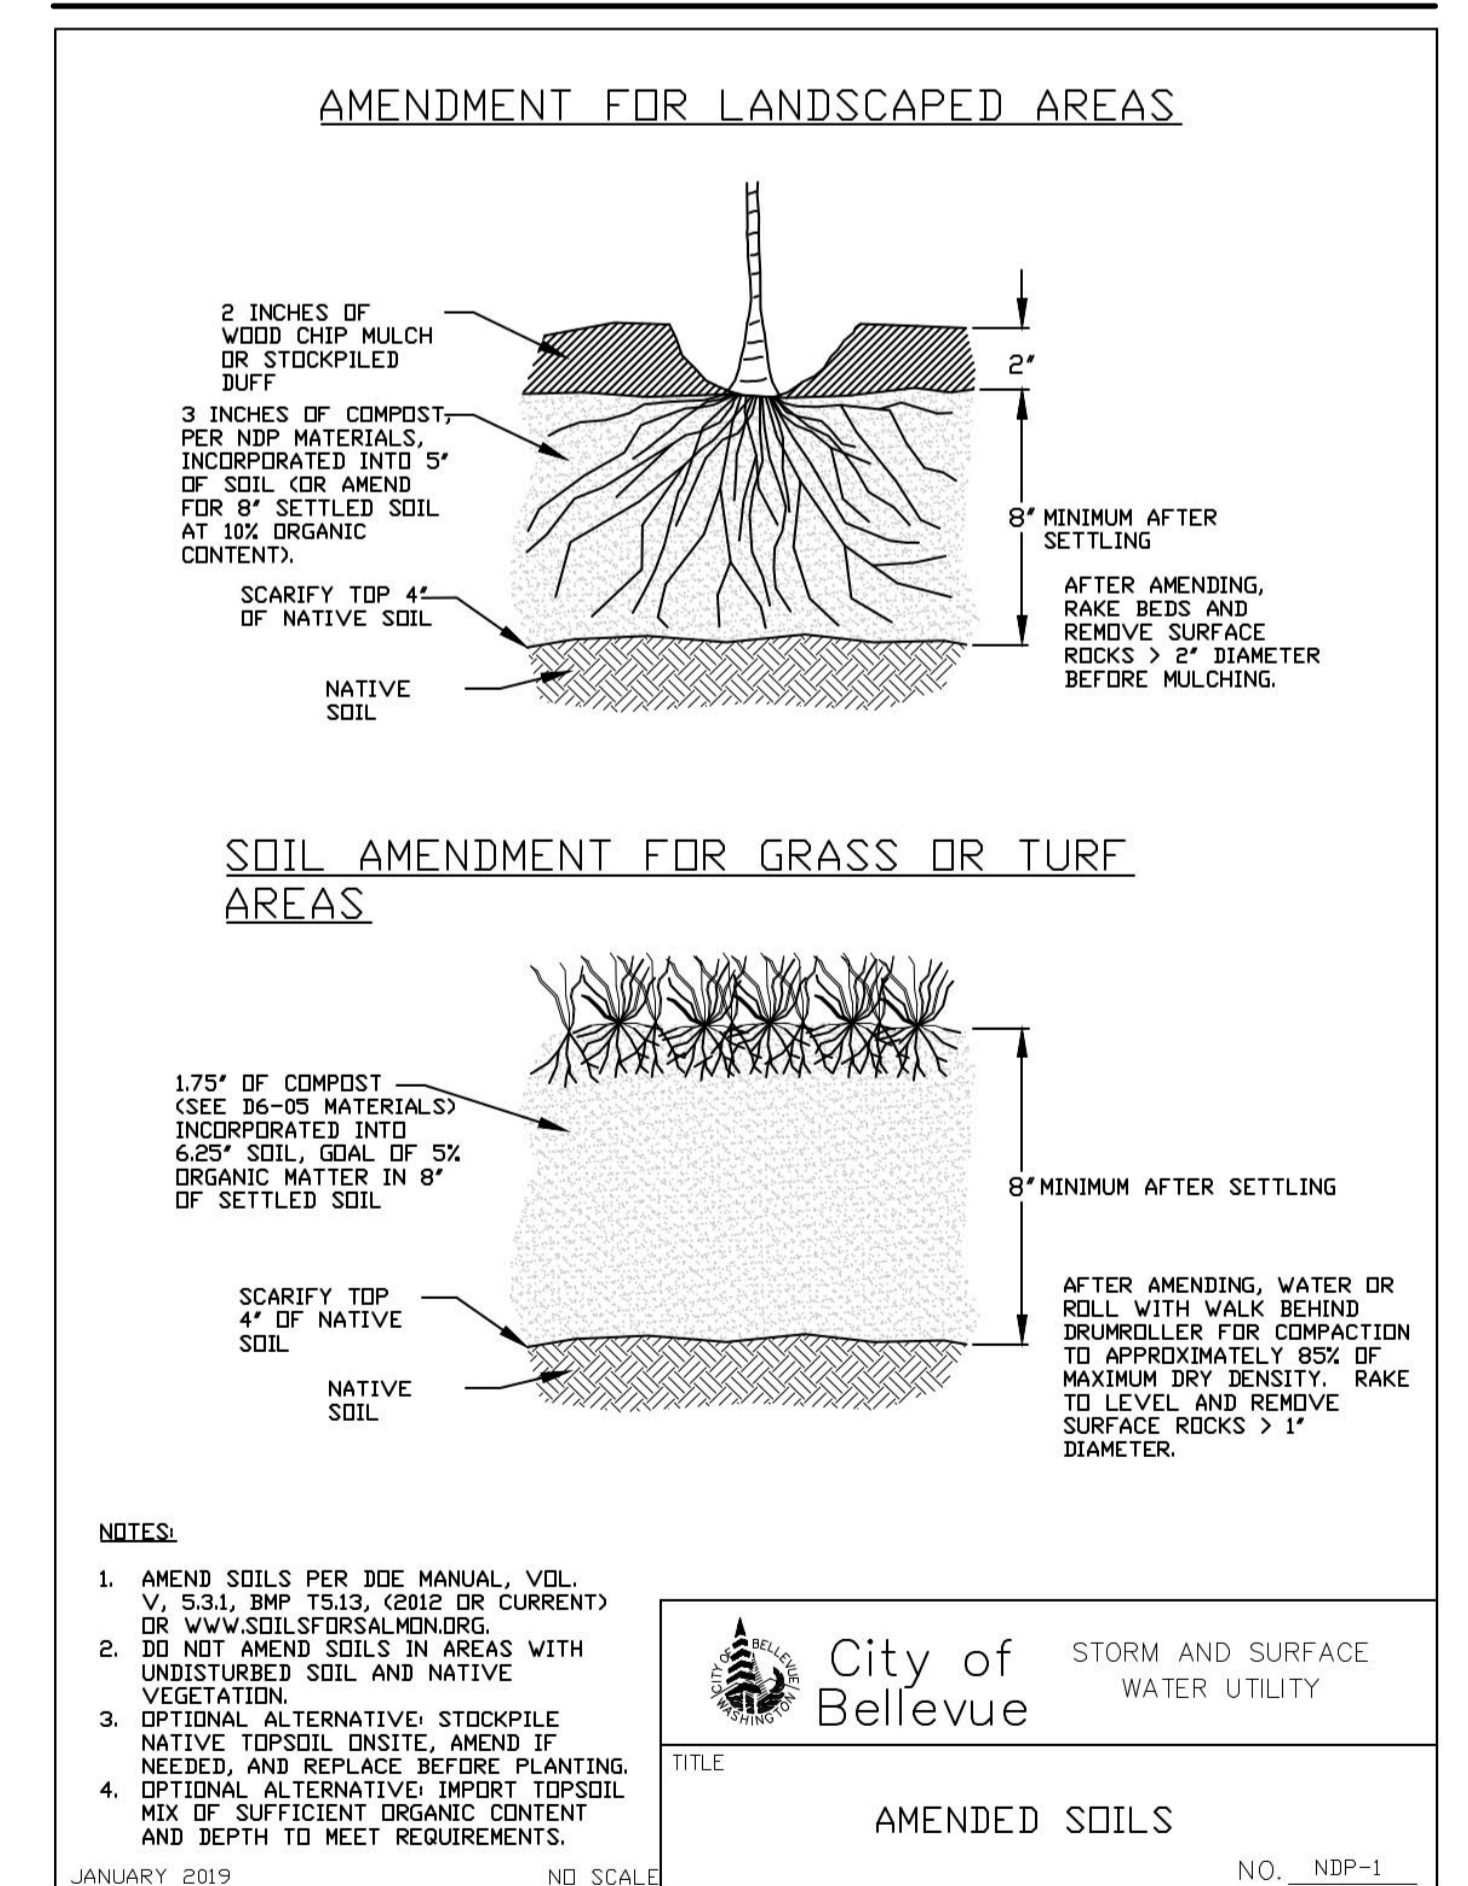

NO.	DATE	BY	REVISIONS

APPLICANT  
 MN CUSTOM HOMES: JOE NAISETH  
 1412 112TH AVE. NE, SUITE #104  
 BELLEVUE, WA 98004  
 PHONE: 206-353-5823

DATE: Dec 21, 2020  
 JOB# 1933  
 DRAFTED: SS DESIGN: SS  
 DIGITAL SIGNATURE

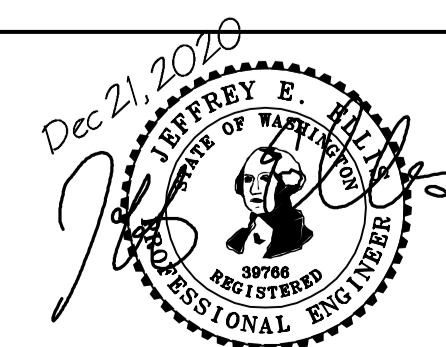

**CIVIL ENGINEERING SOLUTIONS**  
 2244 NW MARKET STREET, SUITE B SEATTLE, WA 98107  
 PHONE: 206.930.0342 DUFFY@CESOLUTIONS.US

**BMP DETAILS**  
 CHEN RESIDENCE ADDITION  
 9820 SE 35th PLACE, MERCER ISLAND, WA 98040

DRAWING NO:  
**C3.5**  
 APN 082405-9027



# TOPOGRAPHIC SURVEY

## LEGAL DESCRIPTION

### PARCEL A:

LOT 1, CITY OF MERCER ISLAND SHORT PLAT NO. 82-11-26, ACCORDING TO SHORT PLAT RECORDED MARCH 10, 1983 UNDER RECORDING NO. 8303109004, RECORDS OF KING COUNTY, WASHINGTON.

EXCEPT THE PORTION LYING NORTHERLY AND WESTERLY OF THE FOLLOWING DESCRIBED LINE: COMMENCING AT THE NORTHWEST CORNER OF SAID LOT 1;

THENCE SOUTH 88°49'28" EAST ALONG THE NORTH LINE THEREOF, A DISTANCE OF 82.40 FEET TO THE TRUE POINT OF BEGINNING OF THE HEREIN DESCRIBED LINE; THENCE SOUTH 01°10'32" WEST A DISTANCE OF 4.54 FEET;

THENCE SOUTH 64°49'53" WEST A DISTANCE OF 9.36 FEET;

THENCE NORTH 88°49'28" WEST A DISTANCE OF 21.64 FEET;

THENCE SOUTH 64°21'02" WEST A DISTANCE OF 8.31 FEET;

THENCE SOUTH 51°11'48" WEST A DISTANCE OF 14.70 FEET;

THENCE NORTH 88°49'28" WEST A DISTANCE OF 33.69 FEET, MORE OR LESS TO THE WEST LINE OF SAID LOT 1, AND THE TERMINUS OF THE HEREIN DESCRIBED LINE;

TOGETHER WITH SECOND CLASS SHORELANDS ADJOINING THEREOF;

(ALSO KNOWN AS LOT 1 OF CITY OF MERCER ISLAND LOT LINE ADJUSTMENT NUMBER SUB01-009, RECORDED UNDER RECORDING NUMBER 20021125900027).

### PARCEL B:

A NON-EXCLUSIVE EASEMENT FOR INGRESS AND EGRESS OVER THAT PORTION OF THE WEST 15 FEET OF THE EAST 60.44 FEET OF SAID GOVERNMENT LOT 5, SECTION 7, TOWNSHIP 24 NORTH, RANGE 5 EAST, WILLAMETTE MERIDIAN IN KING COUNTY, WASHINGTON, LYING SOUTHERLY OF SAID PROPOSED NORTHERLY RIGHT OF WAY LINE OF RELOCATED NORTH MERCER WAY.

SITUATE IN THE CITY OF MERCER ISLAND, COUNTY OF KING, STATE OF WASHINGTON.


## SCHEDULE B

(PER TITLE REPORT PROVIDED BY FIRST AMERICAN TITLE INSURANCE COMPANY, COMMITMENT NO. 4202-2978598, DATED MARCH 14, 2018 AT 7:30 AM)

- EASEMENT, INCLUDING TERMS AND PROVISIONS CONTAINED THEREIN: RECORDED: MAY 05, 1931 RECORDING INFORMATION: 2670081 IN FAVOR OF: PUGET SOUND POWER & LIGHT COMPANY FOR: ELECTRIC TRANSMISSION LINE SURVEYOR'S NOTE: PORTION OF EASEMENT LOCATED OVER SUBJECT PARCEL ABANDONED AND RELEASED BY PARTIAL RELEASE OF EASEMENT RECORDING NUMBER 9906100311, RECORDS OF KING COUNTY RECORDER'S OFFICE.
- EASEMENT, INCLUDING TERMS AND CONDITIONS CONTAINED THEREIN: GRANTED TO: MERCER ISLAND SEWER DISTRICT FOR: SEWER PIPELINE OR LINES AND ALL NECESSARY CONNECTIONS AND APPURTENANCES HERETO RECORDED: JULY 09, 1969 RECORDING INFORMATION: 5179425 AND 5179426 SURVEYOR'S NOTE: THESE ITEMS AFFECT THE PROPERTY, EASEMENT LIES FIVE FEET ON EACH SIDE OF THE SEWER LINE AS CONSTRUCTED, NOT SHOWN ON MAP.
- ANY AND ALL OFFERS OF DEDICATION, CONDITIONS, RESTRICTIONS, EASEMENTS, BOUNDARY DISCREPANCIES OR ENCROACHMENTS, NOTES AND/OR PROVISIONS SHOWN OR DISCLOSED BY WOODSON SHORT SUBDIVISION FILE NO. M-82-11-26 RECORDED UNDER RECORDING NUMBER 8303109004.
- SIDE SEWER EASEMENT, INCLUDING TERMS AND PROVISIONS CONTAINED THEREIN: LOCATION: ALONG THE LINE AS CONSTRUCTED WIDTH: UNDISCLOSED RECORDING NO.: #40480412 SURVEYOR'S NOTE: DOCUMENT PERTAINS TO THE MAINTENANCE OF SEWER FACILITIES LOCATED IN SEWER EASEMENT SHOWN ON MERCER ISLAND SHORT SUBDIVISION RECORDING NUMBER 198303109004, NOT SHOWN ON MAP.
- EASEMENT, INCLUDING TERMS AND PROVISIONS CONTAINED THEREIN: RECORDED: MAY 04, 1984 RECORDING INFORMATION: 840504140 IN FAVOR OF: PUGET SOUND POWER AND LIGHT COMPANY, A WASHINGTON CORPORATION FOR: ELECTRIC TRANSMISSION AND/OR DISTRIBUTION SYSTEM SURVEYOR'S NOTE: THIS ITEM AFFECTS THE PARCEL EASEMENT LIES FIVE FEET ON EACH SIDE OF THE UNDERGROUND POWER LINES AS CONSTRUCTED WITHIN THE WEST 20.00 FEET OF THE PARCEL, NOT SHOWN ON MAP.
- GRANT AND AGREEMENT OF UNDERGROUND UTILITY EASEMENT AND THE TERMS AND CONDITIONS THEREOF: BETWEEN: RALPH E. SEIGEL AND ALICIA A. SEIGEL, HUSBAND AND WIFE AND: JAMES K. LEE AND MIMI D. LEE, HUSBAND AND WIFE RECORDING INFORMATION: 2001119002504 MODIFICATION AND/OR AMENDMENT BY INSTRUMENT: RECORDED: JULY 12, 2005 RECORDING INFORMATION: 20050712000407 SURVEYOR'S NOTE: EASEMENTS SHOWN ON MAP.
- THE TERMS AND PROVISIONS CONTAINED IN THE DOCUMENT ENTITLED "RELINQUISHMENT AND SURRENDER OF EASEMENT RIGHTS AND INTERESTS" RECORDED: NOVEMBER 25, 2002 RECORDING NO.: 20021125900027 SURVEYOR'S NOTE: THIS DOCUMENT RELINQUISHES A PORTION OF THE INGRESS, EGRESS, UTILITIES AND DRAINAGE EASEMENT SHOWN OVER THE EASTERLY PORTION OF LOT 1 OF CITY OF MERCER ISLAND SHORT PLAT, RECORDING NUMBER 198303109004.

## SURVEYOR'S NOTES

- THE PURPOSE OF THIS SURVEY IS TO DETERMINE THE LOCATION OF THE BOUNDARIES AND PROVIDE TOPOGRAPHIC INFORMATION OF THE PARCEL AS DESCRIBED HEREON.
- THIS SURVEY WAS MADE BY FIELD TRAVERSE USING A LEICA 1203 3" ROBOTIC TOTAL STATION AND DS14RTK GPS WITH RESULTING CLOSURES EXCEEDING THE MINIMUM ACCURACY STANDARDS AS SET FORTH BY WAC 332-130.
- THE BOUNDARY CORNERS AND LINES DEPICTED ON THIS MAP REPRESENT DEED LINES ONLY. THEY DO NOT PURPORT TO SHOW OWNERSHIP LINES THAT MAY OTHERWISE BE DETERMINED BY A COURT OF LAW.
- THE LEGAL DESCRIPTION IS PER RECORDS OF KING COUNTY RECORDER'S OFFICE, RECORDING NO. 20190419000135, DATED APRIL 19, 2019. A TITLE REPORT HAS NOT BEEN PROVIDED AT THIS TIME. THEREFORE NO INVESTIGATION WAS DONE PERTAINING TO EXISTING ENCUMBRANCES RELATING TO THE SUBJECT PARCEL SHOWN AND DESCRIBED HEREON.
- FIELD WORK FOR THIS PROJECT WAS PERFORMED IN MARCH, 2020 AND IS THEREFORE A REFLECTION OF THE CONDITIONS AT THAT TIME. ALL MONUMENTS WERE VISITED OR SET IN MARCH, 2020. THIS SITE CONTAINS IMPROVEMENTS NOT LOCATED OR SHOWN AS A PART OF THIS SURVEY.
- THIS SURVEY DOES NOT PURPORT TO SHOW ALL EASEMENTS OF RECORD.

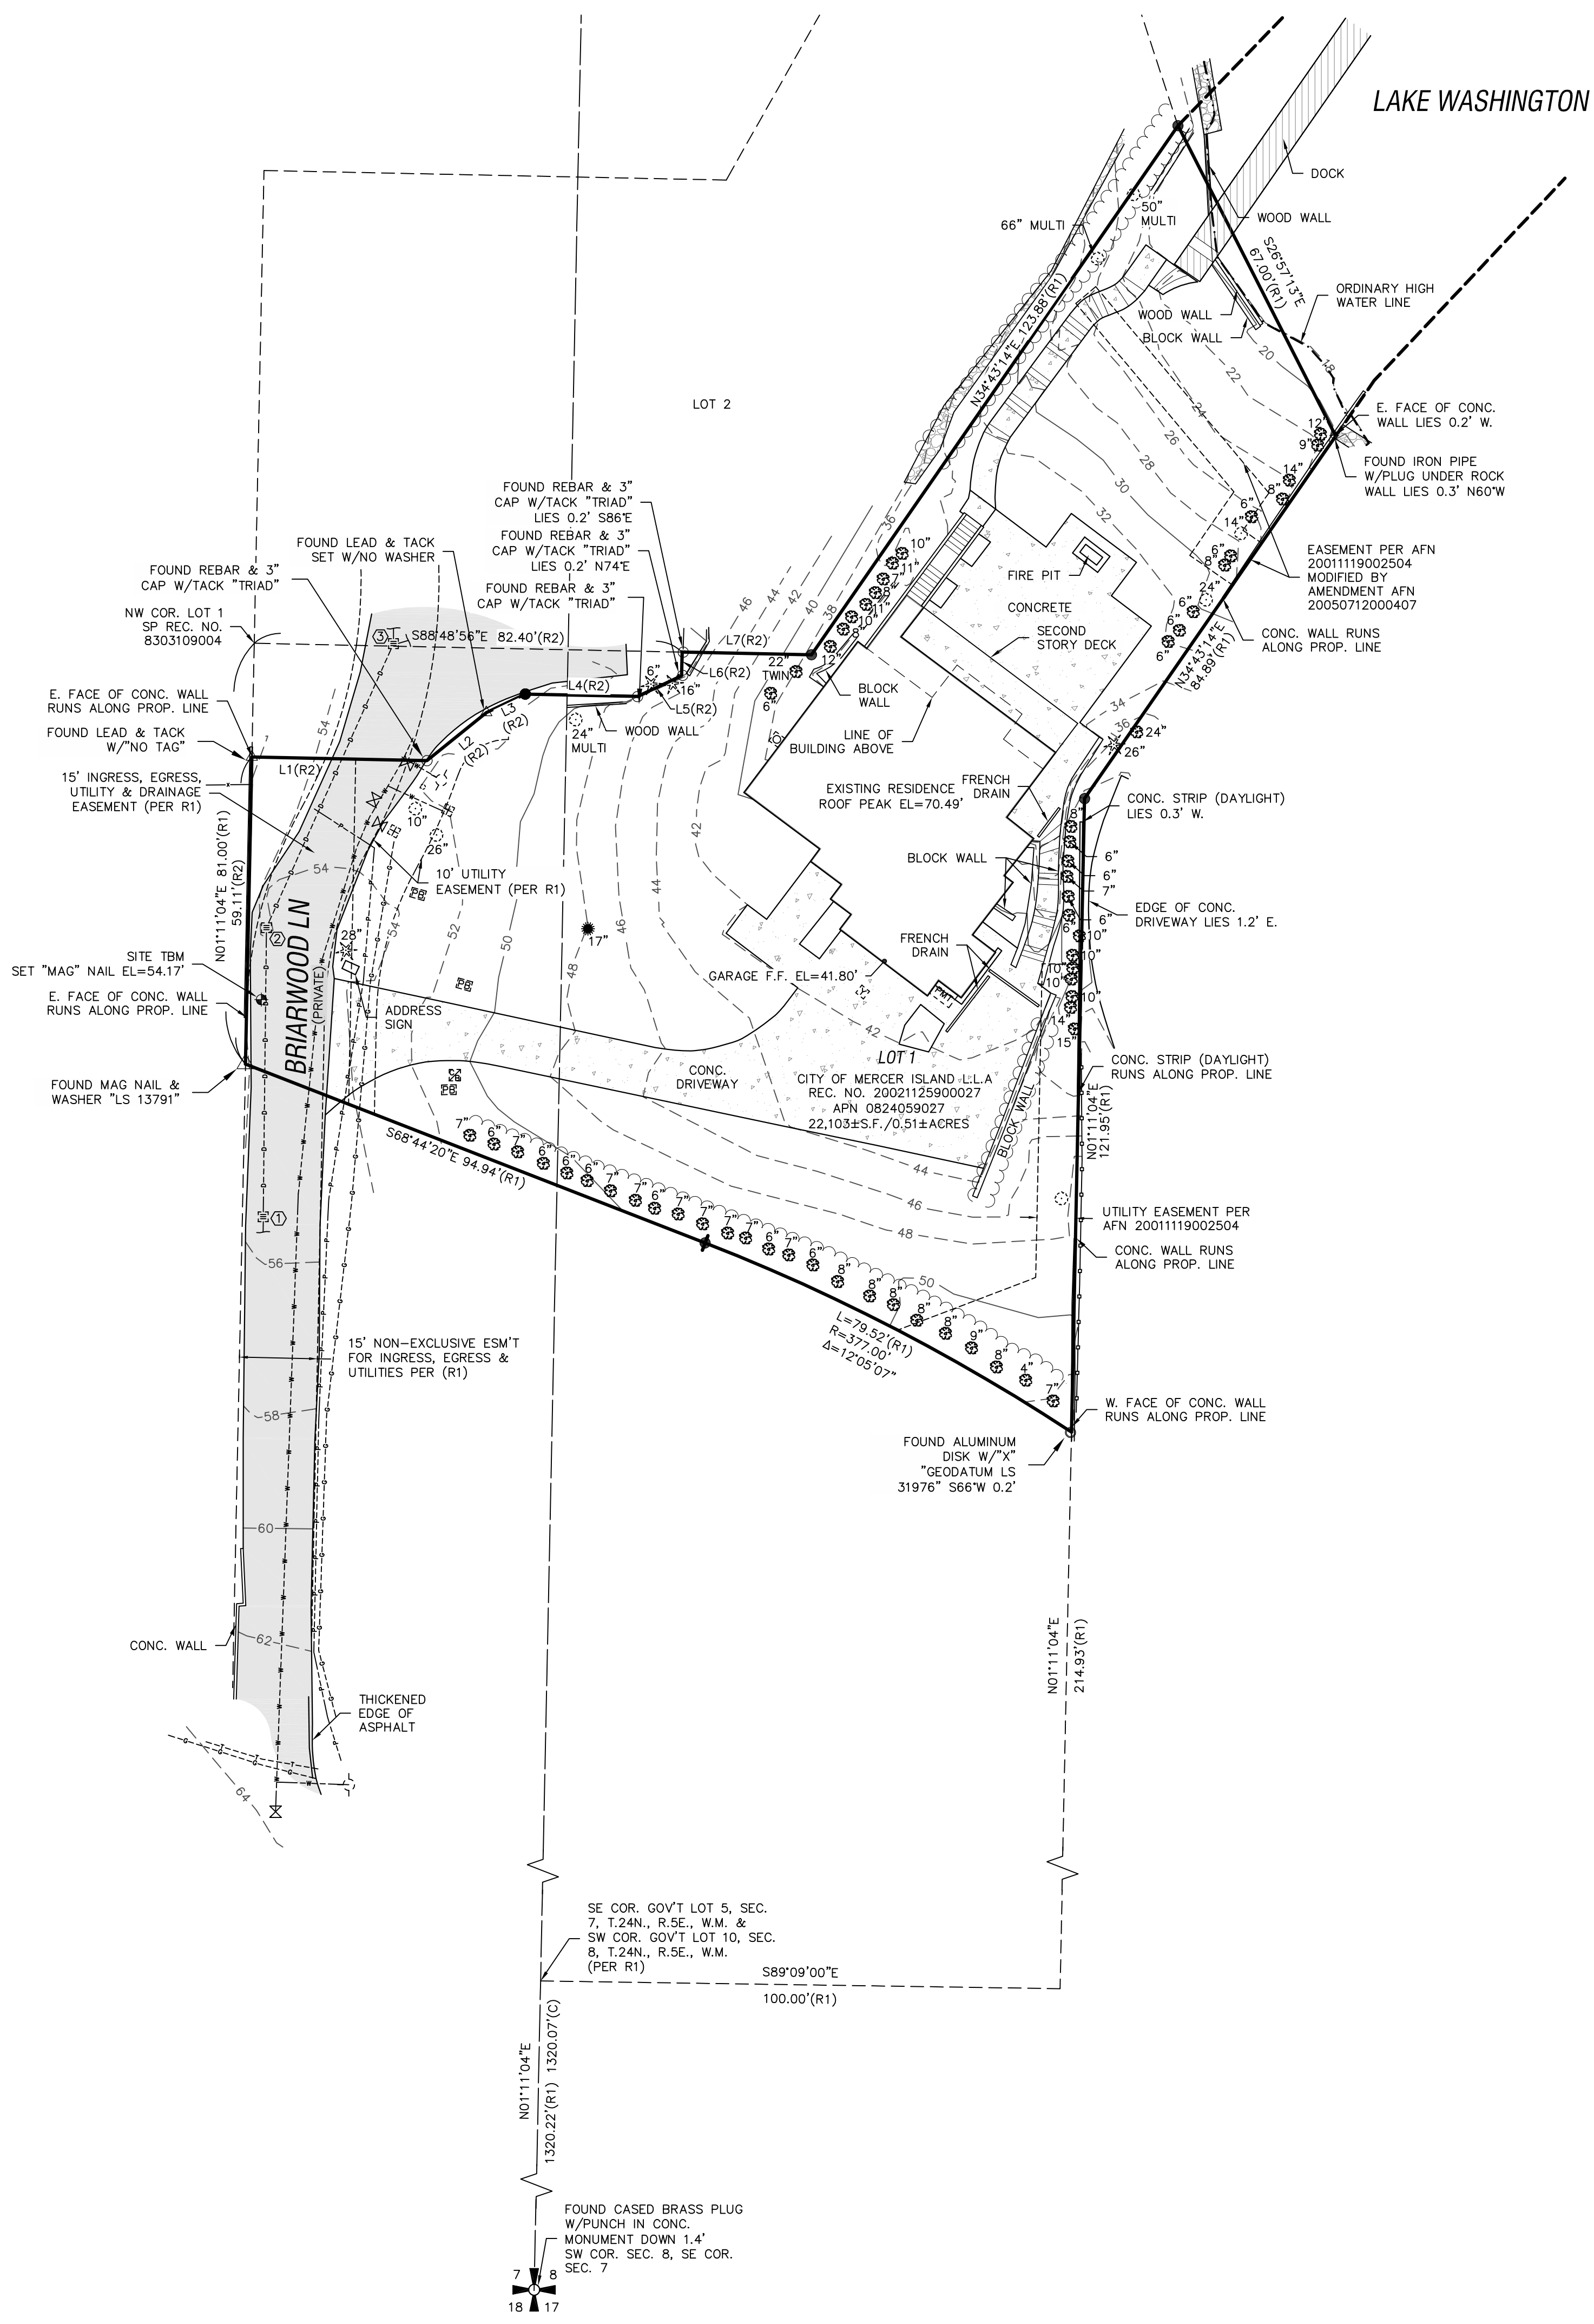

## HORIZONTAL DATUM

NAD 1983(2011); PER RTK GPS TIES AND THE WASHINGTON STATE REFERENCE NETWORK (WSRN). UNITS OF MEASUREMENT ARE U.S. SURVEY FEET.

## VERTICAL DATUM

NAVD 1988 PER RTK GPS TIES AND THE WASHINGTON STATE REFERENCE NETWORK (WSRN). UNITS OF MEASUREMENT ARE U.S. SURVEY FEET.

## REFERENCE SURVEYS

- CITY OF MERCER ISLAND SHORT PLAT, RECORDING NO. 8303109004
- CITY OF MERCER ISLAND LOT LINE ADJUSTMENT, RECORDING NO. 20021125900027

RECORDS OF KING COUNTY RECORDER'S OFFICE

## LEGEND

- ✦ FOUND SECTION CORNER (AS SHOWN)
- SET REBAR & CAP EMW LS #44651
- FOUND REBAR & CAP "TRIAD"
- △ FOUND LEAD W/TACK
- ⊕ FOUND IRON PIPE (AS SHOWN)
- ⊙ SET "MAG" NAIL SITE TEMPORARY BENCHMARK (TBM)
- ⊙ GUARD POST
- ⊙ GAS METER
- ⊙ POWER METER
- ⊙ POWER PULL BOX
- ⊙ STORM DRAIN CATCH BASIN
- ⊙ YARD DRAIN
- ⊙ SEWER MANHOLE
- ⊙ IRRIGATION CONTROL BOX
- ⊙ FIRE HYDRANT
- ⊙ WATER METER
- ⊙ WATER VALVE
- ⊙ DECIDUOUS TREE
- ⊙ CEDAR TREE
- ⊙ EVERGREEN TREE
- (R) DISTANCE PER REFERENCE
- (L) DISTANCE AS CALCULATED
- LS LICENSED LAND SURVEYOR
- ASPHALT SURFACE
- CONCRETE SURFACE
- ROCKERY

## LINE TYPE LEGEND

- WOOD FENCE
- GAS LINE
- STORM DRAIN LINE
- EDGE OF VEGETATION
- POWER LINE
- WATER LINE
- ORDINARY HIGH WATER LINE

## STORM DRAIN STRUCTURE TABLE

- CATCH BASIN  
RIM EL=53.39'  
(W) 10" DI I.E.=51.19'  
(N) 10" DI I.E.=50.99'
- CATCH BASIN  
RIM EL=53.94'  
(S) 10" DI I.E.=49.79'  
(N) 10" DI I.E.=49.59'
- CATCH BASIN  
RIM EL=52.99'  
(N) 12" DI I.E.=48.74'  
(S) 10" DI I.E.=48.99'  
(E) 8" DI I.E.=48.99'

## LINE TABLE

LINE	BEARING	DISTANCE
L1	S88°49'28" E	82.40
L2	S01°10'32" W	4.54
L3	S64°49'53" W	9.36
L4	N88°49'28" W	21.64
L5	S64°21'02" W	8.31
L6	S51°11'48" W	14.70
L7	N88°49'28" W	33.69
L8	S01°11'04" E	1320.07

NOTE:  
THE EXISTING UTILITIES AS SHOWN ARE ONLY APPROXIMATE AND ARE BASED ON THE BEST AVAILABLE INFORMATION. IT SHALL BE THE CONTRACTOR'S RESPONSIBILITY TO VERIFY THE SIZE, TYPE, LOCATION, AND DEPTH OF ALL EXISTING UTILITIES PRIOR TO STARTING CONSTRUCTION AND INFORM THE DESIGN ENGINEER OF ANY DISCREPANCIES.  
Call Before You Dig  
1-800-424-5555

SHT. 1 OF 1

A PORTION OF THE NW 1/4 OF SECTION 8, TOWNSHIP 24N, RANGE 5E, W.M. & NE 1/4 OF THE SE 1/4 OF SECTION 7, TOWNSHIP 24N, RANGE 5E, W.M.

FOR: MARY CHEN

MERCER ISLAND, KING COUNTY, WA

CHECKED: EMW  
JOB NO.: CEMM20024  
FIELD CREW: DM

DRAFTED: JR  
DATE: 9/29/2020  
SCALE: 1"=20'

TOPOGRAPHIC SURVEY

9820 SE 35TH PL  
MERCER ISLAND, WA 98040  
TAX PARCEL NO. 0824059027

informed land survey  
P.O. Box 5137  
Tacoma, WA 98415-0137  
Phone: 252-627-2070  
admin@informedland.com  
www.informedland.com

LAND SURVEYING - MAPPING - CONSTRUCTION LAYOUT



**City of Mercer Island  
Development Services**

9611 SE 36th Street  
Mercer Island, WA 98040  
Inspection Request Line 236-3587  
General Information 236-5300

**BUILDING PERMIT**

**SF ADD**

**Permit No. 9908-047**

**Project No.**

**Main Permit No.**

Site Address: <b>9820 SE 35TH PL</b>	Valuation: <b>84,444.00</b>	Parcel No. <b>824059027</b>
Owner: <b>SIEGEL RALPH E+ALICIA A</b>	Description of Work: <b>1110 SF ADDITION TO EXISTING HOME &amp; REMODEL</b>	
Mailing Address: <b>9820 SE 35TH PL Mercer Island WA 98040</b>		
Phone: <b>(206)232-1127</b>		

**Legal Description**

Lot:	Block:	Plat:
------	--------	-------

Contractor: <b>MILLER &amp; MILLER</b>	Address:
Phone: <b>(425)644-2253</b>	State Contractor Lic: <b>MILLEMC0550L</b> MI Business Lic#:

Type of Const.: <b>BUILDING</b>	Occ Load:	No. Stories: <b>0.00</b>	Map Loc.:
---------------------------------	-----------	--------------------------	-----------

Sprinkler Req'd:	Reason:	Building SF: <b>0.00</b>	Decks SF: <b>0.00</b>
Fire Alarm Req'd:	Reason:	Garage SF: <b>0.00</b>	Total SF:

**Associated Permits:**

<b>FEES</b>	<b>Receipt # &amp; Date</b>	<b>Comments</b>
Surcharge	4.50 50738 10/1/1999	
Building Permit Fee	834.15 50738 10/1/1999	
Land Clearing	55.00 50738 10/1/1999	
Energy Code	55.00 50738 10/1/1999	
Plan Check Deposit	632.29 49875 8/6/1999	
	1/1/-4713	
	1/1/-4713	
	1/1/-4713	
	1/1/-4713	
	1/1/-4713	
	1/1/-4713	
<b>TOTAL FEE</b>	<b>\$ 1,580.94</b>	
<b>TOTAL FEES PAID</b>	<b>\$ 1,580.94</b>	
<b>TOTAL FEES DUE</b>	<b>\$ 0.00</b>	

Permit expires if work is not commenced within 180 days or ceases for more than 180 days. The City of Mercer Island is not responsible for reviewing the applicability of private covenants to this permit. Compliance with private plat covenants is the sole responsibility of the applicant/owner.

\_\_\_\_\_  
Signature of Owner/Contractor/Authorized Agent

\_\_\_\_\_  
Date

**FILE COPY**

**Project No.**  
**Main Permit No.**  
**Permit No. 9908-047**





**City of Mercer Island  
Development Services**

9611 SE 36th Street  
Mercer Island, WA 98040  
Inspection Request Line 236-3587  
General Information 236-5300

**BUILDING PERMIT**

**SF ADD**

**Permit No. 9908-047**

**Project No.**

**Main Permit No.**

Site Address: <b>9820 SE 35TH PL</b>	Valuation: <b>84,444.00</b>	Parcel No. <b>824059027</b>
Owner: <b>SIEGEL RALPH E+ALICIA A</b>	Description of Work: <b>REVISION 11/15/99</b>	
Mailing Address: <b>9820 SE 35TH PL Mercer Island WA 98040</b>		
Phone: <b>(206)232-1127</b>		

**Legal Description**

Lot:	Block:	Plat:
------	--------	-------

Contractor: <b>MILLER &amp; MILLER</b>	Address:
Phone: <b>(425)644-2253</b>	State Contractor Lic: <b>MILLEMC0550L</b> MI Business Lic#:

Type of Const.: <b>BUILDING</b>	Occ Load:	No. Stories: <b>0.00</b>	Map Loc.:
Sprinkler Req'd:	Reason:	Building SF: <b>0.00</b>	Decks SF: <b>0.00</b>
Fire Alarm Req'd:	Reason:	Garage SF: <b>0.00</b>	Total SF:

**Associated Permits:**

FEES		Receipt # & Date		Comments
Surcharge	4.50	50738	10/1/99	
Building Permit Fee	834.15	50738	10/1/99	
Land Clearing	55.00	50738	10/1/99	
Energy Code	55.00	50738	10/1/99	
Plan Check Deposit	632.29	49875	8/6/99	
Bldg. Revision Fee	47.00	51430	11/15/99	
Bldg. Revision Fee	150.00	51814	12/8/99	
<b>TOTAL FEE</b>	<b>\$ 1,777.94</b>			
<b>TOTAL FEES PAID</b>	<b>\$ 1,777.94</b>			
<b>TOTAL FEES DUE</b>	<b>\$ 0.00</b>			

Permit expires if work is not commenced within 180 days or ceases for more than 180 days. The City of Mercer Island is not responsible for reviewing the applicability of private covenants to this permit. Compliance with private plat covenants is the sole responsibility of the applicant/owner.

Signature of Owner/Contractor/Authorized Agent

12-8-99  
Date

**FILE COPY**

**Project No.**  
**Main Permit No.**  
**Permit No. 9908-047**



**EASEMENTS:**

- EASEMENT AND THE TERMS AND CONDITIONS THEREOF:**  
 GRANTEE: PUGET SOUND POWER & LIGHT COMPANY  
 PURPOSE: ELECTRIC TRANSMISSION LINE  
 AREA AFFECTED: THE EAST 10 FEET OF THE WEST 100 FEET OF GOVERNMENT LOT 10, SECTION 8, TOWNSHIP 24 NORTH, RANGE 5 EAST, W.M. MAY 5, 1931  
 RECORDED: MAY 5, 1931  
 RECORDING NUMBER: 2670081
- EASEMENT AND THE TERMS AND CONDITIONS THEREOF:**  
 GRANTEE: MERCER ISLAND SEWER DISTRICT  
 PURPOSE: SEWER PIPELINE OR LINES AND ALL NECESSARY CONNECTIONS AND APPURTENANCES HERETO  
 AREA AFFECTED: AS CONSTRUCTED OVER SECOND CLASS SHORELANDS ADJOINING THAT PORTION OF SAID PREMISES LYING IN GOVERNMENT LOT 10  
 RECORDED: JULY 8, 1960  
 RECORDING NUMBER: 5179425
- EASEMENT AND THE TERMS AND CONDITIONS THEREOF:**  
 GRANTEE: PUGET SOUND POWER & LIGHT COMPANY  
 PURPOSE: ELECTRIC TRANSMISSION AND/OR DISTRIBUTION SYSTEM  
 AREA AFFECTED: A 10 FOOT STRIP WITHIN THE WEST 20 FEET OF LOT 1  
 RECORDED: MAY 4, 1984  
 RECORDING NUMBER: 8405041140
- EASEMENT PROVISIONS AND THE TERMS AND CONDITIONS THEREOF CONTAINED IN MERCER ISLAND SHORT PLAT NUMBER 82-11-26 UNDER RECORDING NUMBER 8303109004:**  
 PURPOSE: INGRESS AND EGRESS, UTILITIES AND DRAINAGE  
 AREA AFFECTED: 15 FEET WIDE AS DELINEATED ON SAID SHORT PLAT (NOT PLOTTABLE)
- EASEMENT PROVISIONS AND THE TERMS AND CONDITIONS THEREOF CONTAINED IN MERCER ISLAND SHORT PLAT NUMBER 82-11-26 UNDER RECORDING NUMBER 8303109004:**  
 PURPOSE: UTILITIES  
 AREA AFFECTED: 10 FEET WIDE LYING SOUTHERLY AND EASTERLY OF THE 15 FOOT WIDE EASEMENT EASEMENT
- EASEMENT PROVISIONS AND THE TERMS AND CONDITIONS THEREOF CONTAINED IN MERCER ISLAND SHORT PLAT NUMBER 82-11-26 UNDER RECORDING NUMBER 8303109004:**  
 PURPOSE: UTILITIES  
 AREA AFFECTED: 10 FEET WIDE LYING SOUTHERLY AND EASTERLY OF THE 15 FOOT WIDE EASEMENT EASEMENT

EASEMENT ABANDONED  
 RECORDING # 8303109004  
 6-3-99

**UNDERGROUND UTILITIES:**  
 Locate all utilities prior to any excavation. Do not build over the side sewer.

- SEPARATE PERMIT REQUIRED FOR:**
- Side Sewer
  - Water Meter
  - Street Use
  - Rockery/Retaining Wall
  - Grading
  - Other

**LEGAL DESCRIPTION:**

LOT 1, CITY OF MERCER ISLAND SHORT PLAT NUMBER 82-11-26, RECORDED UNDER RECORDING NUMBER 8303109004, IN KING COUNTY, WASHINGTON, SAID SHORT PLAT DESCRIBED AS FOLLOWS:

BEGINNING AT THE SOUTHEAST CORNER OF LOT 5, SECTION 7, TOWNSHIP 24 NORTH, RANGE 5 EAST, WILLAMETTE MERIDIAN, IN KING COUNTY, WASHINGTON; THENCE WEST ALONG THE SOUTH LINE OF LOT 5, 60.44 FEET; THENCE NORTH PARALLEL WITH THE EAST LINE OF SAID LOT 5 TO THE GOVERNMENT MEANDER LINE ON THE SHORE OF LAKE WASHINGTON; THENCE ALONG SAID MEANDER LINE IN AN EASTERLY DIRECTION TO THE POINT OF INTERSECTION WITH THE EAST LINE OF SAID LOT 5; THENCE SOUTH ALONG THE EAST LINE OF SAID LOT 5 TO THE POINT OF BEGINNING; TOGETHER WITH SECOND CLASS SHORE LANDS ADJOINING;

AND THAT PORTION OF GOVERNMENT LOT 10, SECTION 8, TOWNSHIP 24 NORTH, RANGE 5 EAST, WILLAMETTE MERIDIAN, IN KING COUNTY, WASHINGTON AND OF THE SHORE LANDS APPURTENANT THERETO LYING WESTERLY AND NORTHWESTERLY OF THE FOLLOWING DESCRIBED LINE:



BEGINNING AT AN IRON PIPE ON THE SOUTH LINE OF SAID GOVERNMENT LOT 10, A DISTANCE 45°05' EAST 100.00 FEET FROM THE SOUTHWEST CORNER OF SAID GOVERNMENT LOT; \* NORTH 89°05'09" EAST PARALLEL WITH THE WEST LINE OF SAID LOT AND \* AND RUNNING THENCE NORTH 0°37'19" \* 100.00 FEET DISTANCE THEREFROM 336.88 FEET TO AN IRON PIPE; THENCE NORTH 33°13'16" EAST AT RIGHT ANGLES TO THE \* EAST 97.89 FEET TO AN IRON PIPE; THENCE NORTH 42° MEANDER LINE IN SAID LOT TO THE OUTER BOUNDARY OF THE LAKE WASHINGTON SHORE LAND; EXCEPT THAT PORTION THEREOF LYING SOUTHERLY OF THE PROPOSED NORTHERLY RIGHT OF WAY LINE OF RELOCATED NORTH MERCER WAY, SAID LINE BEING 35 FEET NORTHERLY WHEN MEASURED AT RIGHT ANGLES AND/OR RADIALLY FROM THE SURVEY LINE OF RELOCATED NORTH MERCER WAY OF PRIMARY STATE HIGHWAY NUMBER 2 (SR90), WEST SHORE OF MERCER ISLAND TO EAST CHANNEL BRIDGE, SAID PROPOSED NORTHERLY RIGHT OF WAY LINE BEING MORE PARTICULARLY DESCRIBED AS FOLLOWS:

COMMENCING AT THE SOUTHEAST CORNER OF SAID GOVERNMENT LOT 5; THENCE WESTERLY 05°09' \* ALONG THE SOUTH LINE OF LOT 5 FOR A DISTANCE OF 60.44 FEET; THENCE NORTH 0° EAST PARALLEL WITH THE EAST LINE OF SAID LOT 5 FOR A DISTANCE OF 470.00 FEET, MORE OR LESS, TO AN INTERSECTION WITH THE WESTERLY EXTENSION OF A LINE OF CONCRETE MONUMENTS AS ESTABLISHED BY JONES, BASSI & ASSOCIATES, ENGINEERS AND SURVEYORS, 08°28' EAST AND SAID MONUMENT \* THE BEARING OF SAID MONUMENT LINE BEING NORTH 63° 08'28" EAST 41 FEET DISTANT, MORE OR LESS, AND NORTH 63° \* BEING LOCATED NORTH 63° 08'28" EAST 142 FEET DISTANT, MORE OR LESS, ALONG SAID MONUMENT LINE FROM SAID 05°09' WEST 185.51 FEET TO AN INTERSECTION WITH SAID \* INTERSECTION; THENCE SOUTH 0° 47'07" EAST ALONG SAID \* PROPOSED NORTHERLY RIGHT OF WAY LINE; THENCE SOUTH 69° PROPOSED NORTHERLY RIGHT OF WAY LINE 84.94 FEET TO A POINT OF CURVATURE TO THE RIGHT; THENCE ALONG THE ARC OF SAID CURVE HAVING A RADIUS OF 377 FEET TO AN INTERSECTION WITH THE EASTERLY LINE OF THE FOREGOING DESCRIBED TRACT;

TOGETHER WITH AN NON-EXCLUSIVE EASEMENT FOR INGRESS, EGRESS AND UTILITIES OVER AND ACROSS AND UNDER THAT PORTION OF THE WEST 15 FEET OF THE EAST 60.44 FEET OF SAID GOVERNMENT LOT 5, LYING SOUTHERLY OF SAID PROPOSED NORTHERLY RIGHT OF WAY LINE OF RELOCATED NORTH MERCER WAY AS DESCRIBED ABOVE.

**TEMPORARY EROSION/SEDIMENTATION CONTROL NOTES:**

- ALL REQUIRED SEDIMENTATION / EROSION CONTROL FACILITIES MUST BE CONSTRUCTED AND IN OPERATION AND INSPECTED BY CITY (IF REQUIRED) PRIOR TO LAND CLEARING, EXCAVATION, AND/OR OTHER CONSTRUCTION TO INSURE THAT SEDIMENT-LADEN WATER DOES NOT ENTER THE NATURAL DRAINAGE SYSTEM. ALL EROSION AND SEDIMENT CONTROL FACILITIES SHALL BE MAINTAINED IN A SATISFACTORY CONDITION UNTIL SUCH TIME THAT CLEARING AND/OR CONSTRUCTION IS COMPLETED AND THE POTENTIAL FOR ON-SITE EROSION HAS PASSED. THE IMPLEMENTATION, MAINTENANCE, REPLACEMENT AND ADDITIONS TO THE EROSION/SEDIMENTATION CONTROL SYSTEMS SHALL BE THE RESPONSIBILITY OF THE CONTRACTOR. REMOVE ALL TEMPORARY EROSION CONTROL FACILITIES ONLY WHEN GRADING AND BACKFILL ARE COMPLETE AND WITH THE CITY INSPECTOR'S APPROVAL.
- THE EROSION CONTROL FACILITIES DEPICTED ON THIS DRAWING ARE INTENDED TO BE MINIMUM REQUIREMENTS TO MEET ANTICIPATED SITE CONDITIONS. AS CONSTRUCTION PROGRESSES AND UNEXPECTED OR SEASONAL CONDITIONS DICTATE, THE CONTRACTOR SHOULD ANTICIPATE THAT MORE EROSION AND SEDIMENTATION CONTROL FACILITIES WILL BE NECESSARY TO INSURE COMPLETED SILTATION CONTROL ON THE PROPOSED SITE. DURING THE COURSE OF CONSTRUCTION, IT SHALL BE THE OBLIGATION AND RESPONSIBILITY OF THE CONTRACTOR TO ADDRESS ANY NEW CONDITIONS THAT MAY BE NEEDED TO PROTECT ADJACENT PROPERTIES AND WATER QUALITY OF THE RECEIVING DRAINAGE SYSTEM.
- ANY AREA WHICH HAS BEEN STRIPPED OF VEGETATION AND WHERE NO FUTURE WORK IS ANTICIPATED FOR A PERIOD OF FIVE DAYS OR MORE SHALL BE IMMEDIATELY STABILIZED WITH 2 INCHES OF STRAW MULCHING, GRASS PLANTING OR OTHER APPROVED EROSION CONTROL TREATMENT WHERE APPLICABLE TO THE TIME OF YEAR IN QUESTION.
- ALL SPOILS PILES SHALL BE COVERED WITH PLASTIC SHEETING.
- T.E.S.C. FACILITIES MUST BE IN PLACE PRIOR TO DEMOLITION, CLEARING, GRADING, ETC. EROSION CONTROL FACILITIES SHALL BE MAINTAINED UNTIL FINAL LANDSCAPING IS COMPLETED.

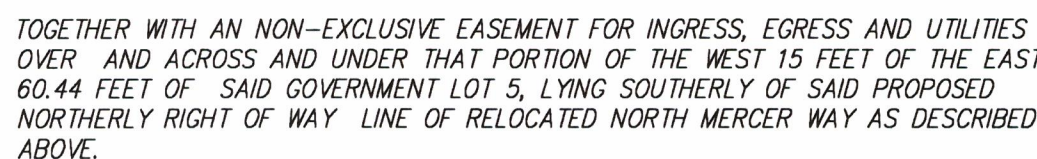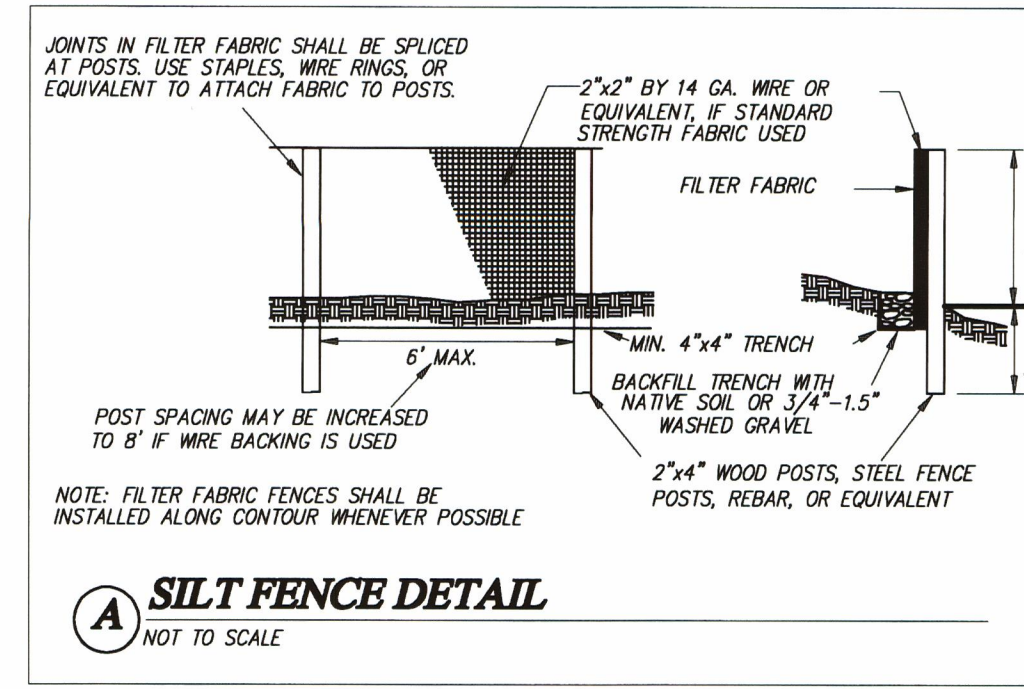

**SILT FENCE:** Clean and provide regular maintenance of the silt fence. The fence is to remain vertical and is to function properly throughout the term of the project.

FROM MERCER ISLAND ENGINEERING DEPARTMENT  
 Approved for storm drainage  
 No description taken  
 No exception taken with revisions as noted.  
 Plans and Resubmit  
 By: T. J. J. Date: 9/4/99

**S I T E P L A N**

1" = 10' - 0"

**BUILDING HEIGHT CALCULATIONS:**

POINT A:	30.5'	POINT E:	31.0'
POINT B:	28.0'	POINT F:	31.5'
POINT C:	23.0'	POINT G:	31.5'
POINT D:	27.75'		

SUM OF BUILDING CORNER ELEVATIONS: 203.25'  
 BASE ELEVATION = SUM OF CORNER ELEV. PTS. / NUMBER OF POINTS: 29.0'  
 (203.25' / 7 POINTS = 29'-0")

ALLOWABLE MAXIMUM BUILDING HEIGHT: 59'-0"  
 (27'-10" + 3'-0" = 57'-10")

PROPOSED MAXIMUM BUILDING HEIGHT: 59' - 8"  
 (NOTE: THIS IS THE ELEVATION OF THE EXISTING MAIN ROOF RIDGE OF THE EXISTING STRUCTURE.)

**LOT COVERAGE:**

GROSS LOT AREA:	23,350 S.F.
MAIN STRUCTURE ROOF AREA:	2,360 S.F.
EXISTING:	1805 S.F.
NEW:	555 S.F.
ACCESSORY BUILDING ROOF AREA:	N/A
IMPERVIOUS DECK AREA:	700 S.F.
EXISTING:	160 S.F.
DEMOLISHED:	175 S.F.
NEW:	540 S.F.
DRIVEWAY, WALKWAY, PATIO AREA:	5,400 S.F.
EXISTING:	4570 S.F.
NEW:	830 S.F.
TOTAL IMPERVIOUS SURFACE AREA:	8,460 S.F.
PROPOSED SITE COVERAGE:	36.2 %
ALLOWED SITE COVERAGE:	40.0 %
LOT SLOPE < 15%, 23,350 x .40 = 9,340 S.F.)	

**GROSS FLOOR AREA CALCULATIONS:**

NET LOT AREA:	21,700 S.F.
(TOTAL LOT AREA LESS INGRESS/EGRESS EASEMENTS)	(23,350 S.F. - 1650 S.F. = 21,700 S.F.)
ALLOWABLE GROSS FLOOR AREA:	9,765 S.F.
(NET LOT AREA X 45%)	
PROPOSED GROSS FLOOR AREA:	5,275 S.F.
PROPOSED PERCENTAGE OF LOT AREA:	24.3 %



**LOT SLOPE CALCULATIONS:**

HIGHEST ELEVATION POINT OF LOT:	
LOWEST ELEVATION POINT OF LOT:	42'
ELEVATION DIFFERENCE:	10'
HORIZONTAL DISTANCE BETWEEN HIGH & LOW POINTS:	220' - 0"
LOT SLOPE:	14.5 %

**WATER SERVICE**

METER SIZE 1"  
 WATER SUPPLY LINE 1 1/2"

Check existing in field  
 Possible Upsize needed

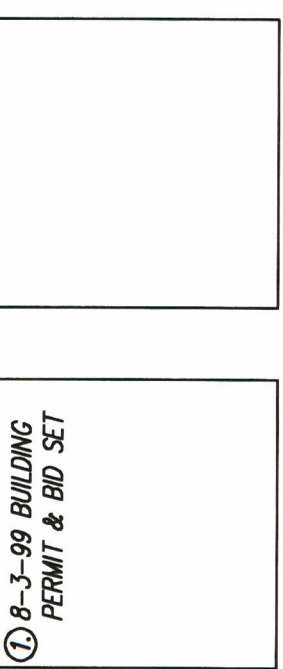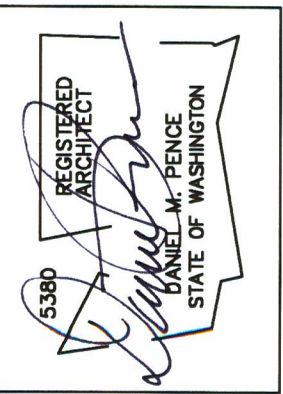

**The Pence Associates**  
 ARCHITECTS  
 2208 25th Street S.E.  
 Everett, Washington 98021  
 Phone (206) 915-8822  
 Fax: (425) 886-9467

**Siegel Residence**  
 Mercer Island, Washington

**Site Plan**

August 3, 1999

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